

(SUBDIVISION NAME) TOWNHOMES



5-UNIT PRESIDENTIAL TH (60' SERIES)


(TRUMAN, KENNEDY, WASHINGTON, CARTER-REV., TRUMAN-REV.)

PAD SIZE 112'-0"x 60'-0"

SHEET INDEX: FIRST FLOOR OVERALL SECOND FLOOR OVERALL SECOND FLOOR OVERALL (OPT. BDRM.#4) FLOOR PLANS (TRUMAN) FLOOR PLANS (KENNEDY) FLOOR PLANS (WASHINGTON) FLOOR PLANS (CARTER) FLOOR PLANS (TRUMAN-REV.) FRONT & REAR ELEVATIONS LEFT & RIGHT ELEVATIONS A11 BUILDING SECTION & ROOF LAYOUT **SECTIONS: TRUMAN & WASHINGTON** SECTIONS: CARTER & KENNEDY ELECTRICAL LAYOUT (TRUMAN) ELECTRICAL LAYOUT (KENNEDY) ELECTRICAL LAYOUT (WASHINGTON) ELECTRICAL LAYOUT (CARTER) ELECTRICAL LAYOUT (TRUMAN-REV.)

REVISION SCHEDULE:

DATE:	DESCRIPTION:	BY:
	DATE:	DATE: DESCRIPTION: DATE:

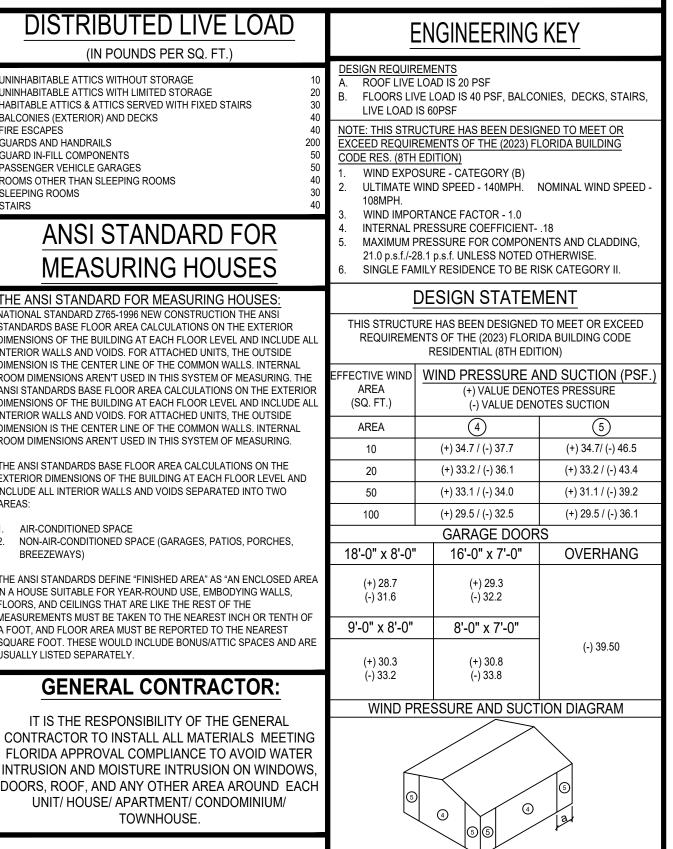

GENERAL PRESSURE NOTES

"a" END ZONE IS ONLY WITHIN 5'-0" OF ALL EXTERIOR

(FBC) 2023 (8TH EDITION)

2023 FLORIDA BUILDING CODE (MECHANICAL) - 8TH EDITION

2023 FLORIDA BUILDING CODE (ACCESSIBILITY) 8TH EDITION. 2023 FLORIDA BUILDING CODE (ENERGY CONSERVATION) 8TH

2023 FLORIDA BUILDING CODE (EXISTING BUILDING) 8TH

2020 FLORIDA FIRE PREVENTION CODE (7TH EDITION).

OCCUPANCY CLASSIFICATION: GROUP R-3 (TOWNHOMES)

ECIFIC PARAMETERS FROM FBC 2023 USED FOR DESIGN

CONSTRUCTION WOOD FRAME CONSTRUCTION AMERICAN SOCIETY OF CIVIL ENGINEERS

2020 NATIONAL ELECTRICAL CODE (NEC)

NUMBER OF STORIES: 2 STORIES

CONCRETE MASONRY RESIDENTIAL


CONSTRUCTION TYPE: TYPE VB (FBC-R 602.3)

INDICATED PRESSURES CAN BE INTERPOLATED FOR OTHER

| Color | Colo

COVER PAGE

GOBA

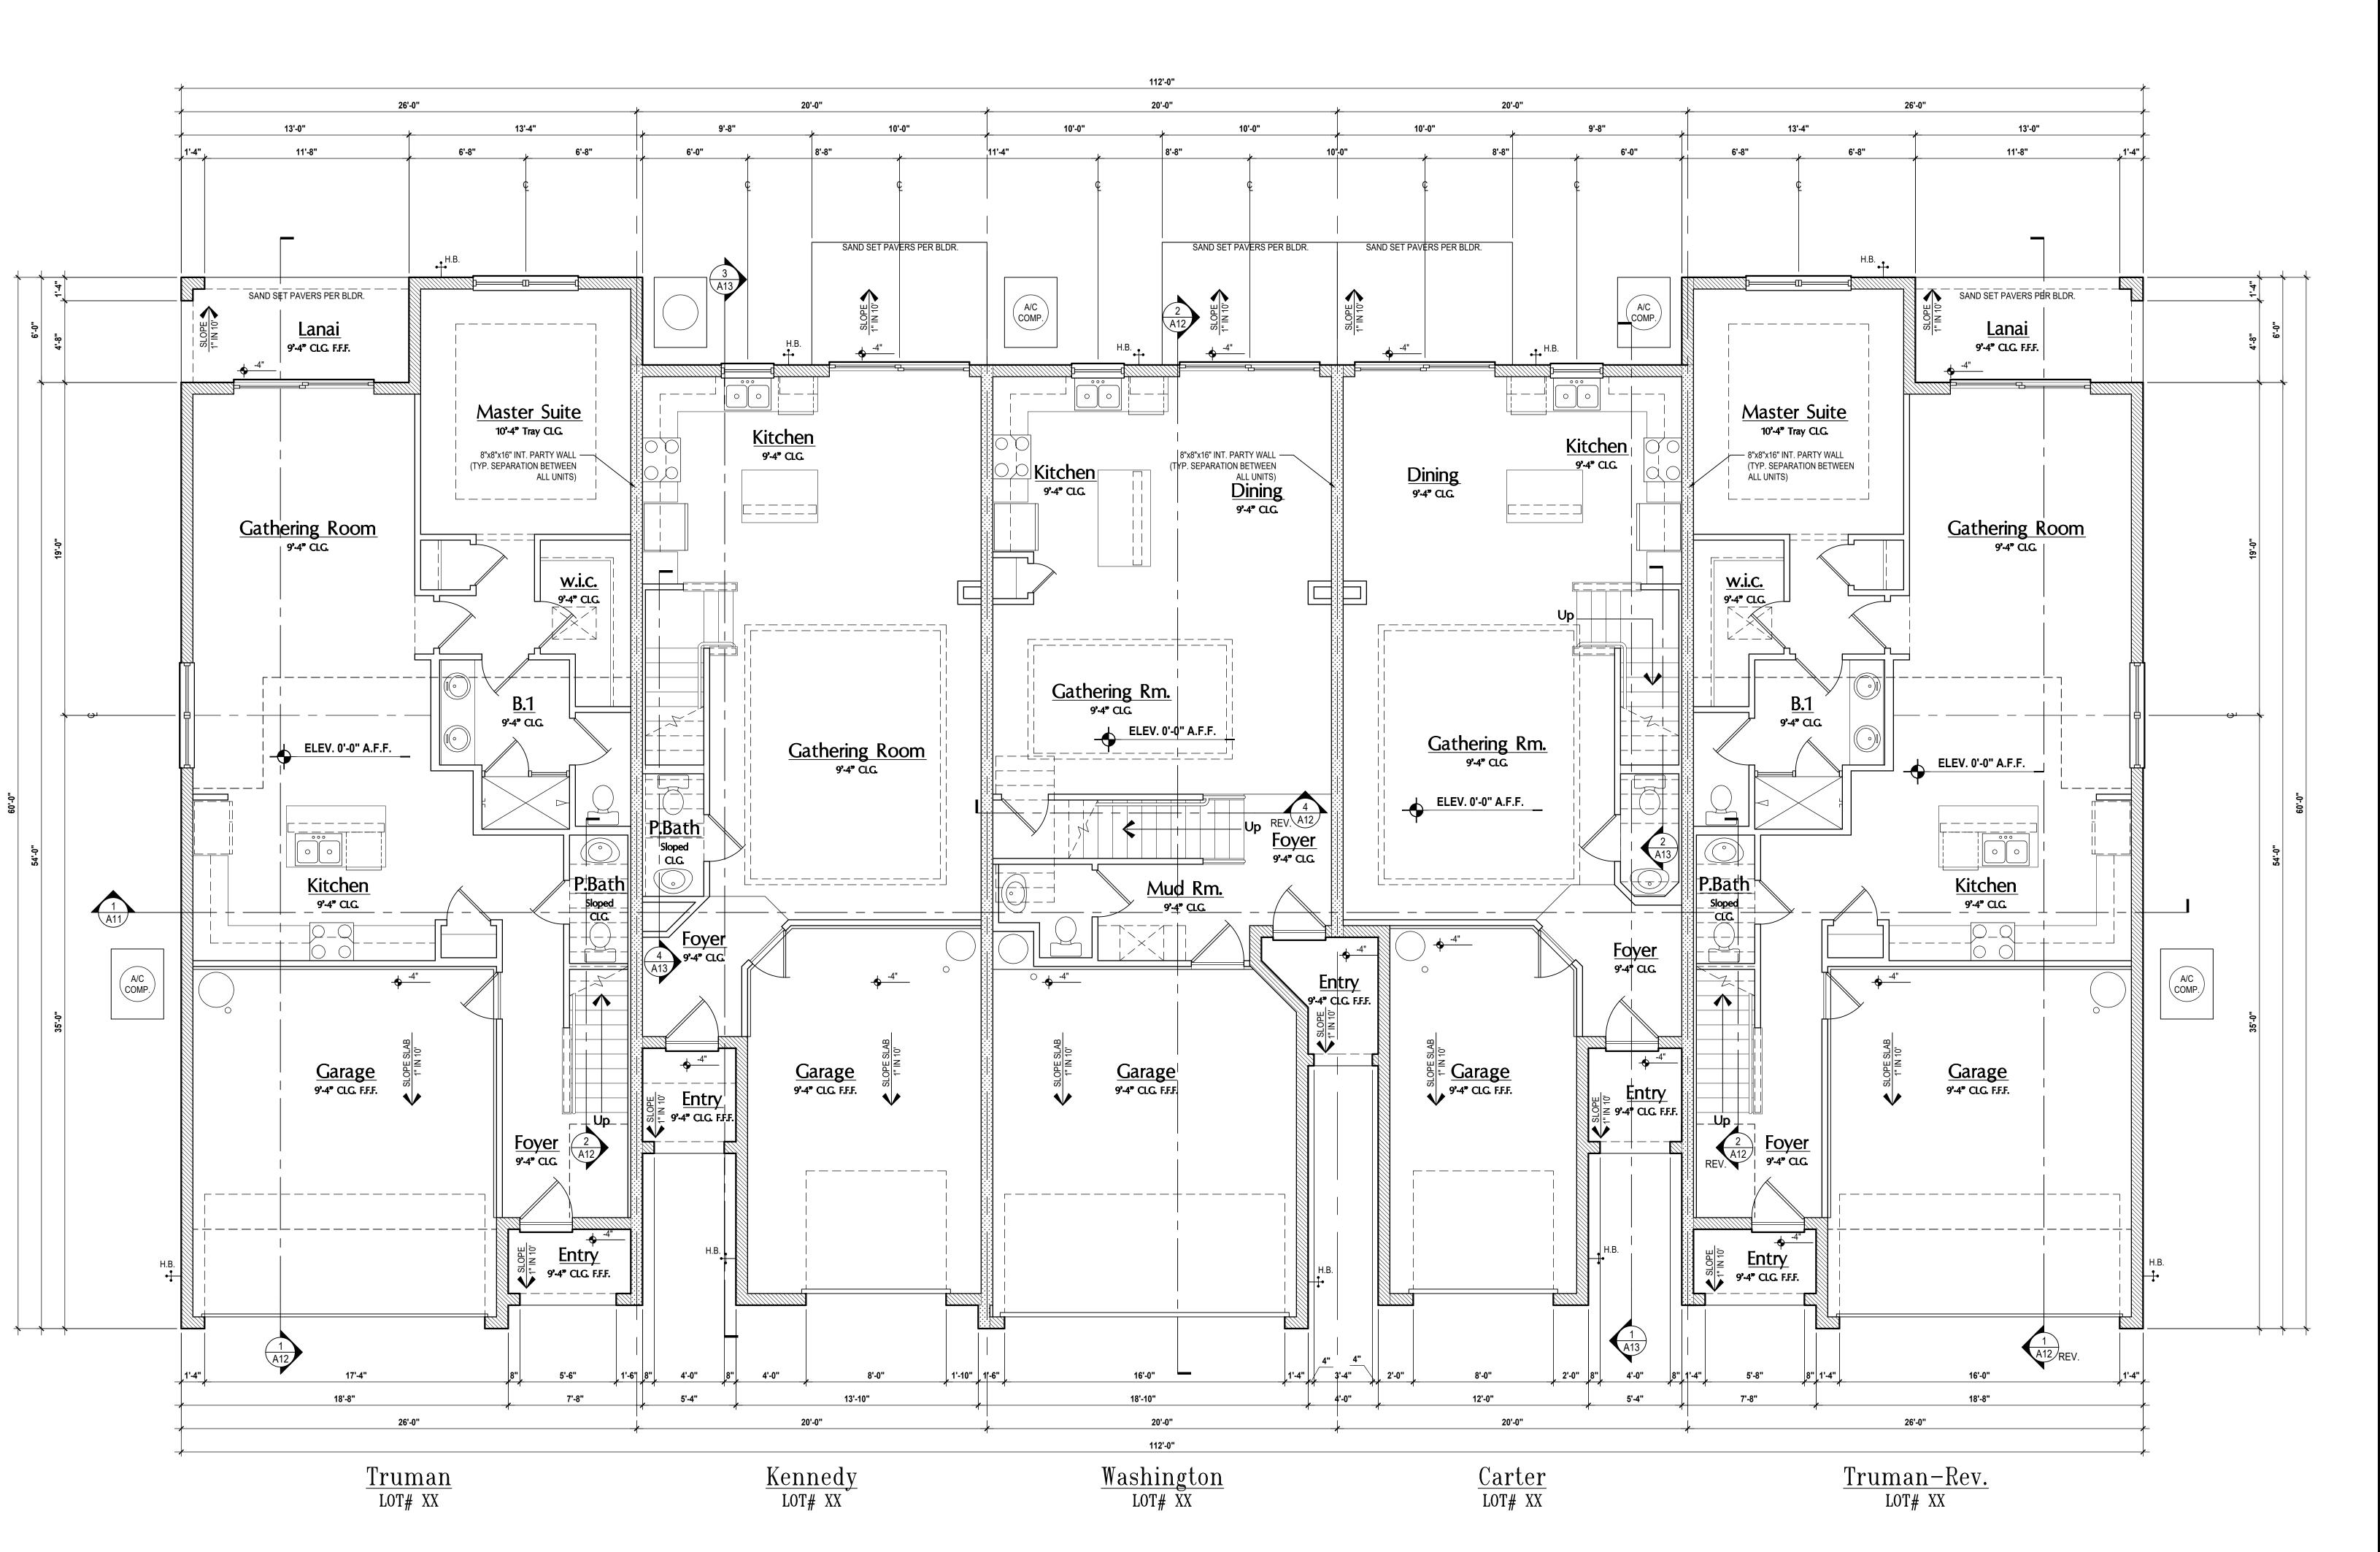

GENERAL NOTES KEY:

ABBREVIATIONS:

MT - METAL THRESHOLD
FR - FRENCH DOORS
SL - SIDE LIGHT
FG - FIXED GLASS
TEMP - TEMPERED GLASS
SH - SINGLE HUNG
DH - DOUBLE HUNG
CSMT - CASEMENT
TR - TRANSOM
HR - HORIZONTAL ROLLER
GB - GLASS BLOCK
BP - BYPASS
PKT - POCKET DOOR
BF - BIFOLD

SVC - SERVICE DOOR TYP. - TYPICAL

NOTES:

CONTRACTOR TO VERIFY ALL DIMENSIONS ON JOB SITE.

DO NOT SCALE PRINTS! CONSTRUCTION TO BE FROM

- DO NOT SCALE PRINTS! CONSTRUCTION TO BE FROM CALCULATED DIMENSIONS ONLY. ANY DISCREPANCIES OR ERRORS TO BE REPORTED PROMPTLY TO SUPERVISOR FOR CLARIFICATION.
- CLARIFICATION.

 3. MECHANICAL EQUIP. LOCATIONS WILL BE DETERMINED BY
- COMMUNITY AND COUNTY CODES.

 A/C CONDENSER UNIT TO BE ANCHORED TO SLAB PER CODE
- FBC-R M1307.2 & FBC-M 304, AND SHALL BE SUPPORTED ON CONCRETE SLAB OR OTHER APPROVED MATERIAL NOTE LESS THAN 3" ABOVE ADJOINING GROUND, PER FBC-R M1305.1.4.1
- PROVIDE RECESS H&C WATER W/ DRAIN @ WASHER SPACE.

 VENT DRYER THRU EXTERIOR WALL U.N.O.
- PROVIDE COLD WATER LINE FOR ICE MAKER LINE @ REF. SPACE.
- PROVIDE RECESS H&C WATER W/ DRAIN @ WASHER SPACE.

 SAG RESISTANT DRYWALL ON ALL CEILINGS.
- PULL ALL DIMENSIONS FROM THE REAR OF PLAN.
 REFER TO EXTERIOR ELEVATIONS & TYP. DETAIL SHEETS FO EXTERIOR WALL FINISH SPEC'S.
- EXTERIOR WALL FINISH SPEC'S.

 2. REFER TO DETAIL SHEETS FOR FLASHING REQUIREMENTS AT ALL WOOD TO MASONRY INTERFACES.
- . ALL INTERIOR FRAME WALL DIMENSIONS TO BE 3 $\frac{1}{2}$ " U.N.O.
- 14. ALL EXTERIOR BLOCK WALL DIMENSIONS TO BE 7 $\frac{1}{2}$ " U.N.O. 15. C.M.U. & FRAME WALL SYSTEM SEGMENTS WHICH HAVE AN
- UNINTERRUPTED LENGTH OF 12'-0" OR MORE SHALL BE CONSIDERED SHEAR WALL SWS = SHEAR WALL SEGMENTS.

 16. ENCLOSED SPACE UNDER STAIRS THAT IS ACCESSED BY A DOOR OR ACCESS PANEL SHALL HAVE WALLS, UNDER-STAIR
- SURFACE AND ANY SOFFITS PROTECTED ON THE ENCLOSED SIDE WITH 1/2-INCH (12.7 MM) GYPSUM BOARD.

 GARAGE DOOR TO BE CERTIFIED BY MFR. FOR MIN. 150 M.P.H.
- ALL TUB & SHOWER UNITS WILL HAVE ANTI-SCALDING DEVICES INSTALLED.
- ALL OPERABLE WINDOWS LOCATED MORE THAN 72" ABV. SURFACE BELOW SHALL HAVE THE LOWEST PORTION OF WINDOW CLEAR OPENING A MIN. OF 24" ABOVE FINISHED FLOOR BEING SERVER PER (FBC-R312.2).
- REQUIREMENTS.

 21. SPECIALTY WINDOWS/DOORS, FIXED GLASS WINDOWS, AND

SEE COLOR SHEET FOR INTERIOR DOOR HEIGHT

TRANSOMS ARE NOTED ON PLANS.

2. ALL DOORS & WINDOWS THAT ARE EGRESS WILL BE LABELED

MIN.). FILL MATERIAL SHALL BE COMPACTED TO 95% DENSITY OF A STANDARD PROCTOR. TO BE VERIFIED BY GENERAL

- AS SUCH AND CONFORM TO FBC R310.2 EERO

 23. SOIL TESTING IS RECOMMENDED, BUT IS NOT REQUIRED. THE DESIGN TEAM AT MJS & E.O.R STRONGLY RECOMMEND A SOIL TEST TO CONFIRM SOIL BEARING CAPACITY AND SURFACE GEO-TECHNICAL CONDITIONS. FOOTINGS SHALL BEAR ON UNDISTURBED SOIL A/O PROPERLY COMPACTED FILL (2000 PS)
- CONTRACTOR / OWNER.

 24. OPENING BETWEEN GARAGE AND RESIDENCE SHALL BE EQUIPPED WITH A 20 MIN. FIRE RATED SOLID WOOD OR HONEYCOMB CORE STEEL DOOR NOT LESS THAN 1 3/8" THICKNESS AS PER FBC-R302.5.1.
- 1/2" GYPSUM BOARD APPLIED TO THE GARAGE SIDE OF WA UNDERSIDE OF DECKING.
- 6. 5/8" TYPE X DRYWALL ON GARAGE CEILING BELOW ANY HABITABLE SPACE
- HABITABLE SPACE

 7. THERMAL BARRIER: FOAM PLASTIC SHALL BE SEPARATED FROM
 THE INTERIOR OF A BUILDING BY NOT LESS THAN 1/2 INICH (12.7)
- THE INTERIOR OF A BUILDING BY NOT LESS THAN 1/2-INCH (12.7 MM) GYPSUM WALLBOARD, 23/32-INCH (18.2 MM) WOOD STRUCTURAL PANEL OR A MATERIAL THAT IS TESTED IN ACCORDANCE WITH AND MEETS THE ACCEPTANCE CRITERIA OF BOTH THE TEMPERATURE TRANSMISSION FIRE TEST AND THE
- INTEGRITY FIRE TEST OF NFPA 275.

 28. ADDRESS NOTIFICATION SHALL BE IN ACCORDANCE w/ SECTION FBC-R319.
- 29. ANY EXTERIOR WALL ELECTRICAL, MECHANICAL AND PLUMBING PENETRATIONS SHOULD BE FITTED WITH QUICKFLASH PANELS (OR SIMILAR).
 30. ATTIC ACCESS OPENING SHOULD BE WEATHERSTRIPPED AND
- INSULATED TO LEVEL EQUIVALENT TO INSULATION ON THE SURROUNDING AREAS PER FBCEC R402.2.4.

 31. FILL VOIDS OF UNDERSIDE OF TUBS & SHOWERS WITH
- INSULATION FOR ACOUSTIC DAMPENING.32. ADD ACOUSTIC OR VIBRATION ISOLATION DEVICES AT GARAGE DOOR OPENERS THAT ARE ADJACENT TO HABITABLE SPACES
- ABOVE.

 33. WHERE WALL TILE IS INSTALLED IN TUB AND SHOWER AF GLASS MAT GYPSUM BACKING PANELS (ASTM C1178),
- FIBER-REINFORCED GYPSUM PANELS (ASTM C1178),
 FIBER-REINFORCED GYPSUM PANELS (ASTM C1278),
 NON-ASBESTOS FIBER-CEMENT BACKER BOARD (ASTM C1288)
 OR NON-ASBESTOS FIBER MAT REINFORCED CEMENTITIOUS
 BACKER UNITS (ASTM C1325) SHALL BE USED PER FBCR R702.4.
 PAPER-FACED GYPSUM BOARD SHALL NOT BE USED.

WINDOW / DOOR NOTE KEY

WINDOW SIZE CALLOUT 2040 = 2'-0" x 4'-0" 2050 = 2'-0" x 5'-0" 2060 = 2'-0" x 6'-0"

2060 = 2'-0" x 6'-0"

ALL WINDOW CALLOUTS ARE MEASURED IN FEET & INCHES
AS PER THE EXAMPLE TABLE ABOVE.

 DOOR SIZE CALLOUT:

 20 = 2'-0"
 40 B.F. = 4'-0" BI-FOLD

 24 = 2'-4"
 50 B.F. = 5'-0" BI-FOLD

 26 = 2'-6"
 60 B.F. = 6'-0" BI-FOLD

30 = 3'-0"

ALL INTERIOR DOOR HEIGHTS ARE TO BE DETERMINED BY THE BUILDER.

BRG. HT. LEGEND - INDICRECTON HETE FLUE CENTRY AN 8"

MM. OF 15" LAP ON ALL S	TO BOND BEAM. PROVIDE A
(MIN. REBAR GRADE 60.) 9'-4" BRG. HT.	
+ + + + + + + + + + + + + + + + + + + +	FOUNDATION:
2-HINDTOPETALBERG. WALL	2-STORY BRG. FOOTI
9'-4" BKG: HT	
9'-4" B J RG. HT.	INDICATES 1-HR. FIREV
PER PLAN	NOTE
11' O" BDC HT	INDICATES A AH BEARN

INDICATES 2-AR. PIREWA HEIGHTO ARE BASED OFF FROM 0'-0" FIN FLR. (U.N.O.)

rea Tabulat	ions	
ving:		
1st floor:	4,185	sf
2nd floor:	4,188	sf
otal Living:	8,373	sf
entry:	168	sf
garage:	1,683	sf
lanai:	156	sf


Total Area:

First Floor Plan

SCALE: 1/4" = 1'-0"

FIRST OVERALL


GOBA

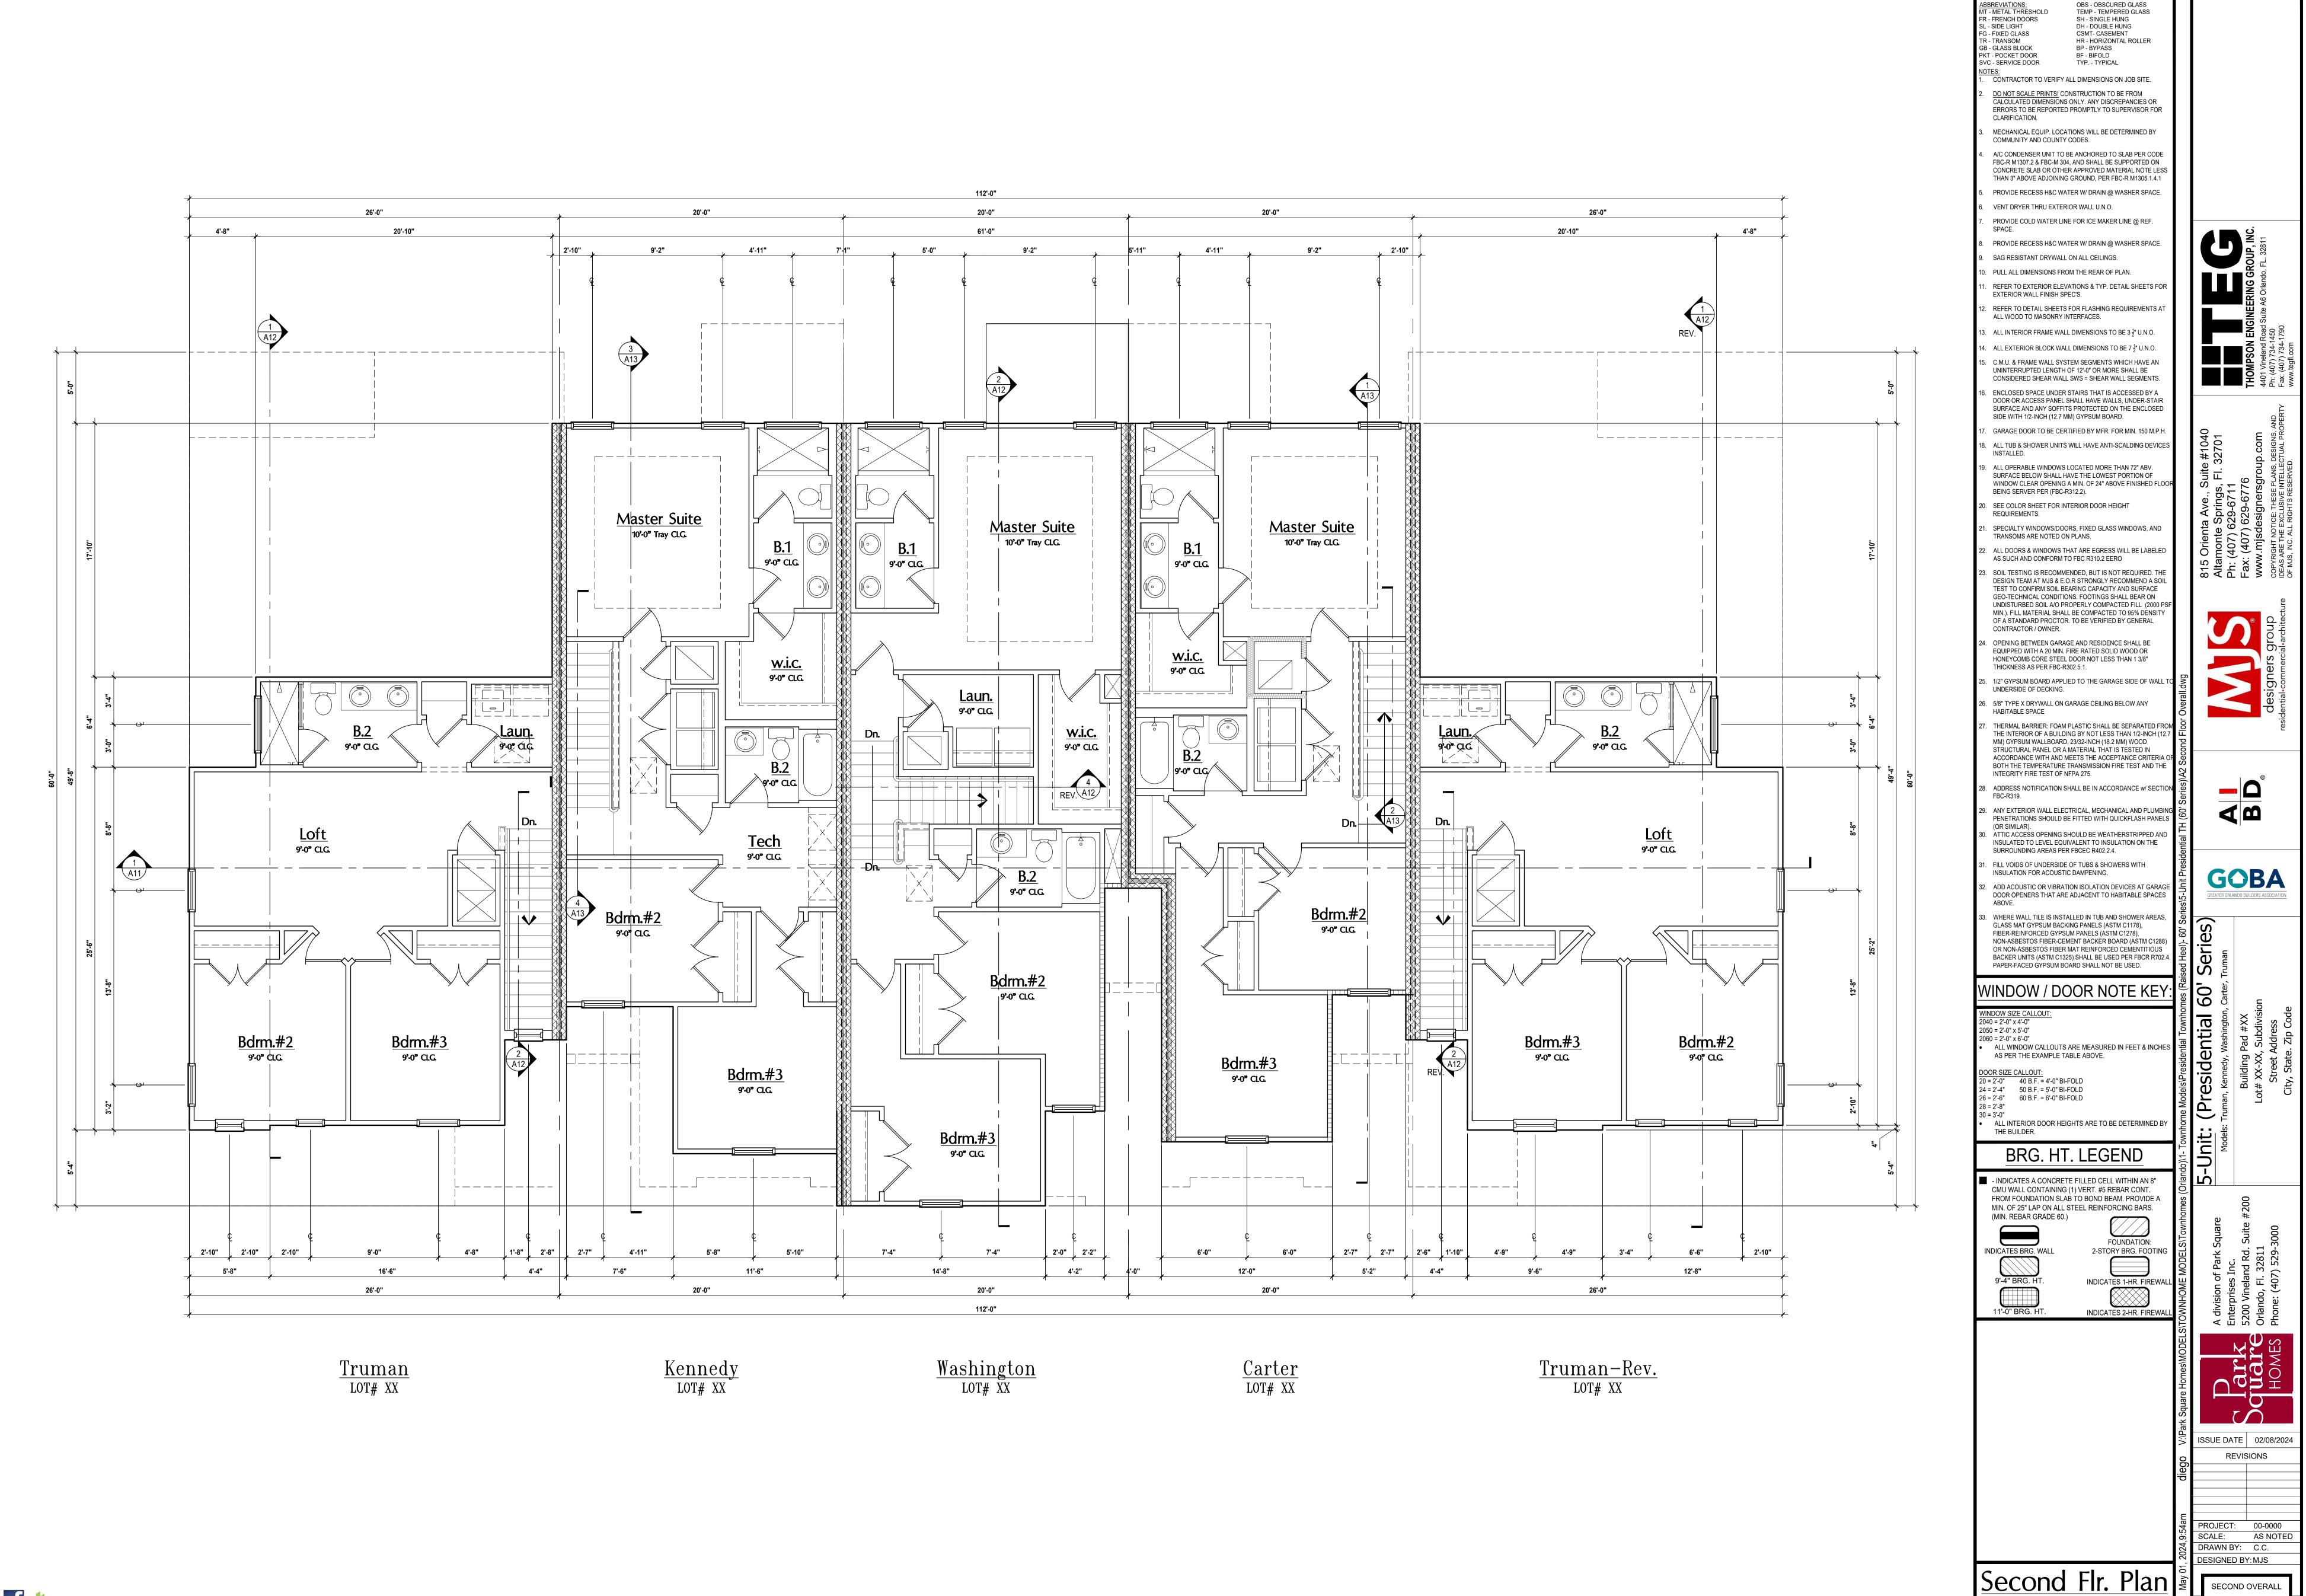

houzz FIND US ON FACEBOOK & HOUZZ AT MJS CUSTOM HOME DESIGNS

GENERAL NOTES KEY:

SCALE: 1/4" = 1'-0"

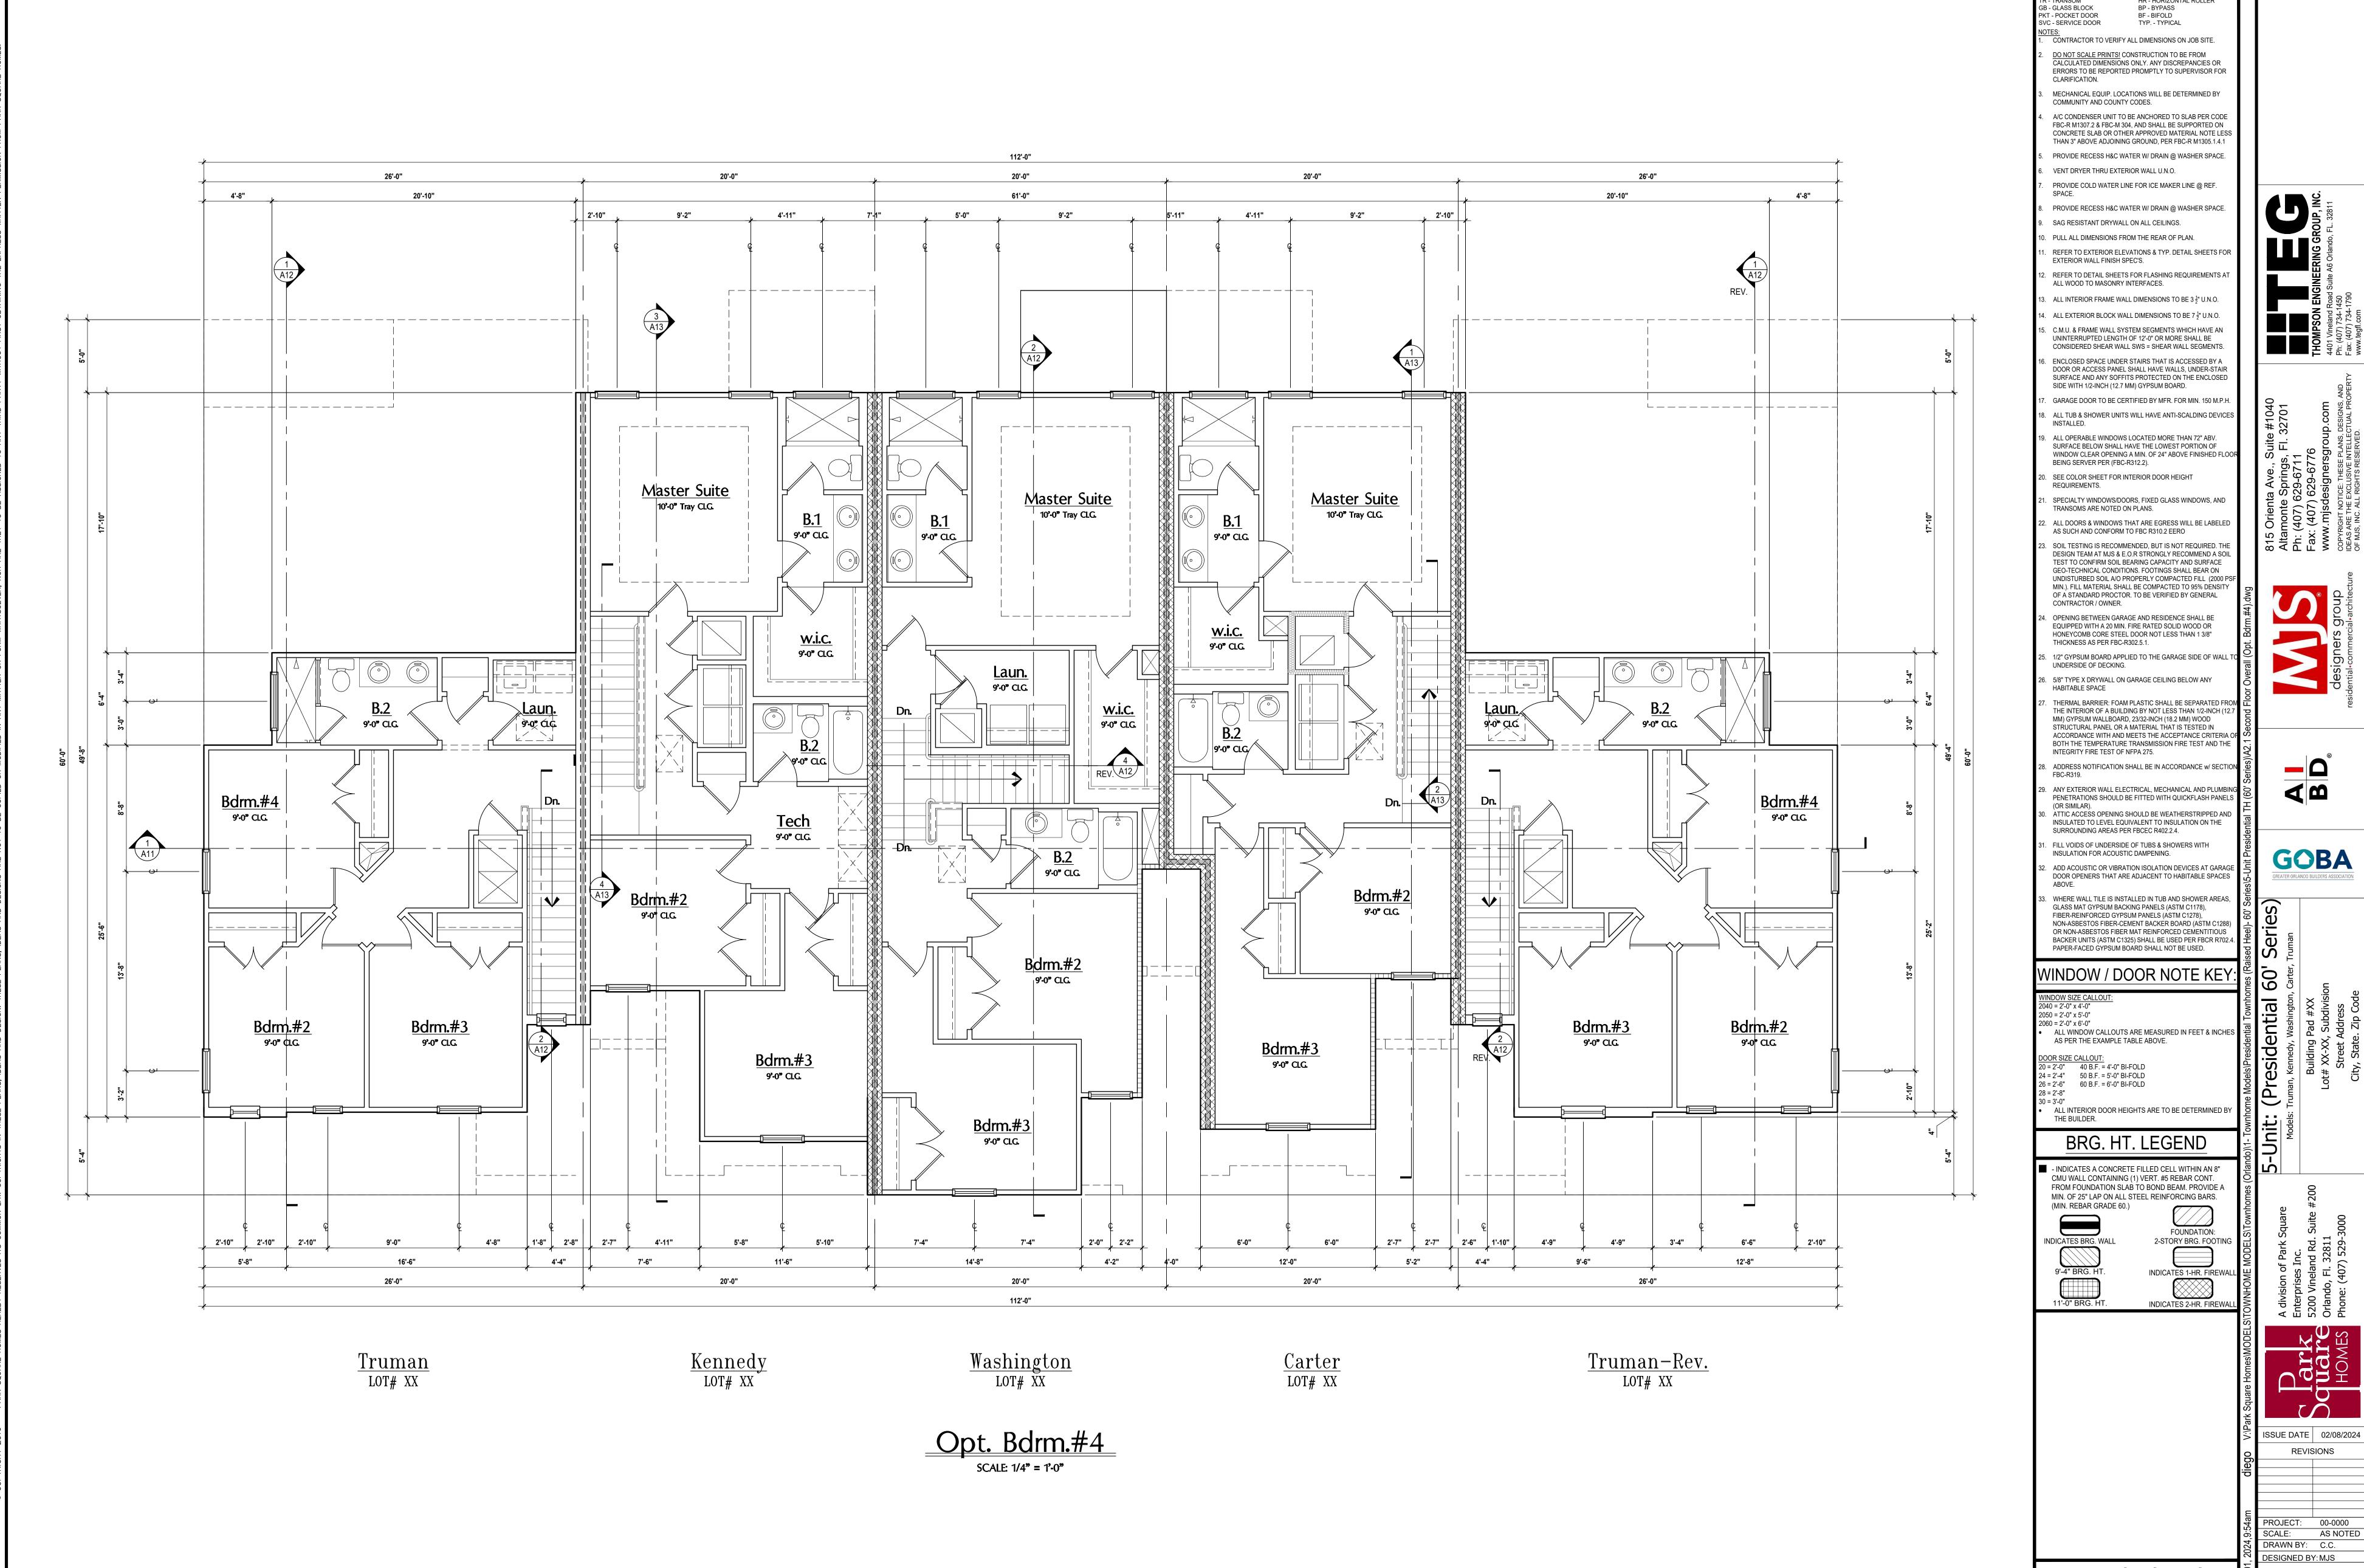


houzz FIND US ON FACEBOOK & HOUZZ AT MJS CUSTOM HOME DESIGNS

GENERAL NOTES KEY:

TEMP - TEMPERED GLASS FR - FRENCH DOORS SH - SINGLE HUNG SL - SIDE LIGHT DH - DOUBLE HUNG FG - FIXED GLASS CSMT- CASEMENT TR - TRANSOM HR - HORIZONTAL ROLLER

Second Flr. Plan second overall A2 SCALE: 1/4" = 1'-0"

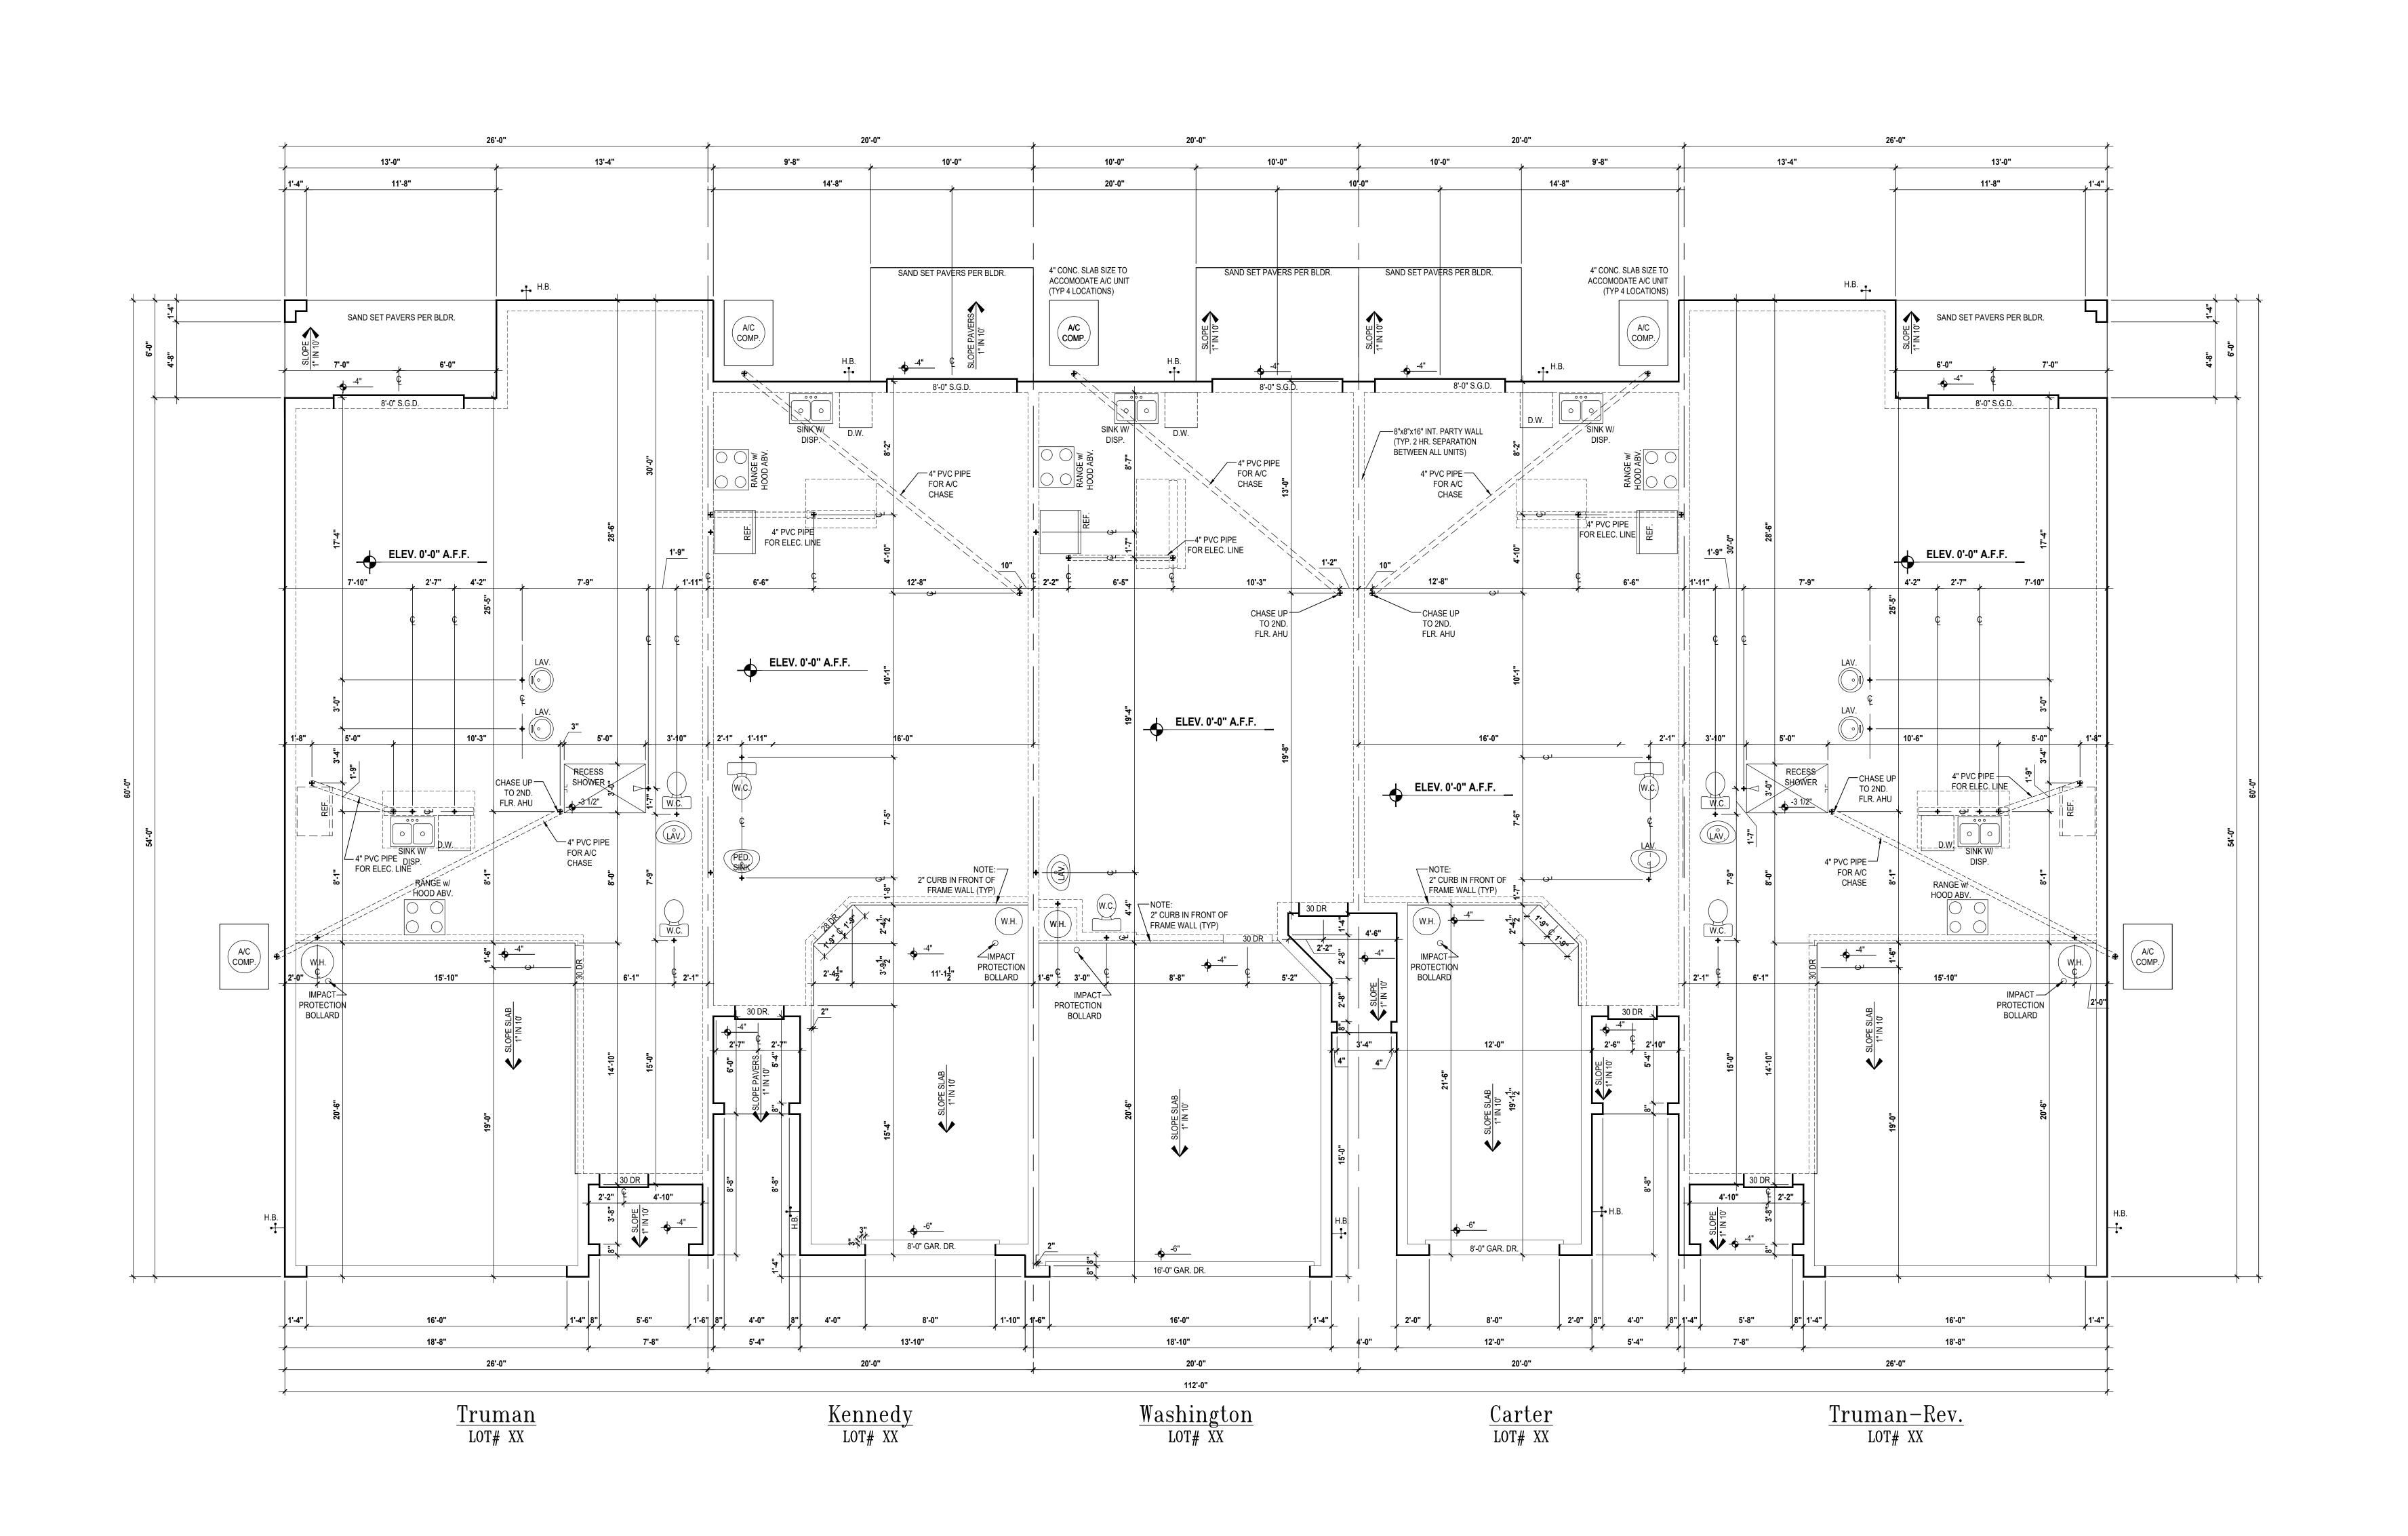


GOBA
GREATER ORLANDO BUILDERS ASSOCIATION

PROJECT: 00-0000
SCALE: AS NOTED
DRAWN BY: C.C.

DESIGNED BY: MJS SLAB PLAN

Slab Plan SCALE: 1/4" = 1'-0"

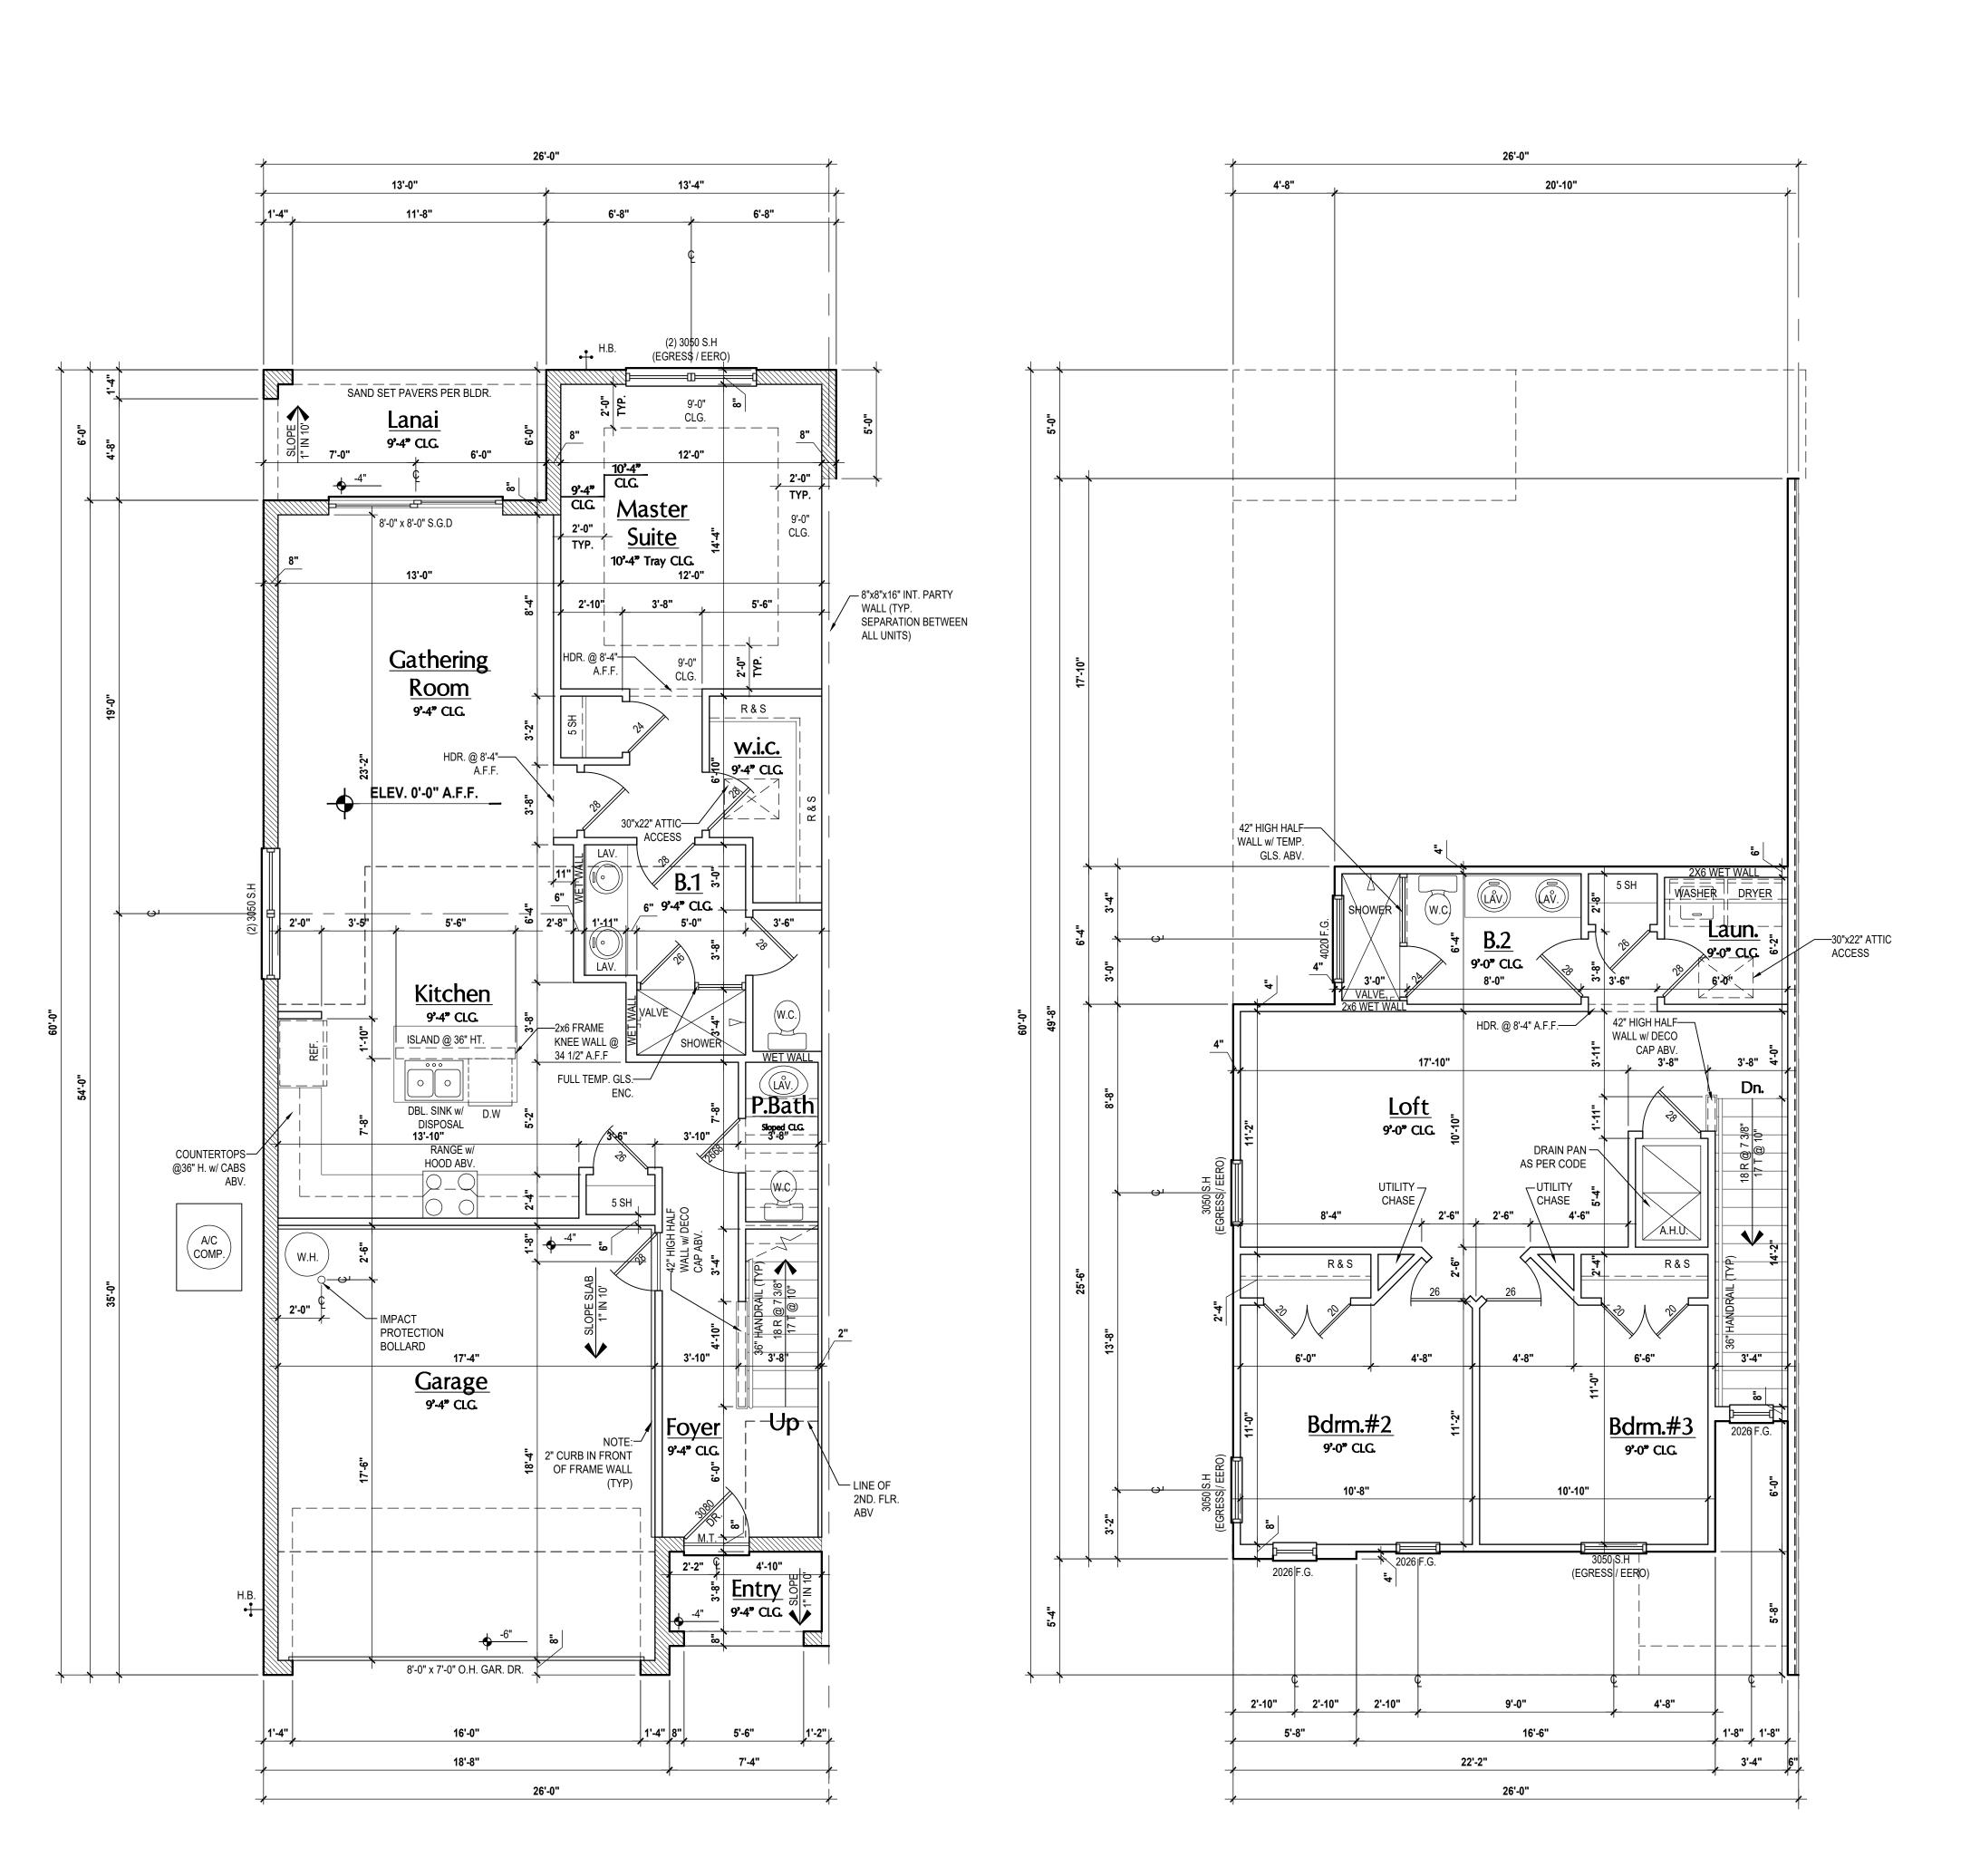

Truman- First Floor Plan


(Standard)

SCALE: 1/4" = 1'-0"

Truman- Second Floor Plan

(Elev.- A)

SCALE: 1/4" = 12-0"

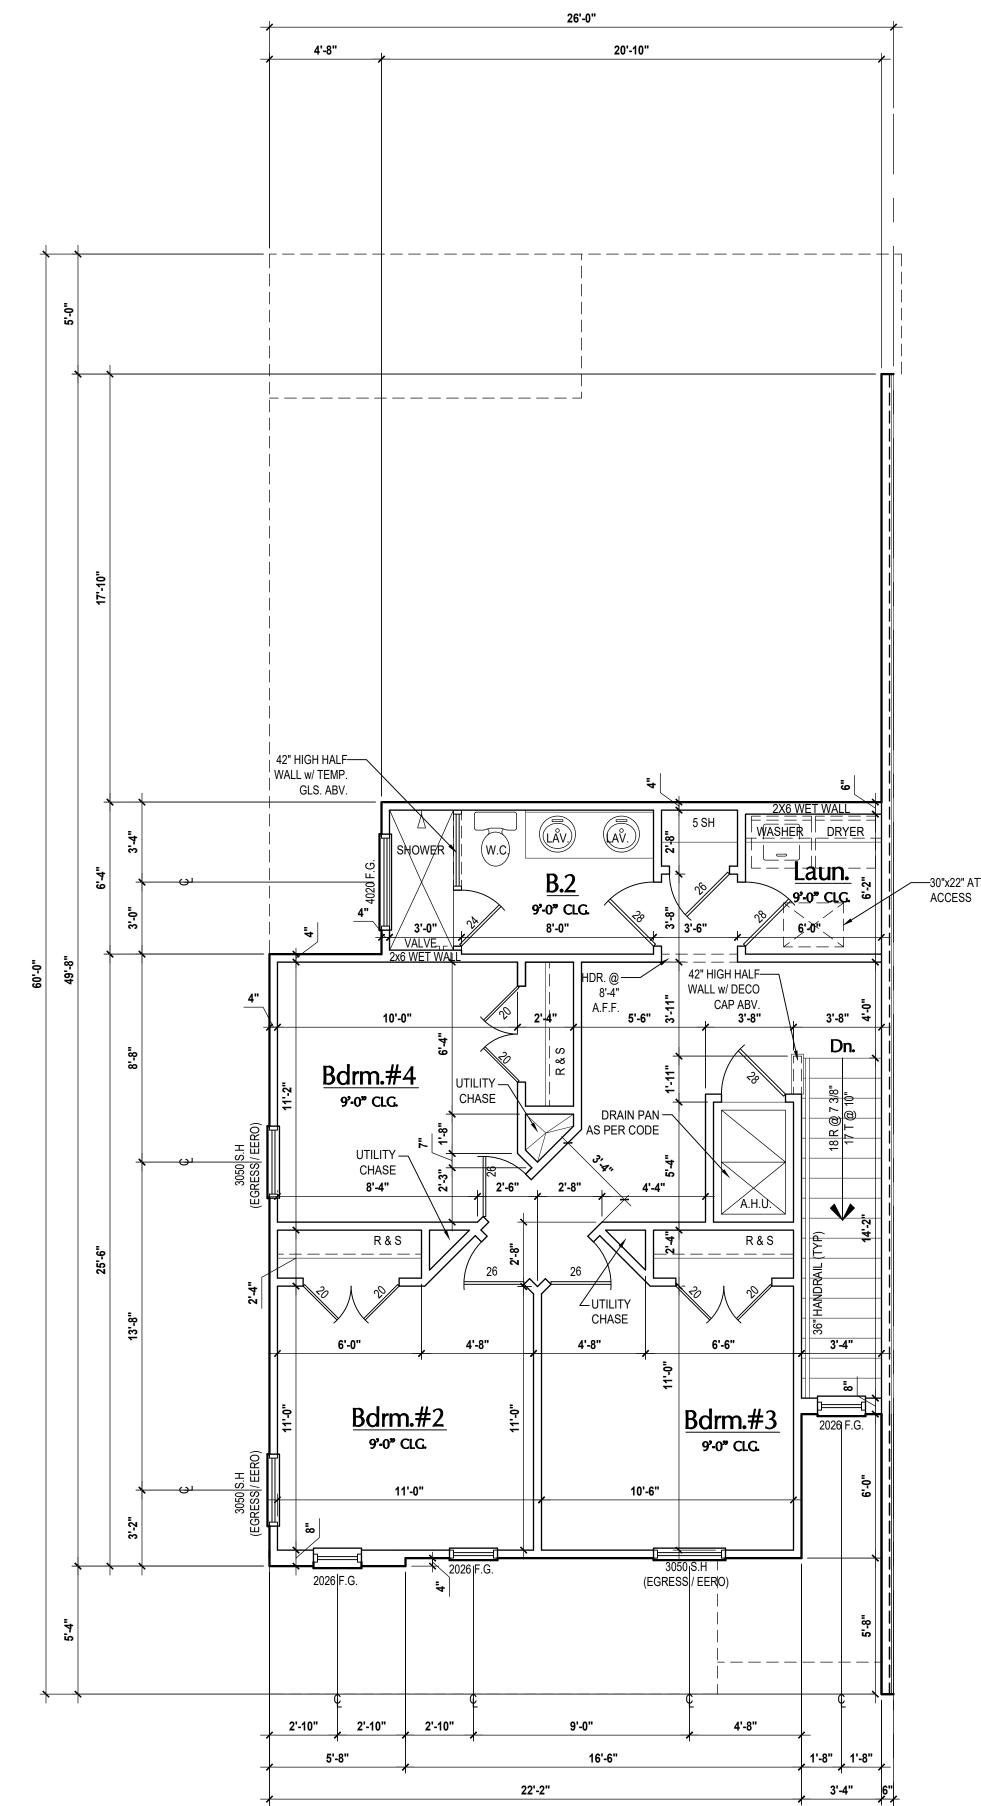

Truman- Second Floor Plan

(Opt. Bdrm.#4)

SCALE: 1/4" = 1'-0"

GENERAL NOTES

ABBREVIATIONS:
MT - METAL THRESHOLD
FR - FRENCH DOORS
SL - SIDE LIGHT
FG - FIXED GLASS
TR - TRANSOM
GB - GLASS BLOCK
PKT - POCKET DOOR
SVC - SERVICE DOOR

OBS - OBSCURED GLASS
TEMP - TEMPERED GLASS
SH - SINGLE HUNG
CSMT - CASEMENT
HR - HORIZONTAL ROLLER
BP - BYPASS
PKT - POCKET DOOR
BF - BIFOLD
TYP - TYPICAL

SVC - SERVICE DOOR TYP. - TYPICAL

NOTES:

1. CONTRACTOR TO VERIFY ALL DIMENSIONS ON JOB SITE.

2. DO NOT SCALE PRINTS! CONSTRUCTION TO BE FROM CALCULATED DIMENSIONS ONLY. ANY DISCREPANCIES OR

ERRORS TO BE REPORTED PROMPTLY TO SUPERVISOR FOR CLARIFICATION.

 MECHANICAL EQUIP. LOCATIONS WILL BE DETERMINED BY COMMUNITY AND COUNTY CODES.
 A/C CONDENSER UNIT TO BE ANCHORED TO SLAB PER CODE FBC-R M1307.2 & FBC-M 304, AND SHALL BE SUPPORTED ON

CONCRETE SLAB OR OTHER APPROVED MATERIAL NOTE LESS THAN 3" ABOVE ADJOINING GROUND, PER FBC-R M1305.1.4.1

5. PROVIDE RECESS H&C WATER W/ DRAIN @ WASHER SPACE.

VENT DRYER THRU EXTERIOR WALL U.N.O.

PROVIDE COLD WATER LINE FOR ICE MAKER LINE @ REF.

3. PROVIDE RECESS H&C WATER W/ DRAIN @ WASHER SPACE.

9. SAG RESISTANT DRYWALL ON ALL CEILINGS.

 PULL ALL DIMENSIONS FROM THE REAR OF PLAN.
 REFER TO EXTERIOR ELEVATIONS & TYP. DETAIL SHEETS FO EXTERIOR WALL FINISH SPEC'S.

12. REFER TO DETAIL SHEETS FOR FLASHING REQUIREMENTS AT ALL WOOD TO MASONRY INTERFACES.

13. ALL INTERIOR FRAME WALL DIMENSIONS TO BE 3 ½" U.N.O.
14. ALL EXTERIOR BLOCK WALL DIMENSIONS TO BE 7 ½" U.N.O.
15. C.M.U. & FRAME WALL SYSTEM SEGMENTS WHICH HAVE AN

UNINTERRUPTED LENGTH OF 12'-0" OR MORE SHALL BE

CONSIDERED SHEAR WALL SWS = SHEAR WALL SEGMENTS.

16. ENCLOSED SPACE UNDER STAIRS THAT IS ACCESSED BY A DOOR OR ACCESS PANEL SHALL HAVE WALLS, UNDER-STAIR SURFACE AND ANY SOFFITS PROTECTED ON THE ENCLOSED SIDE WITH 1/2-INCH (12.7 MM) GYPSUM BOARD.

GARAGE DOOR TO BE CERTIFIED BY MFR. FOR MIN. 150 M.P.H.
 ALL TUB & SHOWER UNITS WILL HAVE ANTI-SCALDING DEVICES INSTALLED.

19. ALL OPERABLE WINDOWS LOCATED MORE THAN 72" ABV.
SURFACE BELOW SHALL HAVE THE LOWEST PORTION OF
WINDOW CLEAR OPENING A MIN. OF 24" ABOVE FINISHED FLOOF

WINDOW CLEAR OPENING A MIN. OF 24" ABOVE FINISHED F BEING SERVER PER (FBC-R312.2).

20. SEE COLOR SHEET FOR INTERIOR DOOR HEIGHT

REQUIREMENTS.

21. SPECIALTY WINDOWS/DOORS, FIXED GLASS WINDOWS, AND TRANSCOME ARE NOTED ON BLANC

TRANSOMS ARE NOTED ON PLANS.

22. ALL DOORS & WINDOWS THAT ARE EGRESS WILL BE LABELED

AS SUCH AND CONFORM TO FBC R310.2 EERO

23. SOIL TESTING IS RECOMMENDED, BUT IS NOT REQUIRED. THE DESIGN TEAM AT MJS & E.O.R STRONGLY RECOMMEND A SOIL TEST TO CONFIRM SOIL BEARING CAPACITY AND SURFACE GEO-TECHNICAL CONDITIONS. FOOTINGS SHALL BEAR ON UNDISTURBED SOIL A/O PROPERLY COMPACTED FILL (2000 PS MIN.). FILL MATERIAL SHALL BE COMPACTED TO 95% DENSITY OF A STANDARD PROCTOR. TO BE VERIFIED BY GENERAL

24. OPENING BETWEEN GARAGE AND RESIDENCE SHALL BE EQUIPPED WITH A 20 MIN. FIRE RATED SOLID WOOD OR HONEYCOMB CORE STEEL DOOR NOT LESS THAN 1 3/8" THICKNESS AS PER FBC-R302.5.1.

CONTRACTOR / OWNER.

25. 1/2" GYPSUM BOARD APPLIED TO THE GARAGE SIDE OF WALL UNDERSIDE OF DECKING.26. 5/8" TYPE X DRYWALL ON GARAGE CEILING BELOW ANY

26. 5/8" TYPE X DRYWALL ON GARAGE CEILING BELOW ANY HABITABLE SPACE

27. THERMAL BARRIER: FOAM PLASTIC SHALL BE SEPARATED FROM THE INTERIOR OF A BUILDING BY NOT LESS THAN 1/2-INCH (12.7 MM) GYPSUM WALLBOARD, 23/32-INCH (18.2 MM) WOOD STRUCTURAL PANEL OR A MATERIAL THAT IS TESTED IN ACCORDANCE WITH AND MEETS THE ACCEPTANCE CRITERIA OF BOTH THE TEMPERATURE TRANSMISSION FIRE TEST AND THE

INTEGRITY FIRE TEST OF NFPA 275.

B. ADDRESS NOTIFICATION SHALL BE IN ACCORDANCE w/ SECTION FBC-R319.

FBC-R319.

29. ANY EXTERIOR WALL ELECTRICAL, MECHANICAL AND PLUMBING PENETRATIONS SHOULD BE FITTED WITH QUICKFLASH PANELS

(OR SIMILAR).

30. ATTIC ACCESS OPENING SHOULD BE WEATHERSTRIPPED AND INSULATED TO LEVEL EQUIVALENT TO INSULATION ON THE SURROUNDING AREAS PER FBCEC R402.2.4.

31. FILL VOIDS OF UNDERSIDE OF TUBS & SHOWERS WITH INSULATION FOR ACOUSTIC DAMPENING.
 32. ADD ACOUSTIC OR VIBRATION ISOLATION DEVICES AT G

32. ADD ACOUSTIC OR VIBRATION ISOLATION DEVICES AT GARAGE DOOR OPENERS THAT ARE ADJACENT TO HABITABLE SPACES ABOVE.

33. WHERE WALL TILE IS INSTALLED IN TUB AND SHOWER AREAS, GLASS MAT GYPSUM BACKING PANELS (ASTM C1178), FIBER-REINFORCED GYPSUM PANELS (ASTM C1278), NON-ASBESTOS FIBER-CEMENT BACKER BOARD (ASTM C1288) OR NON-ASBESTOS FIBER MAT REINFORCED CEMENTITIOUS BACKER UNITS (ASTM C1325) SHALL BE USED PER FBCR R702.4. PAPER-FACED GYPSUM BOARD SHALL NOT BE USED.

WINDOW / DOOR NOTE KEY

WINDOW SIZE CALLOUT 2040 = 2'-0" x 4'-0" 2050 = 2'-0" x 5'-0" 2060 = 2'-0" x 6'-0"

2060 = 2'-0" x 6'-0"

ALL WINDOW CALLOUTS ARE MEASURED IN FEET & INCHES AS PER THE EXAMPLE TABLE ABOVE.

DOOR SIZE CALLOUT:

24 = 2'-4" 50 B.F. = 5'-0" BI-FOLD 26 = 2'-6" 60 B.F. = 6'-0" BI-FOLD 28 = 2'-8" 30 = 3'-0"

ALL INTERIOR DOOR HEIGHTS ARE TO BE DETERMINED BY THE BUILDER.

- INDICER CONHETE FLLEDGE NOT

FROM FOUNDATION SLAB TO BOND BEAM. PROVIDE A
MIN. OF 15" LAP ON ALL STEEL REINFORCING BARS.

(MIN. REBAR GRADE 60.)

9'-4" BRG. HT.

FOUNDATION:

2-HINDROATION BRG. WALL

9'-4" BRG. HT.

INDICATES 1-HR. FIREWALL

FRAM TYPIL

PER CLAN

11'-0" BRG. HT.

INDICATES 2-AR. PIREWALL

FROM C FLR. (U

Area Tabulations

 Living:

 1st floor:
 1,065 sf

 2nd floor:
 723 sf

 Total Living:
 1,788 sf

 entry:
 32 sf

 garage:
 376 sf

 lanai:
 78 sf


Floor Plan

SCALE: 1/4" = 1'-0"


FLOOR PLANS
A4

DRAWN BY: C.C.



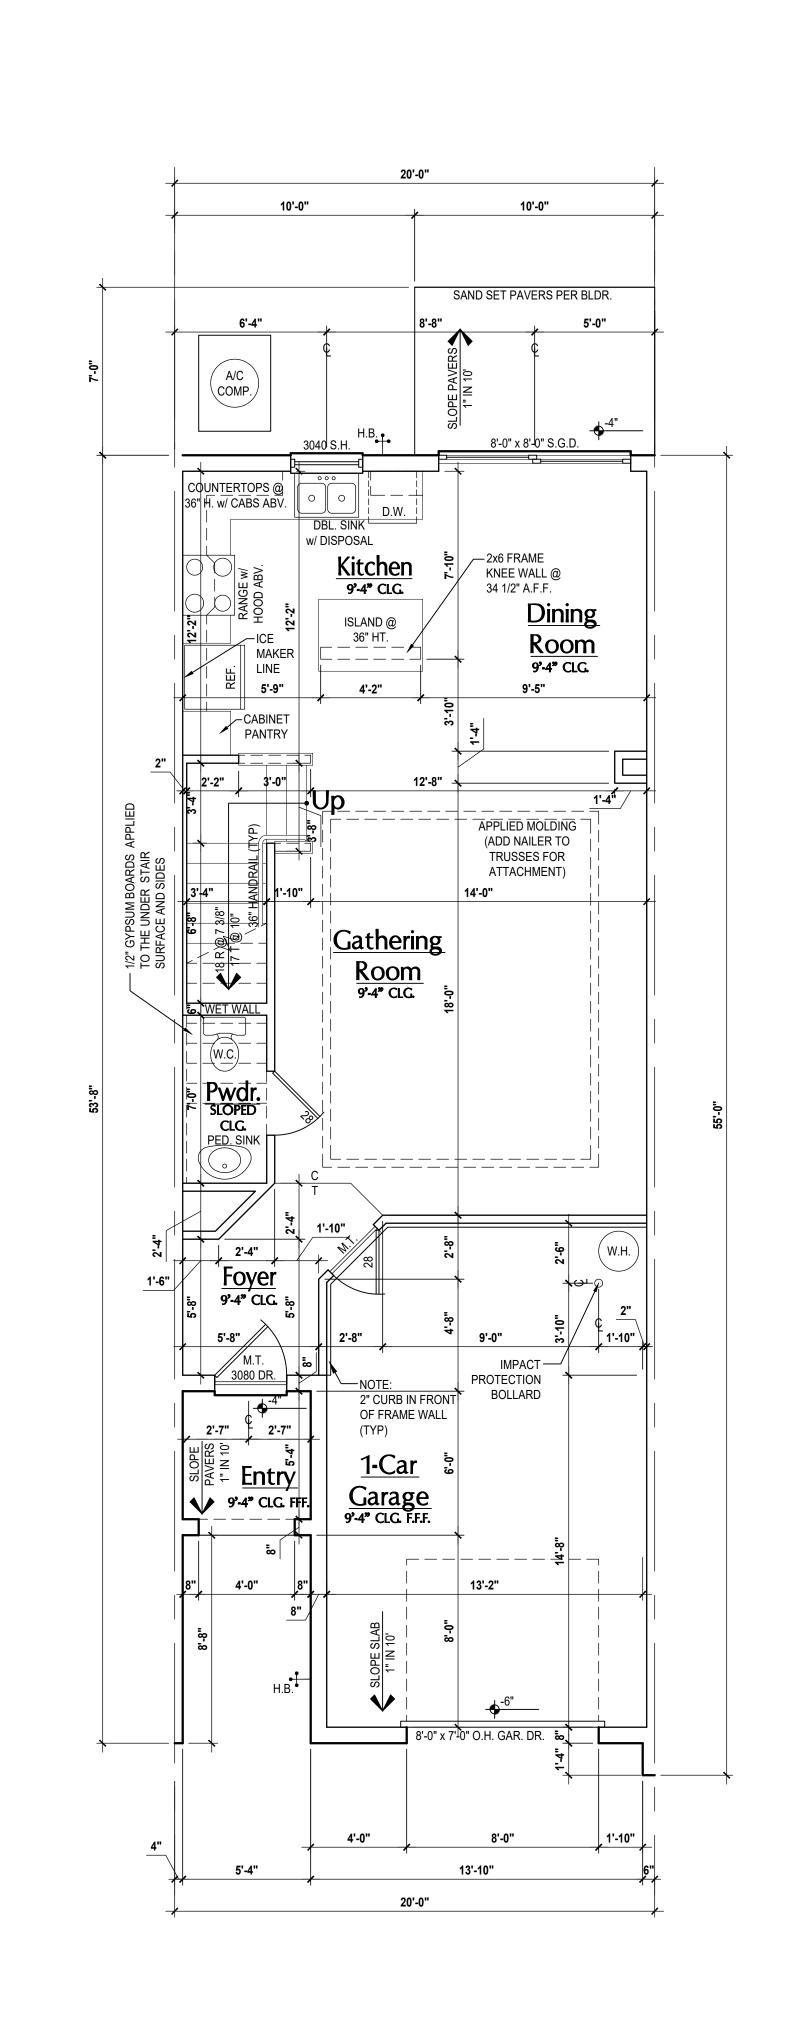

SCALE: 1/4" = 1'-0"

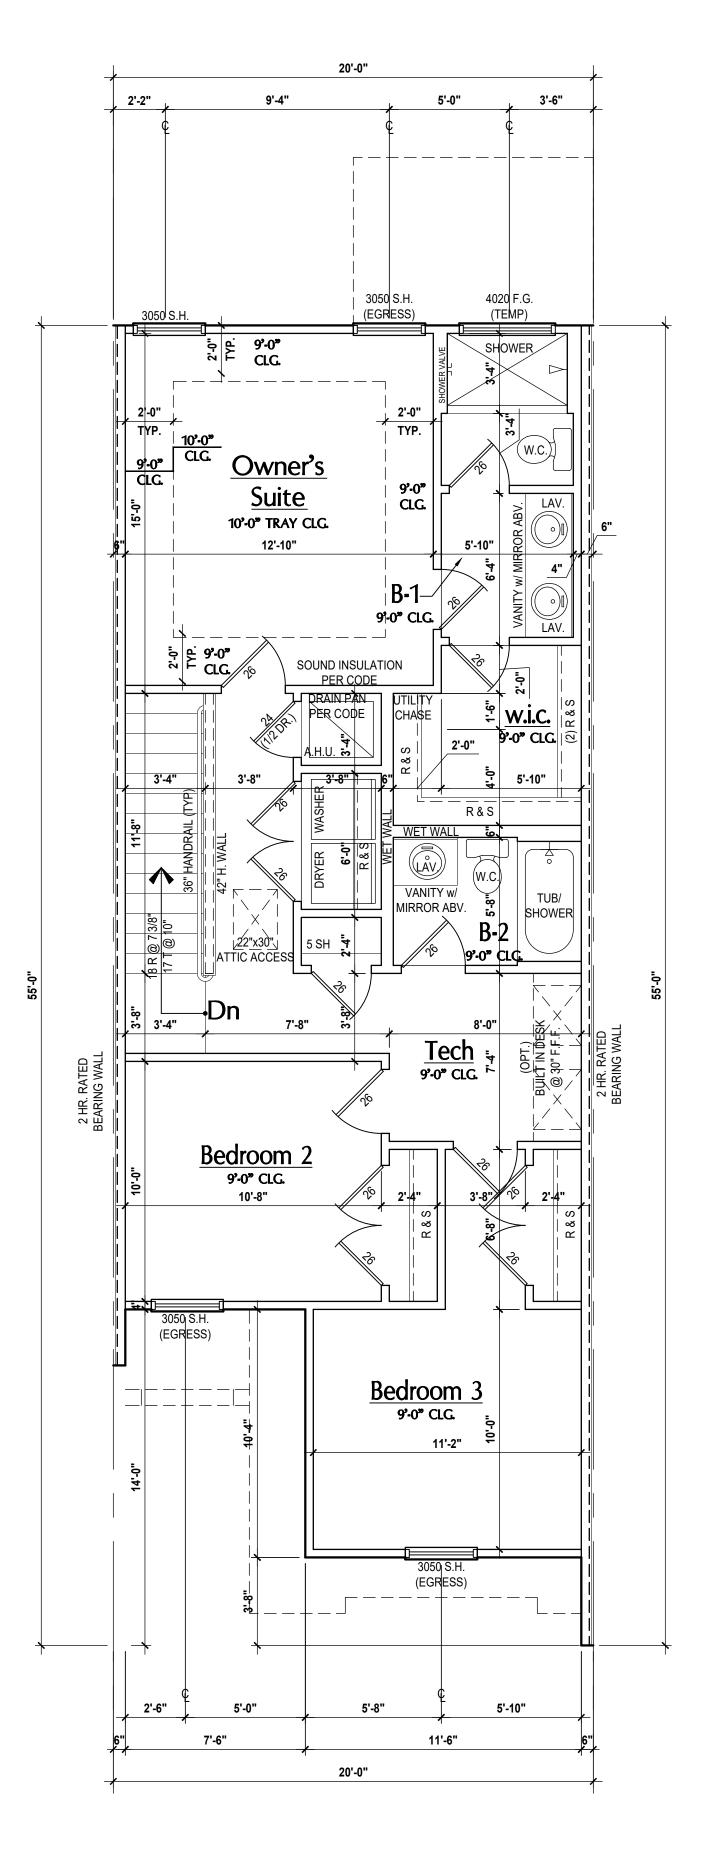

Kennedy Second Floor SCALE: 1/4" = 1'-0"

GENERAL NOTES KEY:

MT - METAL THRESHOLD TEMP - TEMPERED GLASS FR - FRENCH DOORS SH - SINGLE HUNG SL - SIDE LIGHT DH - DOUBLE HUNG G - FIXED GLASS CSMT- CASEMENT R - TRANSOM HR - HORIZONTAL ROLLER GB - GLASS BLOCK BP - BYPASS PKT - POCKET DOOR BF - BIFOLD SVC - SERVICE DOOR

CONTRACTOR TO VERIFY ALL DIMENSIONS ON JOB SITE. <u>DO NOT SCALE PRINTS!</u> CONSTRUCTION TO BE FROM CALCULATED DIMENSIONS ONLY. ANY DISCREPANCIES OR ERRORS TO BE REPORTED PROMPTLY TO SUPERVISOR FOR

CLARIFICATION. MECHANICAL EQUIP. LOCATIONS WILL BE DETERMINED BY COMMUNITY AND COUNTY CODES.

A/C CONDENSER UNIT TO BE ANCHORED TO SLAB PER CODE FBC-R M1307.2 & FBC-M 304, AND SHALL BE SUPPORTED ON CONCRETE SLAB OR OTHER APPROVED MATERIAL NOTE LESS THAN 3" ABOVE ADJOINING GROUND, PER FBC-R M1305.1.4.1

PROVIDE RECESS H&C WATER W/ DRAIN @ WASHER SPACE. VENT DRYER THRU EXTERIOR WALL U.N.O. PROVIDE COLD WATER LINE FOR ICE MAKER LINE @ REF.

PROVIDE RECESS H&C WATER W/ DRAIN @ WASHER SPACE. SAG RESISTANT DRYWALL ON ALL CEILINGS.

). PULL ALL DIMENSIONS FROM THE REAR OF PLAN.

. REFER TO EXTERIOR ELEVATIONS & TYP. DETAIL SHEETS FOR EXTERIOR WALL FINISH SPEC'S.

REFER TO DETAIL SHEETS FOR FLASHING REQUIREMENTS AT ALL WOOD TO MASONRY INTERFACES.

3. ALL INTERIOR FRAME WALL DIMENSIONS TO BE 3 $\frac{1}{2}$ " U.N.O. I. ALL EXTERIOR BLOCK WALL DIMENSIONS TO BE 7 $\frac{1}{2}$ " U.N.O. i. C.M.U. & FRAME WALL SYSTEM SEGMENTS WHICH HAVE AN

UNINTERRUPTED LENGTH OF 12'-0" OR MORE SHALL BE CONSIDERED SHEAR WALL SWS = SHEAR WALL SEGMENTS ENCLOSED SPACE UNDER STAIRS THAT IS ACCESSED BY A DOOR OR ACCESS PANEL SHALL HAVE WALLS, UNDER-STAIR SURFACE AND ANY SOFFITS PROTECTED ON THE ENCLOSED

SIDE WITH 1/2-INCH (12.7 MM) GYPSUM BOARD.

GARAGE DOOR TO BE CERTIFIED BY MFR. FOR MIN. 150 M.P.H. 3. ALL TUB & SHOWER UNITS WILL HAVE ANTI-SCALDING DEVICES

). ALL OPERABLE WINDOWS LOCATED MORE THAN 72" ABV. SURFACE BELOW SHALL HAVE THE LOWEST PORTION OF

WINDOW CLEAR OPENING A MIN. OF 24" ABOVE FINISHED FLOO BEING SERVER PER (FBC-R312.2).

). SEE COLOR SHEET FOR INTERIOR DOOR HEIGHT REQUIREMENTS.

. SPECIALTY WINDOWS/DOORS, FIXED GLASS WINDOWS, AND TRANSOMS ARE NOTED ON PLANS.

2. ALL DOORS & WINDOWS THAT ARE EGRESS WILL BE LABELED AS SUCH AND CONFORM TO FBC R310.2 EERO SOIL TESTING IS RECOMMENDED, BUT IS NOT REQUIRED. THE DESIGN TEAM AT MJS & E.O.R STRONGLY RECOMMEND A SOIL TEST TO CONFIRM SOIL BEARING CAPACITY AND SURFACE

GEO-TECHNICAL CONDITIONS. FOOTINGS SHALL BEAR ON UNDISTURBED SOIL A/O PROPERLY COMPACTED FILL (2000 PS MIN.). FILL MATERIAL SHALL BE COMPACTED TO 95% DENSITY OF A STANDARD PROCTOR. TO BE VERIFIED BY GENERAL CONTRACTOR / OWNER.

4. OPENING BETWEEN GARAGE AND RESIDENCE SHALL BE EQUIPPED WITH A 20 MIN. FIRE RATED SOLID WOOD OR HONEYCOMB CORE STEEL DOOR NOT LESS THAN 1 3/8" THICKNESS AS PER FBC-R302.5.1.

. 1/2" GYPSUM BOARD APPLIED TO THE GARAGE SIDE OF WALL UNDERSIDE OF DECKING. 6. 5/8" TYPE X DRYWALL ON GARAGE CEILING BELOW ANY

HABITABLE SPACE

THERMAL BARRIER: FOAM PLASTIC SHALL BE SEPARATED FRO THE INTERIOR OF A BUILDING BY NOT LESS THAN 1/2-INCH (12.7 MM) GYPSUM WALLBOARD, 23/32-INCH (18.2 MM) WOOD STRUCTURAL PANEL OR A MATERIAL THAT IS TESTED IN ACCORDANCE WITH AND MEETS THE ACCEPTANCE CRITERIA O BOTH THE TEMPERATURE TRANSMISSION FIRE TEST AND THE INTEGRITY FIRE TEST OF NFPA 275.

ADDRESS NOTIFICATION SHALL BE IN ACCORDANCE w/ SECTION

ANY EXTERIOR WALL ELECTRICAL, MECHANICAL AND PLUMBING PENETRATIONS SHOULD BE FITTED WITH QUICKFLASH PANELS

. ATTIC ACCESS OPENING SHOULD BE WEATHERSTRIPPED AND INSULATED TO LEVEL EQUIVALENT TO INSULATION ON THE SURROUNDING AREAS PER FBCEC R402.2.4. FILL VOIDS OF UNDERSIDE OF TUBS & SHOWERS WITH INSULATION FOR ACOUSTIC DAMPENING.

ADD ACOUSTIC OR VIBRATION ISOLATION DEVICES AT GARAGE DOOR OPENERS THAT ARE ADJACENT TO HABITABLE SPACES WHERE WALL TILE IS INSTALLED IN TUB AND SHOWER AREAS,

GLASS MAT GYPSUM BACKING PANELS (ASTM C1178), FIBER-REINFORCED GYPSUM PANELS (ASTM C1278), NON-ASBESTOS FIBER-CEMENT BACKER BOARD (ASTM C1288) OR NON-ASBESTOS FIBER MAT REINFORCED CEMENTITIOUS BACKER UNITS (ASTM C1325) SHALL BE USED PER FBCR R702.4. PAPER-FACED GYPSUM BOARD SHALL NOT BE USED.

WINDOW / DOOR NOTE KEY

2050 = 2'-0" x 5'-0"

2060 = 2'-0" x 6'-0" ALL WINDOW CALLOUTS ARE MEASURED IN FEET & INCHES AS PER THE EXAMPLE TABLE ABOVE. DOOR SIZE CALLOUT: 20 = 2'-0" 40 B.F. = 4'-0" BI-FOLD

24 = 2'-4" 50 B.F. = 5'-0" BI-FOLD 26 = 2'-6" 60 B.F. = 6'-0" BI-FOLD

ALL INTERIOR DOOR HEIGHTS ARE TO BE DETERMINED BY

- INDICER CONFIETE FLLEDCE NITH AN 8"

FROM FOUNDATION SLAB TO BOND BEAM. PROVIDE A MIN OF 5" LAP ON ALL STEEL REINFORCING BARS. FOUNDATION: 2-STORY BRG. FOOTING INDICATES 1-HR. FIREWAL INDICATES 2-AH-PIREWA


FROM 0'-0" FIN FLR. (U.N.O.) Area Tabulations _iving: 687 sf 1st floor: 885 st 2nd floor: 1,572 sf Total Living: 34 sf 303 sf mechanical: 1,918 sf Γotal Area: opt. cov. patio:


Floor Plan

DRAWN BY: C.C. DESIGNED BY: MJS

FLOOR PLANS SCALE: 1/4" = 1'-0"

Kennedy First Floor

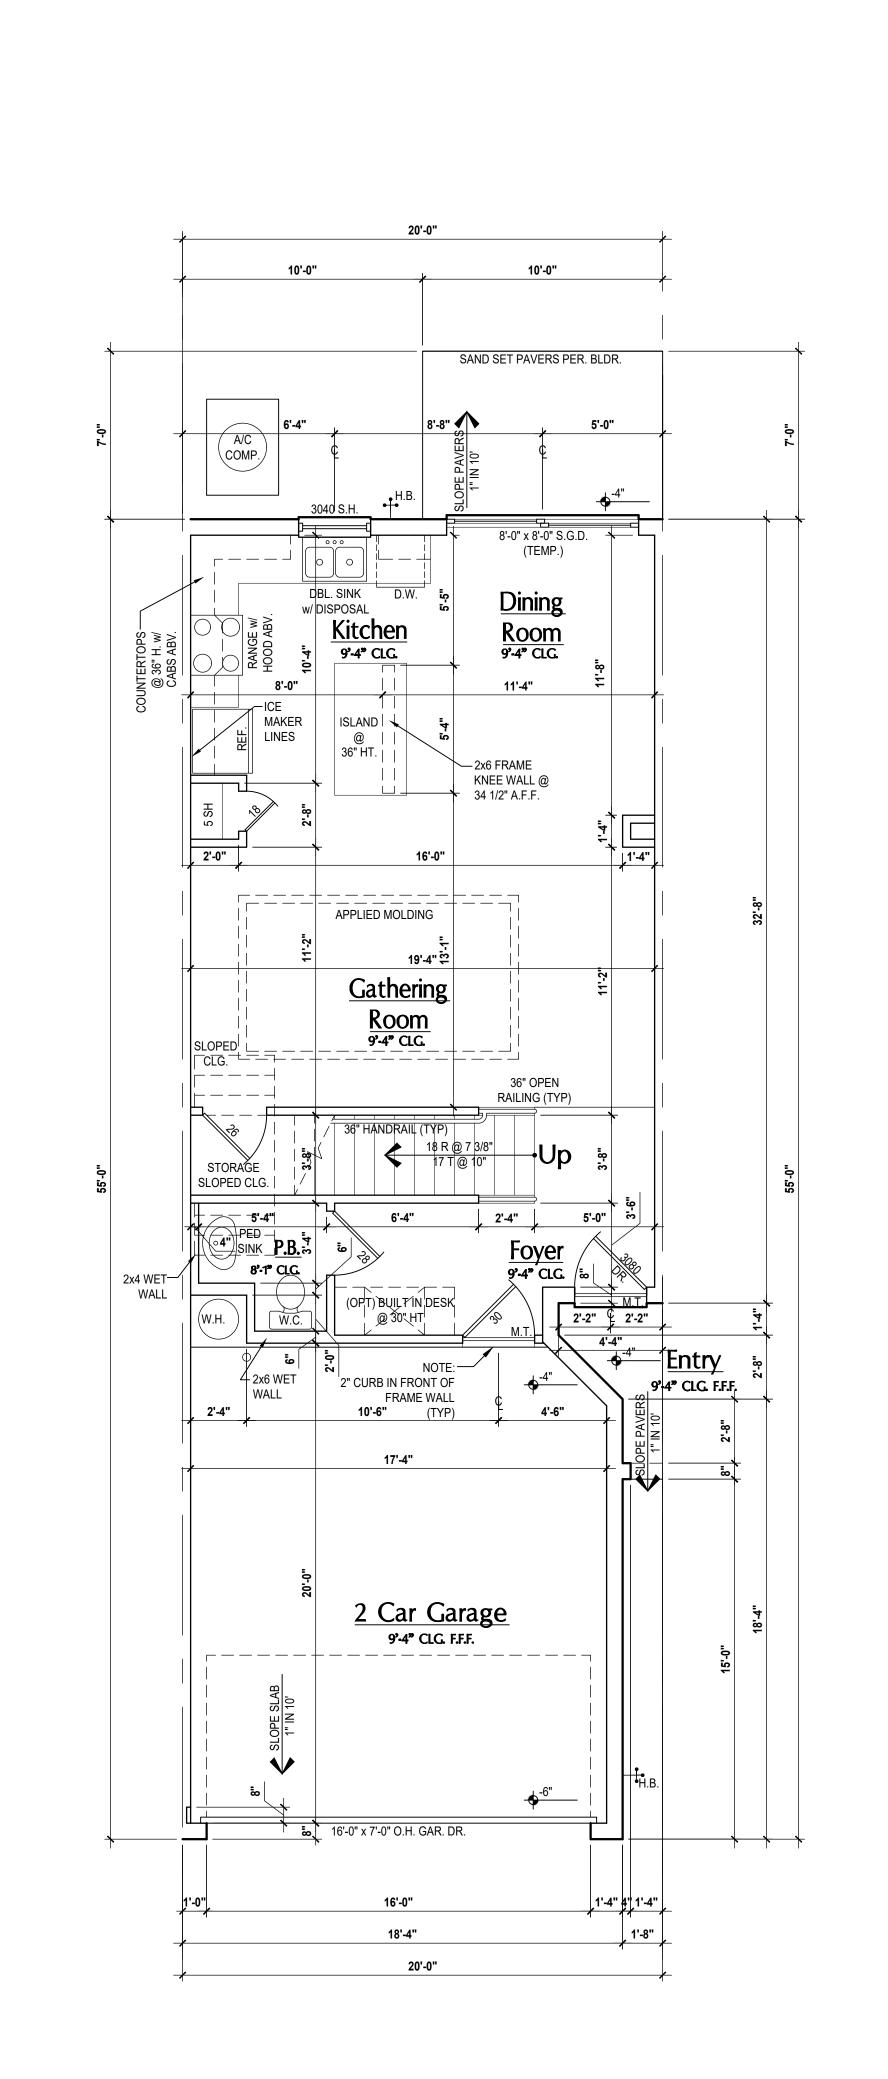

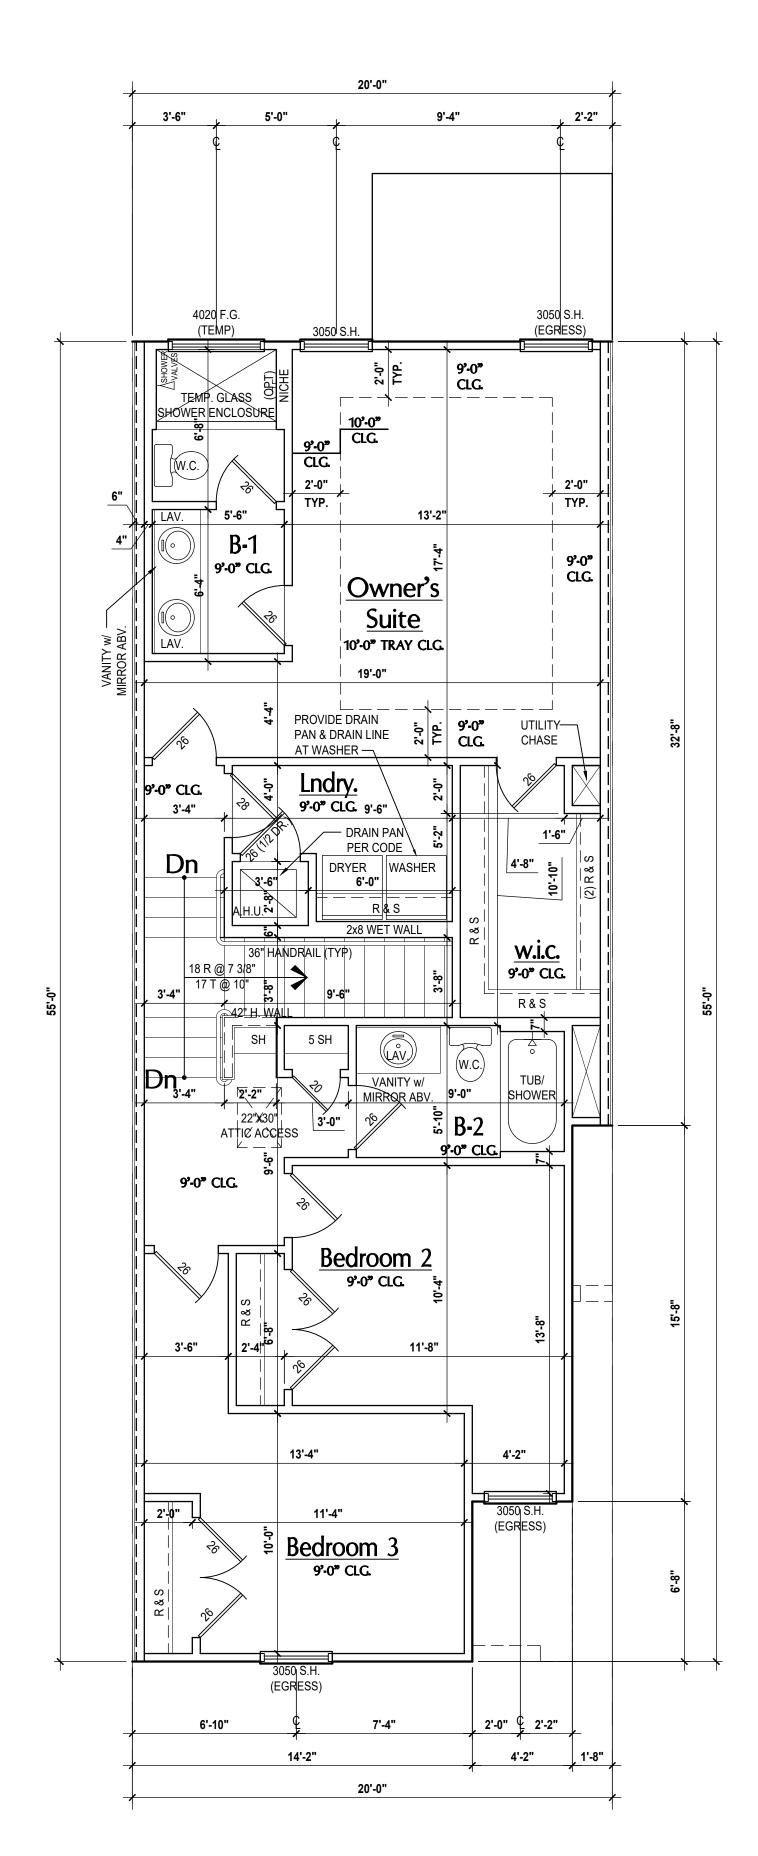

Washington- First Floor Plan

Washington- Second Floor Plan (Standard)
SCALE: 1/4" = 1'-0"

GENERAL NOTES KEY: TEMP - TEMPERED GLASS FR - FRENCH DOORS SH - SINGLE HUNG SL - SIDE LIGHT DH - DOUBLE HUNG G - FIXED GLASS CSMT- CASEMENT R - TRANSOM HR - HORIZONTAL ROLLER

SVC - SERVICE DOOR CONTRACTOR TO VERIFY ALL DIMENSIONS ON JOB SITE. <u>DO NOT SCALE PRINTS!</u> CONSTRUCTION TO BE FROM CALCULATED DIMENSIONS ONLY. ANY DISCREPANCIES OR ERRORS TO BE REPORTED PROMPTLY TO SUPERVISOR FOR

MECHANICAL EQUIP. LOCATIONS WILL BE DETERMINED BY

COMMUNITY AND COUNTY CODES.

GB - GLASS BLOCK PKT - POCKET DOOR

A/C CONDENSER UNIT TO BE ANCHORED TO SLAB PER CODE FBC-R M1307.2 & FBC-M 304, AND SHALL BE SUPPORTED ON CONCRETE SLAB OR OTHER APPROVED MATERIAL NOTE LESS THAN 3" ABOVE ADJOINING GROUND, PER FBC-R M1305.1.4.1

PROVIDE RECESS H&C WATER W/ DRAIN @ WASHER SPACE. VENT DRYER THRU EXTERIOR WALL U.N.O. PROVIDE COLD WATER LINE FOR ICE MAKER LINE @ REF.

PROVIDE RECESS H&C WATER W/ DRAIN @ WASHER SPACE. SAG RESISTANT DRYWALL ON ALL CEILINGS.

). PULL ALL DIMENSIONS FROM THE REAR OF PLAN.

. REFER TO EXTERIOR ELEVATIONS & TYP. DETAIL SHEETS FOR EXTERIOR WALL FINISH SPEC'S.

REFER TO DETAIL SHEETS FOR FLASHING REQUIREMENTS AT ALL WOOD TO MASONRY INTERFACES. 3. ALL INTERIOR FRAME WALL DIMENSIONS TO BE 3 $\frac{1}{2}$ " U.N.O.

I. ALL EXTERIOR BLOCK WALL DIMENSIONS TO BE 7 $\frac{1}{2}$ " U.N.O. 5. C.M.U. & FRAME WALL SYSTEM SEGMENTS WHICH HAVE AN

UNINTERRUPTED LENGTH OF 12'-0" OR MORE SHALL BE

CONSIDERED SHEAR WALL SWS = SHEAR WALL SEGMENTS ENCLOSED SPACE UNDER STAIRS THAT IS ACCESSED BY A DOOR OR ACCESS PANEL SHALL HAVE WALLS, UNDER-STAIR SURFACE AND ANY SOFFITS PROTECTED ON THE ENCLOSED

SIDE WITH 1/2-INCH (12.7 MM) GYPSUM BOARD. GARAGE DOOR TO BE CERTIFIED BY MFR. FOR MIN. 150 M.P.H. 3. ALL TUB & SHOWER UNITS WILL HAVE ANTI-SCALDING DEVICES

). ALL OPERABLE WINDOWS LOCATED MORE THAN 72" ABV. SURFACE BELOW SHALL HAVE THE LOWEST PORTION OF

WINDOW CLEAR OPENING A MIN. OF 24" ABOVE FINISHED FLOO BEING SERVER PER (FBC-R312.2).). SEE COLOR SHEET FOR INTERIOR DOOR HEIGHT

REQUIREMENTS. . SPECIALTY WINDOWS/DOORS, FIXED GLASS WINDOWS, AND

TRANSOMS ARE NOTED ON PLANS. ALL DOORS & WINDOWS THAT ARE EGRESS WILL BE LABELED

AS SUCH AND CONFORM TO FBC R310.2 EERO SOIL TESTING IS RECOMMENDED, BUT IS NOT REQUIRED. THE DESIGN TEAM AT MJS & E.O.R STRONGLY RECOMMEND A SOIL TEST TO CONFIRM SOIL BEARING CAPACITY AND SURFACE

GEO-TECHNICAL CONDITIONS. FOOTINGS SHALL BEAR ON UNDISTURBED SOIL A/O PROPERLY COMPACTED FILL (2000 PS MIN.). FILL MATERIAL SHALL BE COMPACTED TO 95% DENSITY OF A STANDARD PROCTOR. TO BE VERIFIED BY GENERAL CONTRACTOR / OWNER.

4. OPENING BETWEEN GARAGE AND RESIDENCE SHALL BE EQUIPPED WITH A 20 MIN. FIRE RATED SOLID WOOD OR HONEYCOMB CORE STEEL DOOR NOT LESS THAN 1 3/8" THICKNESS AS PER FBC-R302.5.1.

. 1/2" GYPSUM BOARD APPLIED TO THE GARAGE SIDE OF WAI UNDERSIDE OF DECKING. 6. 5/8" TYPE X DRYWALL ON GARAGE CEILING BELOW ANY

HABITABLE SPACE

THERMAL BARRIER: FOAM PLASTIC SHALL BE SEPARATED FRO THE INTERIOR OF A BUILDING BY NOT LESS THAN 1/2-INCH (12. MM) GYPSUM WALLBOARD, 23/32-INCH (18.2 MM) WOOD STRUCTURAL PANEL OR A MATERIAL THAT IS TESTED IN ACCORDANCE WITH AND MEETS THE ACCEPTANCE CRITERIA O BOTH THE TEMPERATURE TRANSMISSION FIRE TEST AND THE INTEGRITY FIRE TEST OF NFPA 275.

ADDRESS NOTIFICATION SHALL BE IN ACCORDANCE W/ SECTION

. ANY EXTERIOR WALL ELECTRICAL, MECHANICAL AND PLUMBING PENETRATIONS SHOULD BE FITTED WITH QUICKFLASH PANELS

ATTIC ACCESS OPENING SHOULD BE WEATHERSTRIPPED AND INSULATED TO LEVEL EQUIVALENT TO INSULATION ON THE SURROUNDING AREAS PER FBCEC R402.2.4.

FILL VOIDS OF UNDERSIDE OF TUBS & SHOWERS WITH INSULATION FOR ACOUSTIC DAMPENING. ADD ACOUSTIC OR VIBRATION ISOLATION DEVICES AT GARAGE DOOR OPENERS THAT ARE ADJACENT TO HABITABLE SPACES

WHERE WALL TILE IS INSTALLED IN TUB AND SHOWER AREAS, GLASS MAT GYPSUM BACKING PANELS (ASTM C1178), FIBER-REINFORCED GYPSUM PANELS (ASTM C1278), NON-ASBESTOS FIBER-CEMENT BACKER BOARD (ASTM C1288 OR NON-ASBESTOS FIBER MAT REINFORCED CEMENTITIOUS BACKER UNITS (ASTM C1325) SHALL BE USED PER FBCR R702.4. PAPER-FACED GYPSUM BOARD SHALL NOT BE USED.

2050 = 2'-0" x 5'-0"

ALL WINDOW CALLOUTS ARE MEASURED IN FEET & INCHES AS PER THE EXAMPLE TABLE ABOVE.

<u>JOOR SIZE CALLOUT:</u> 20 = 2'-0" 40 B.F. = 4'-0" BI-FOLD 4 = 2'-4" 50 B.F. = 5'-0" BI-FOLD 26 = 2'-6" 60 B.F. = 6'-0" BI-FOLD

ALL INTERIOR DOOR HEIGHTS ARE TO BE DETERMINED BY

MIN. OF 5" LAP ON ALL STEEL REINFORCING BARS. FOUNDATION: 2-STORY BRG. FOOTING INDICATES 1-HR. FIREWAL INDICATES 2-AR PIREW

Total Living:

Total Area:

FROM 0'-0" FIN FLR. (U.N.O.) Area Tabulations 679 s

1st floor: 976 sf 2nd floor: 1,655 sf 376 s 2,067


Floor Plan


FLOOR PLANS SCALE: 1/4" = 1'-0"

A6



(Standard)
SCALE: 1/4" = 1'-0"

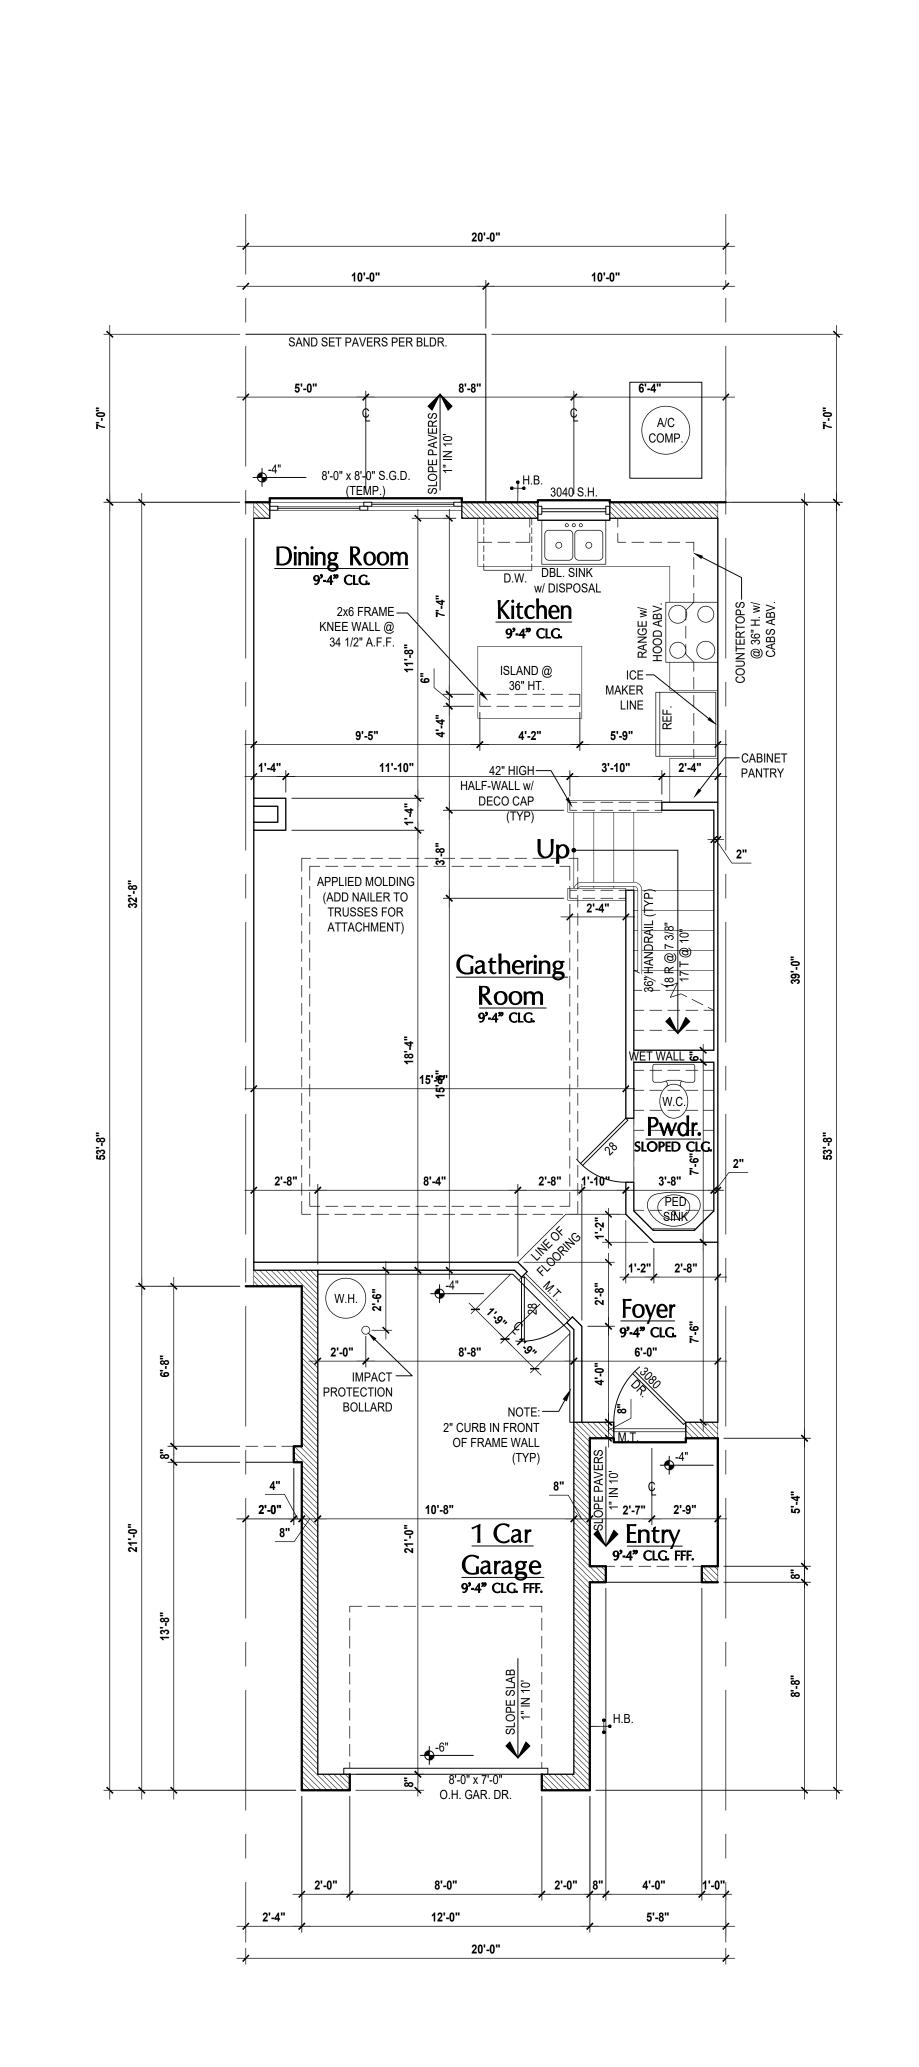

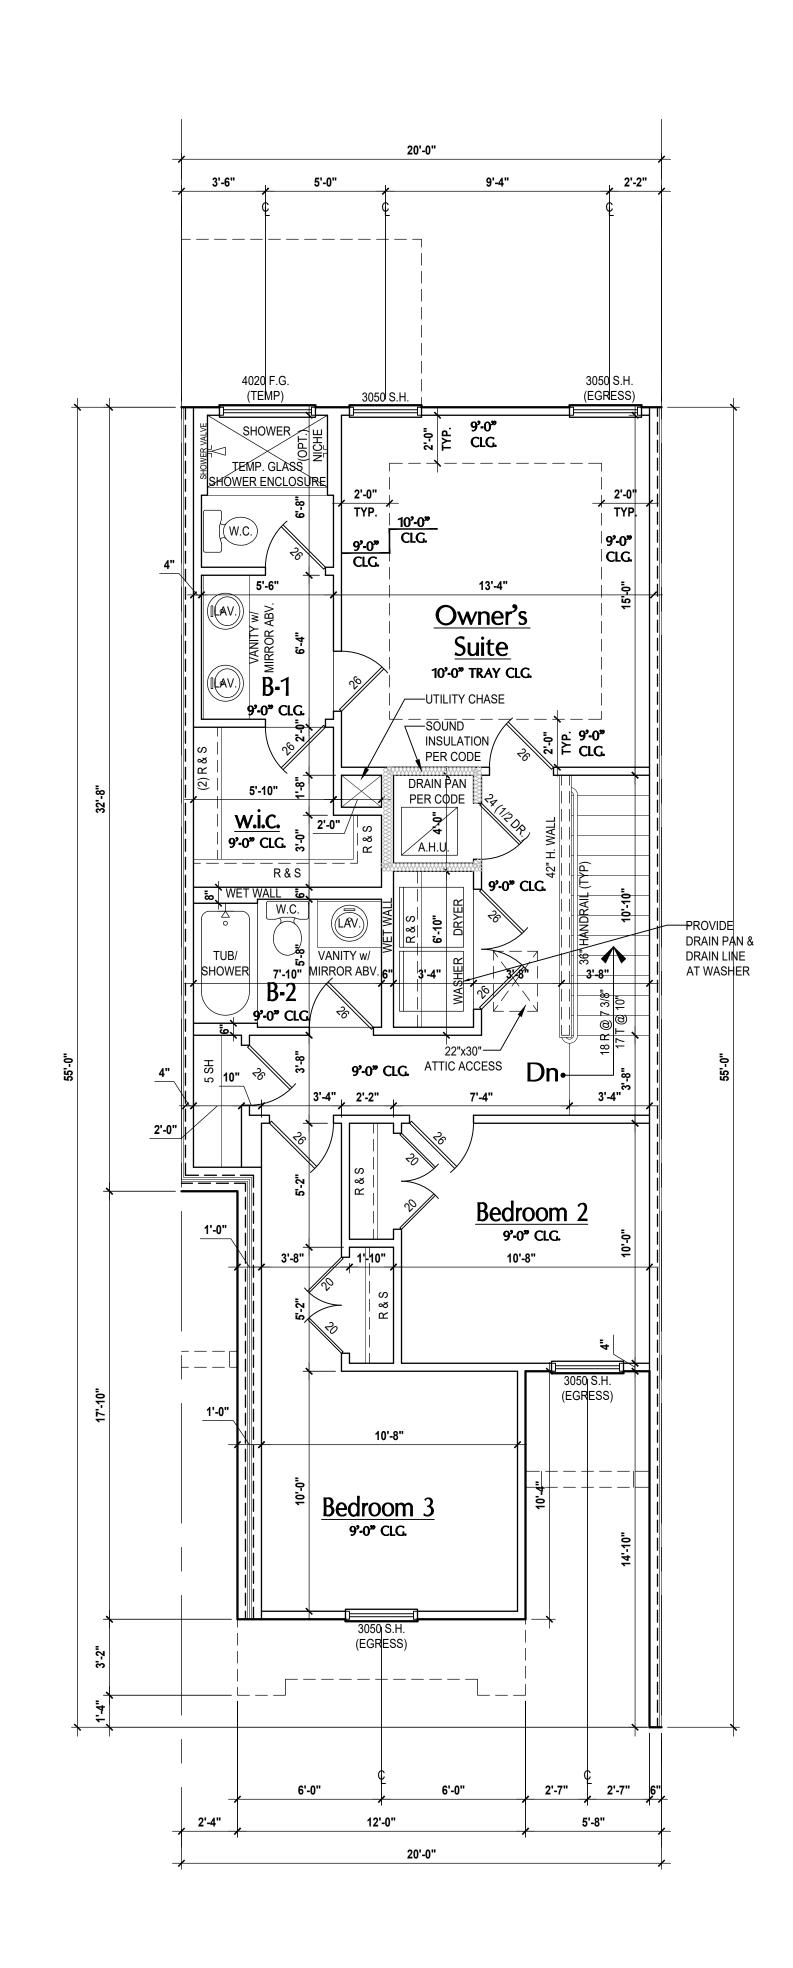

Carter- First Floor Plan

(Standard)
SCALE: 1/4" = 1'-0"

Carter- Second Floor Plan (Standard)
SCALE: 1/4" = 1'-0"

GENERAL NOTES KEY:

TEMP - TEMPERED GLASS FR - FRENCH DOORS SH - SINGLE HUNG SL - SIDE LIGHT DH - DOUBLE HUNG G - FIXED GLASS CSMT- CASEMENT TR - TRANSOM HR - HORIZONTAL ROLLER GB - GLASS BLOCK PKT - POCKET DOOR BF - BIFOLD SVC - SERVICE DOOR

CONTRACTOR TO VERIFY ALL DIMENSIONS ON JOB SITE. DO NOT SCALE PRINTS! CONSTRUCTION TO BE FROM CALCULATED DIMENSIONS ONLY. ANY DISCREPANCIES OR ERRORS TO BE REPORTED PROMPTLY TO SUPERVISOR FOR

MECHANICAL EQUIP. LOCATIONS WILL BE DETERMINED BY COMMUNITY AND COUNTY CODES.

A/C CONDENSER UNIT TO BE ANCHORED TO SLAB PER CODE FBC-R M1307.2 & FBC-M 304, AND SHALL BE SUPPORTED ON CONCRETE SLAB OR OTHER APPROVED MATERIAL NOTE LESS THAN 3" ABOVE ADJOINING GROUND, PER FBC-R M1305.1.4.1

PROVIDE RECESS H&C WATER W/ DRAIN @ WASHER SPACE. VENT DRYER THRU EXTERIOR WALL U.N.O.

PROVIDE COLD WATER LINE FOR ICE MAKER LINE @ REF. PROVIDE RECESS H&C WATER W/ DRAIN @ WASHER SPACE.

SAG RESISTANT DRYWALL ON ALL CEILINGS.). PULL ALL DIMENSIONS FROM THE REAR OF PLAN.

. REFER TO EXTERIOR ELEVATIONS & TYP. DETAIL SHEETS FOR EXTERIOR WALL FINISH SPEC'S.

REFER TO DETAIL SHEETS FOR FLASHING REQUIREMENTS AT ALL WOOD TO MASONRY INTERFACES.

3. ALL INTERIOR FRAME WALL DIMENSIONS TO BE 3 $\frac{1}{2}$ " U.N.O.

I. ALL EXTERIOR BLOCK WALL DIMENSIONS TO BE 7 $\frac{1}{2}$ " U.N.O. 5. C.M.U. & FRAME WALL SYSTEM SEGMENTS WHICH HAVE AN UNINTERRUPTED LENGTH OF 12'-0" OR MORE SHALL BE

CONSIDERED SHEAR WALL SWS = SHEAR WALL SEGMENTS

ENCLOSED SPACE UNDER STAIRS THAT IS ACCESSED BY A DOOR OR ACCESS PANEL SHALL HAVE WALLS, UNDER-STAIR SURFACE AND ANY SOFFITS PROTECTED ON THE ENCLOSED SIDE WITH 1/2-INCH (12.7 MM) GYPSUM BOARD.

. GARAGE DOOR TO BE CERTIFIED BY MFR. FOR MIN. 150 M.P.H. 3. ALL TUB & SHOWER UNITS WILL HAVE ANTI-SCALDING DEVICES

O. ALL OPERABLE WINDOWS LOCATED MORE THAN 72" ABV. SURFACE BELOW SHALL HAVE THE LOWEST PORTION OF WINDOW CLEAR OPENING A MIN. OF 24" ABOVE FINISHED FLOO

BEING SERVER PER (FBC-R312.2).). SEE COLOR SHEET FOR INTERIOR DOOR HEIGHT

REQUIREMENTS. . SPECIALTY WINDOWS/DOORS, FIXED GLASS WINDOWS, AND

TRANSOMS ARE NOTED ON PLANS. 2. ALL DOORS & WINDOWS THAT ARE EGRESS WILL BE LABELED

AS SUCH AND CONFORM TO FBC R310.2 EERO SOIL TESTING IS RECOMMENDED, BUT IS NOT REQUIRED. THE DESIGN TEAM AT MJS & E.O.R STRONGLY RECOMMEND A SOIL TEST TO CONFIRM SOIL BEARING CAPACITY AND SURFACE GEO-TECHNICAL CONDITIONS. FOOTINGS SHALL BEAR ON UNDISTURBED SOIL A/O PROPERLY COMPACTED FILL (2000 PS MIN.). FILL MATERIAL SHALL BE COMPACTED TO 95% DENSITY

4. OPENING BETWEEN GARAGE AND RESIDENCE SHALL BE EQUIPPED WITH A 20 MIN. FIRE RATED SOLID WOOD OR HONEYCOMB CORE STEEL DOOR NOT LESS THAN 1 3/8" THICKNESS AS PER FBC-R302.5.1.

OF A STANDARD PROCTOR. TO BE VERIFIED BY GENERAL

. 1/2" GYPSUM BOARD APPLIED TO THE GARAGE SIDE OF WAI UNDERSIDE OF DECKING. 6. 5/8" TYPE X DRYWALL ON GARAGE CEILING BELOW ANY

CONTRACTOR / OWNER.

HABITABLE SPACE

THERMAL BARRIER: FOAM PLASTIC SHALL BE SEPARATED FRO THE INTERIOR OF A BUILDING BY NOT LESS THAN 1/2-INCH (12.7 MM) GYPSUM WALLBOARD, 23/32-INCH (18.2 MM) WOOD STRUCTURAL PANEL OR A MATERIAL THAT IS TESTED IN ACCORDANCE WITH AND MEETS THE ACCEPTANCE CRITERIA O BOTH THE TEMPERATURE TRANSMISSION FIRE TEST AND THE INTEGRITY FIRE TEST OF NFPA 275.

. ADDRESS NOTIFICATION SHALL BE IN ACCORDANCE w/ SECTION

. ANY EXTERIOR WALL ELECTRICAL, MECHANICAL AND PLUMBIN PENETRATIONS SHOULD BE FITTED WITH QUICKFLASH PANELS . ATTIC ACCESS OPENING SHOULD BE WEATHERSTRIPPED AND INSULATED TO LEVEL EQUIVALENT TO INSULATION ON THE

FILL VOIDS OF UNDERSIDE OF TUBS & SHOWERS WITH INSULATION FOR ACOUSTIC DAMPENING.

SURROUNDING AREAS PER FBCEC R402.2.4.

ADD ACOUSTIC OR VIBRATION ISOLATION DEVICES AT GARAGE DOOR OPENERS THAT ARE ADJACENT TO HABITABLE SPACES

. WHERE WALL TILE IS INSTALLED IN TUB AND SHOWER AREAS, GLASS MAT GYPSUM BACKING PANELS (ASTM C1178), FIBER-REINFORCED GYPSUM PANELS (ASTM C1278), NON-ASBESTOS FIBER-CEMENT BACKER BOARD (ASTM C1288) OR NON-ASBESTOS FIBER MAT REINFORCED CEMENTITIOUS BACKER UNITS (ASTM C1325) SHALL BE USED PER FBCR R702.4. PAPER-FACED GYPSUM BOARD SHALL NOT BE USED.

2050 = 2'-0" x 5'-0"

2060 = 2'-0" x 6'-0" ALL WINDOW CALLOUTS ARE MEASURED IN FEET & INCHES AS PER THE EXAMPLE TABLE ABOVE.

DOOR SIZE CALLOUT: 20 = 2'-0" 40 B.F. = 4'-0" BI-FOLD 24 = 2'-4" 50 B.F. = 5'-0" BI-FOLD 26 = 2'-6" 60 B.F. = 6'-0" BI-FOLD

ALL INTERIOR DOOR HEIGHTS ARE TO BE DETERMINED BY

FROM FOUNDATION SLAB TO BOND BEAM. PROVIDE A MIN OF 5" LAP ON ALL STEEL REINFORCING BARS. FOUNDATION: 2-STORY BRG. FOOTIN INDICATES 1-HR. FIREWA INDICATES 2-AH. PIREW

FROM 0'-0" FII FLR. (U.N.O.)

Area Tabulations 1st floor: 2nd floor: 838 st 1,527 sf Total Living: 252 sf

1,873 sf Total Area: opt. lanai:


Floor Plan

SCALE: 1/4" = 1'-0"

DESIGNED BY: MJS FLOOR PLANS


DRAWN BY: C.C.



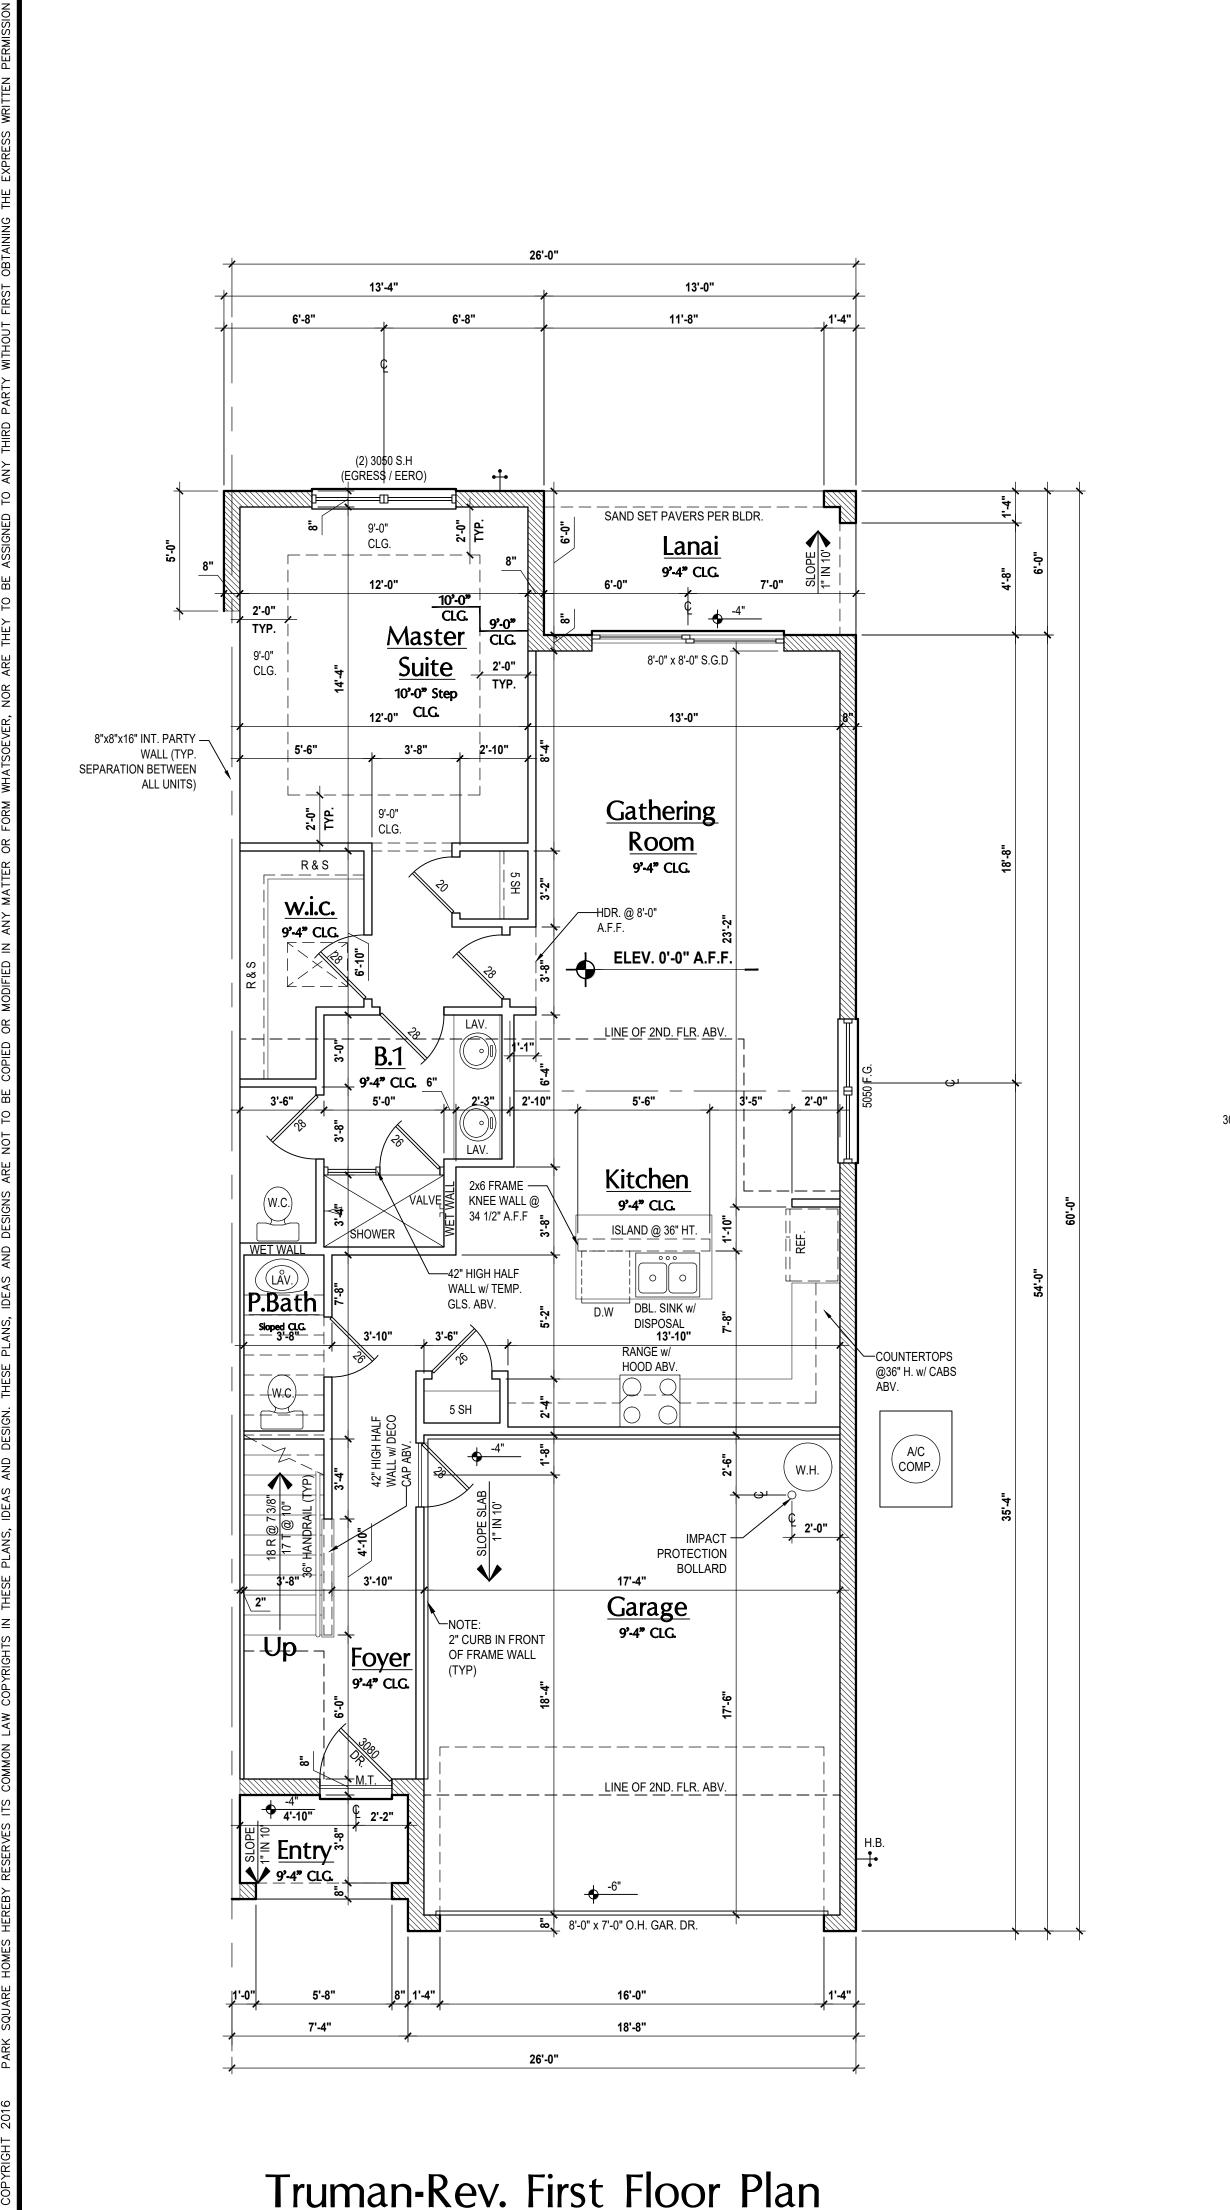


(Standard)

SCALE: 1/4" = 1'-0"

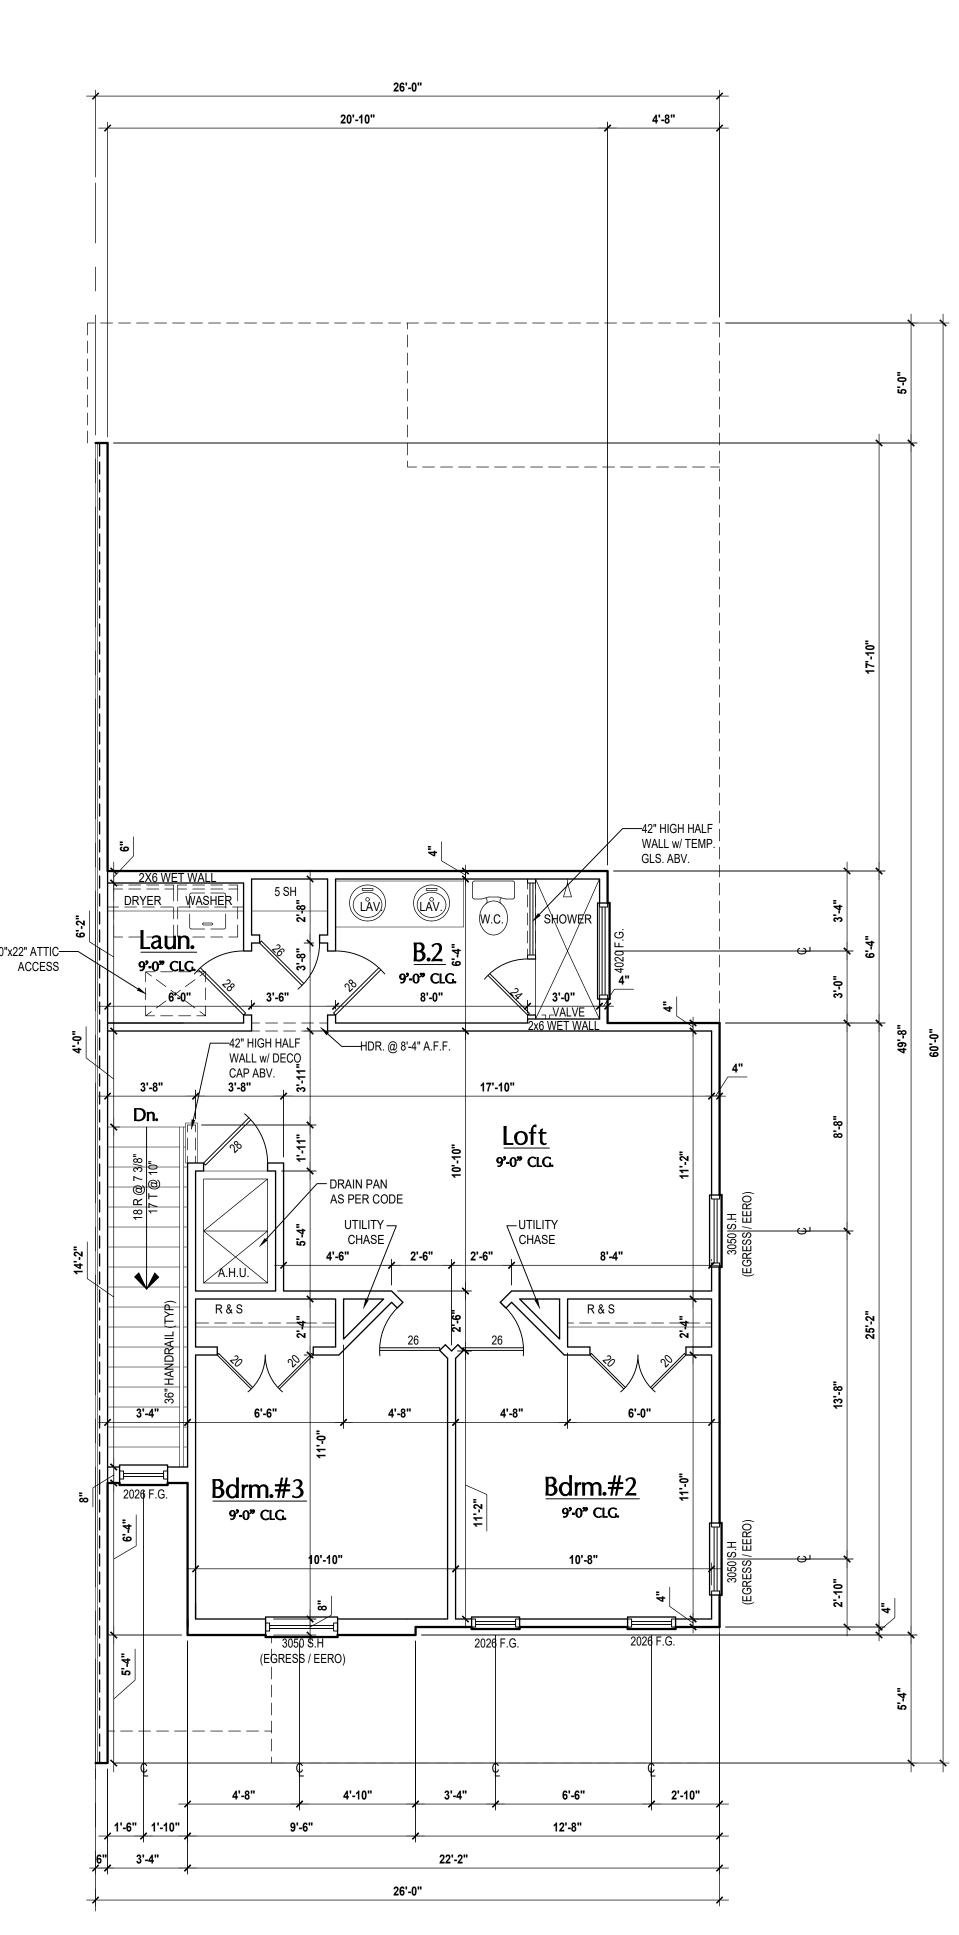


Truman-Rev. Second Floor Plan

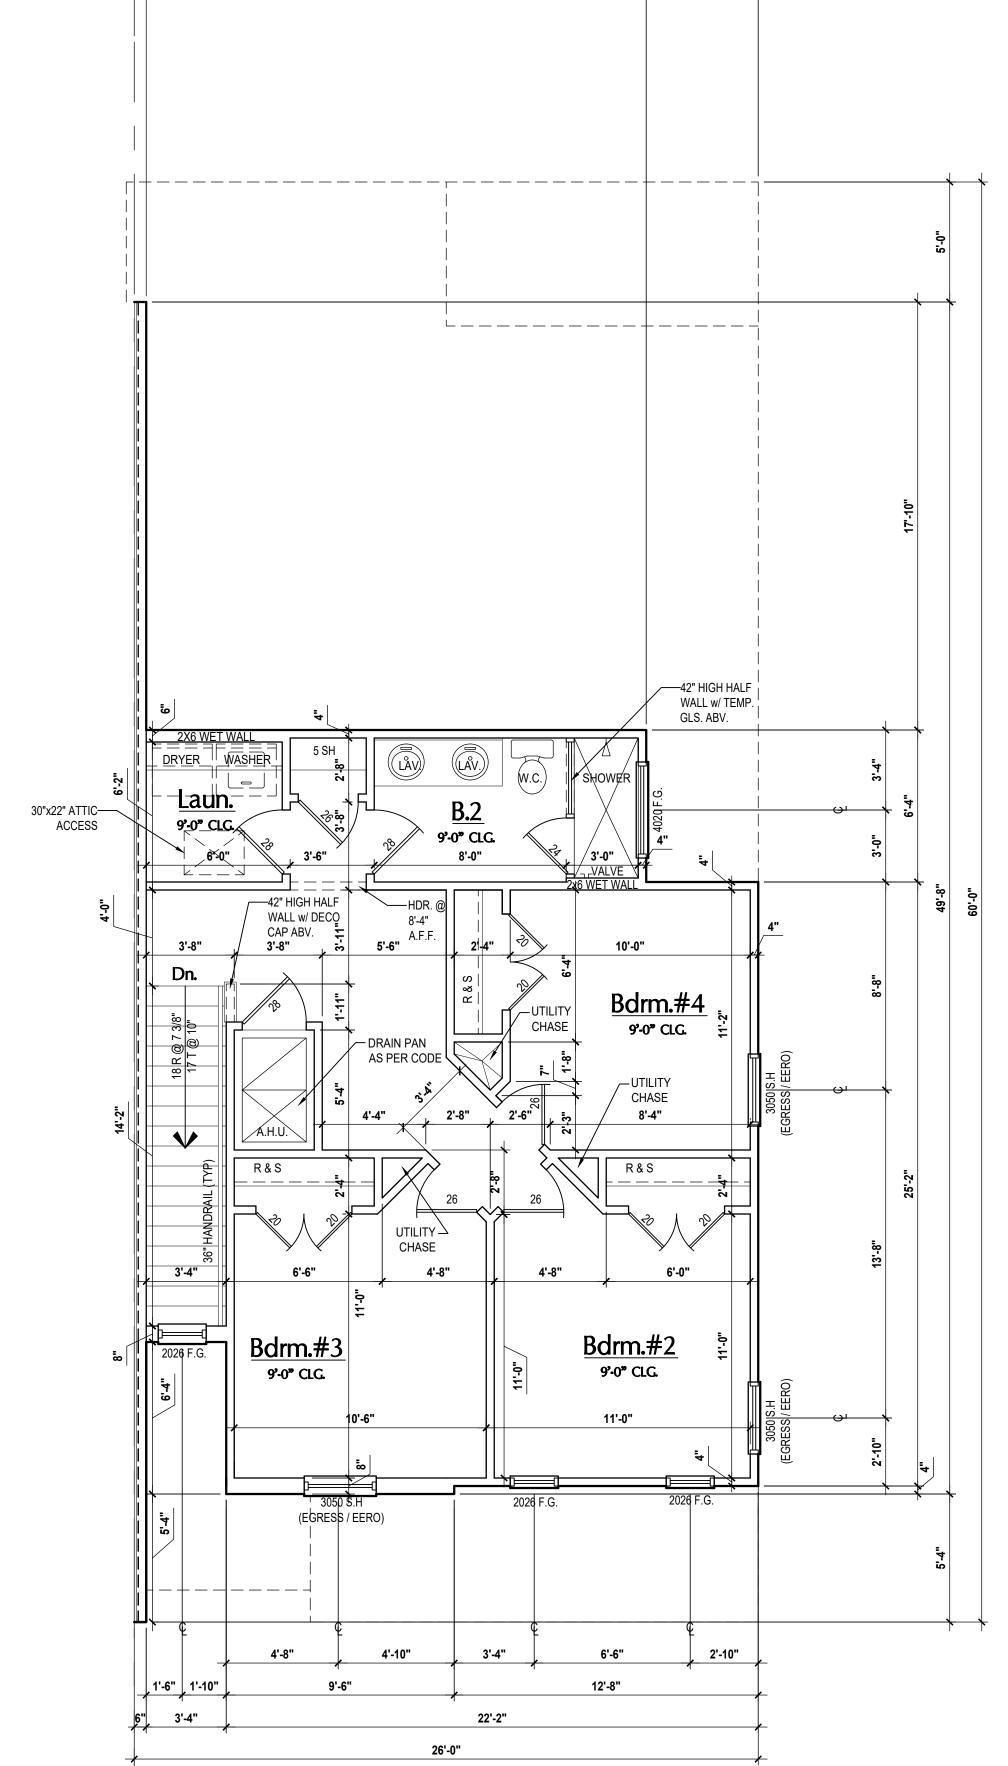

Truman-Rev. Second Floor Plan

(Opt. Bdrm.#4)
SCALE: 1/4" = 1'-0"

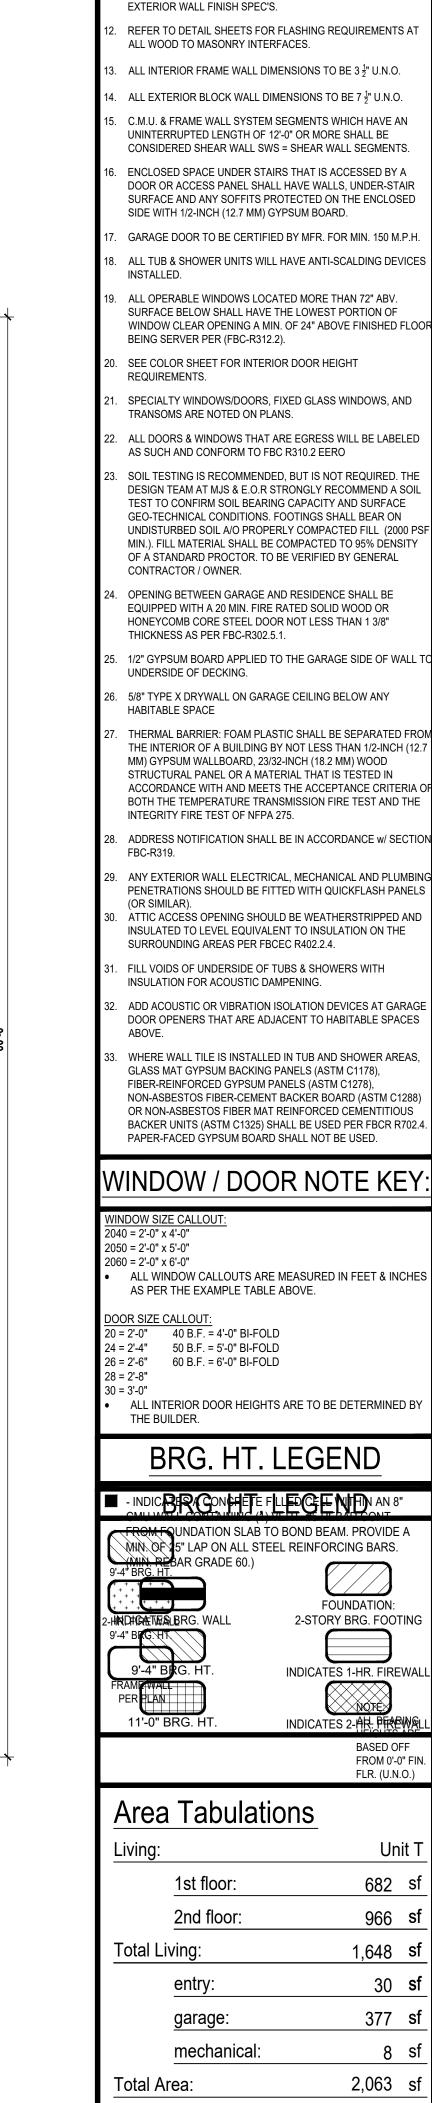


opt. cov. patio:

Floor Plan

SCALE: 1/4" = 1'-0"

DRAWN BY: C.C. DESIGNED BY: MJS

FLOOR PLANS

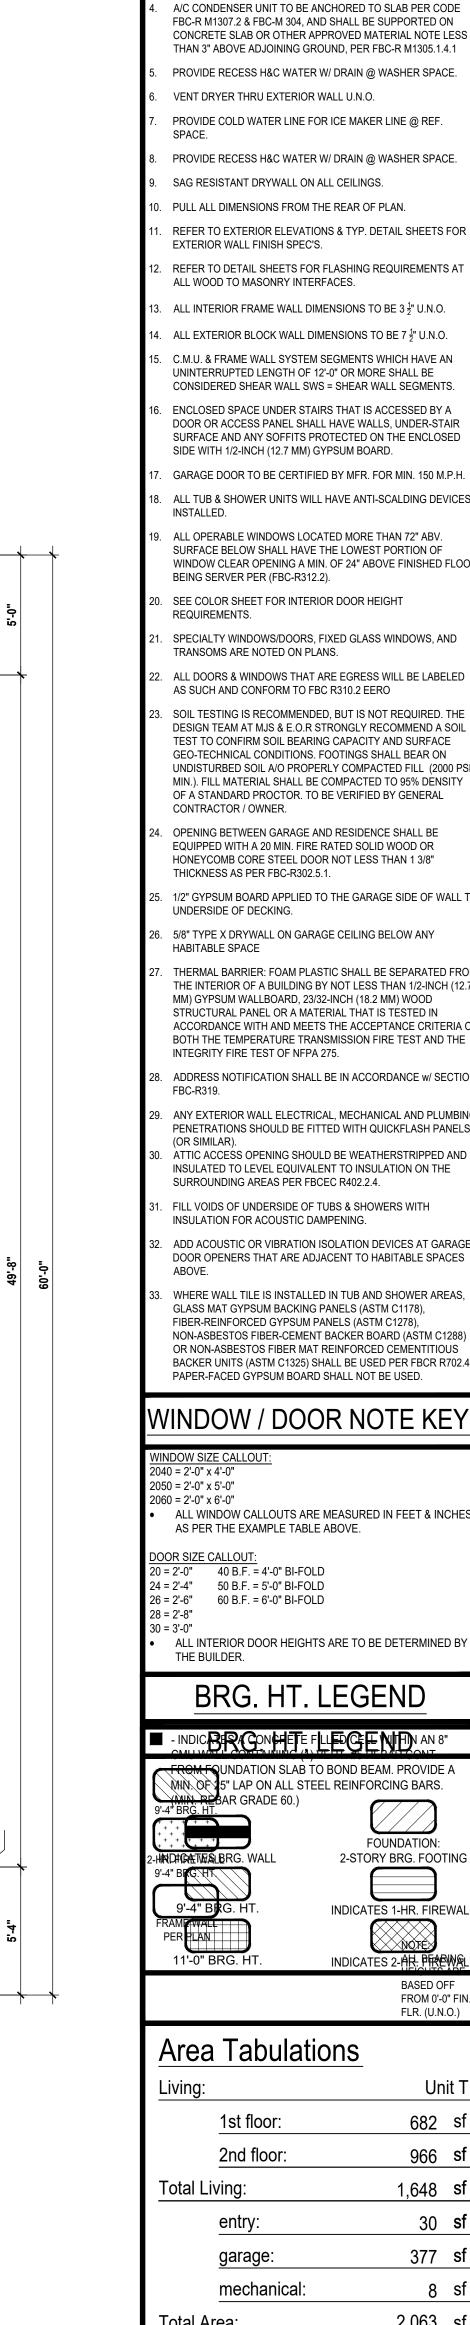

FR - FRENCH DOORS

CSMT- CASEMENT

BF - BIFOLD

TYP. - TYPICAL

SL - SIDE LIGHT


FG - FIXED GLASS

GB - GLASS BLOCK PKT - POCKET DOOR


SVC - SERVICE DOOR

COMMUNITY AND COUNTY CODES.

TR - TRANSOM

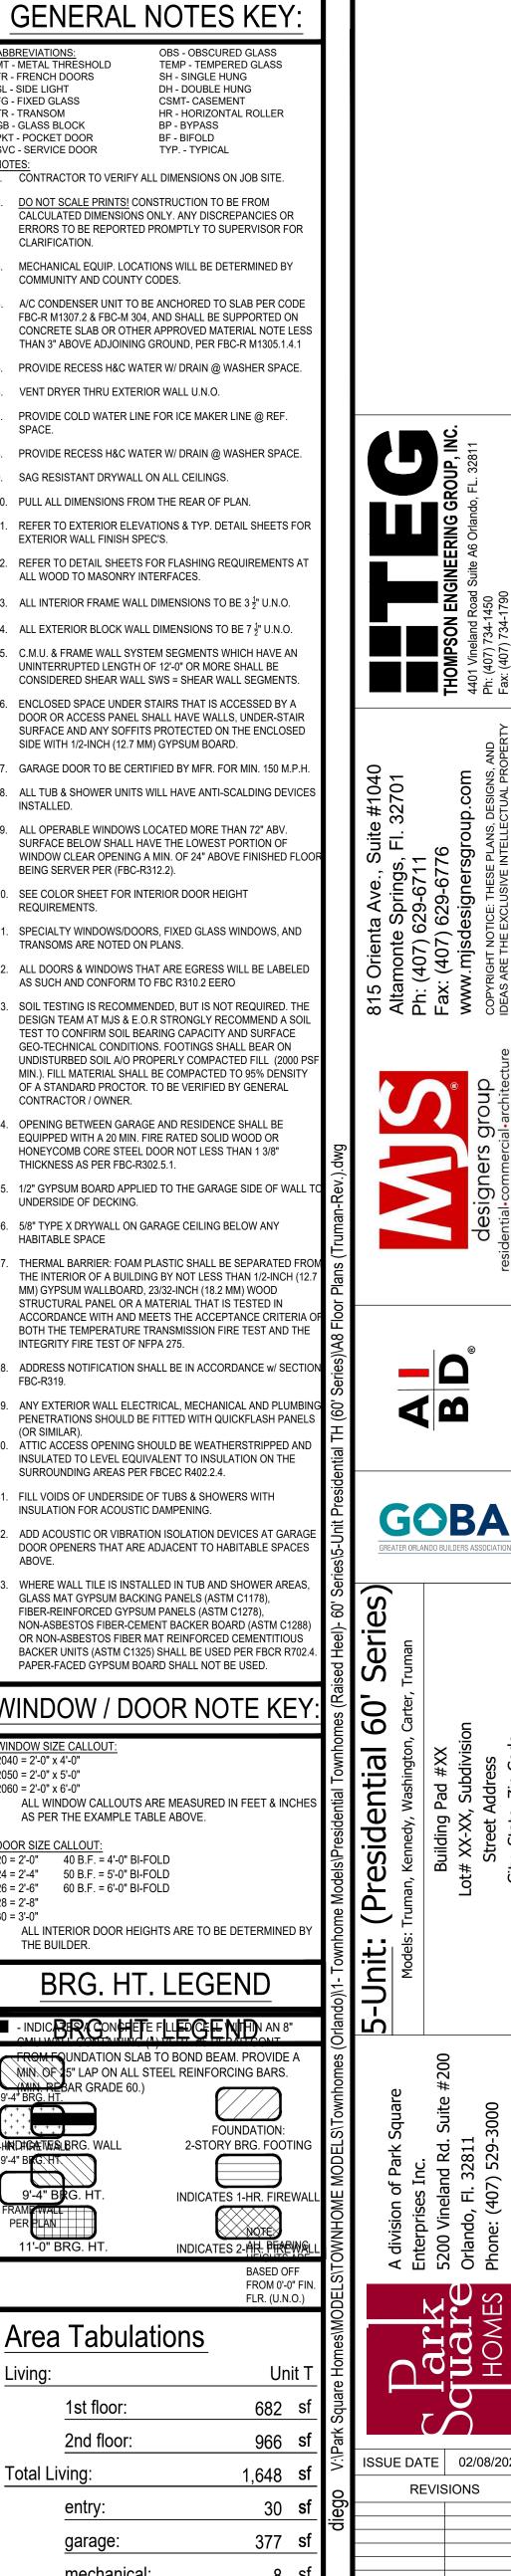



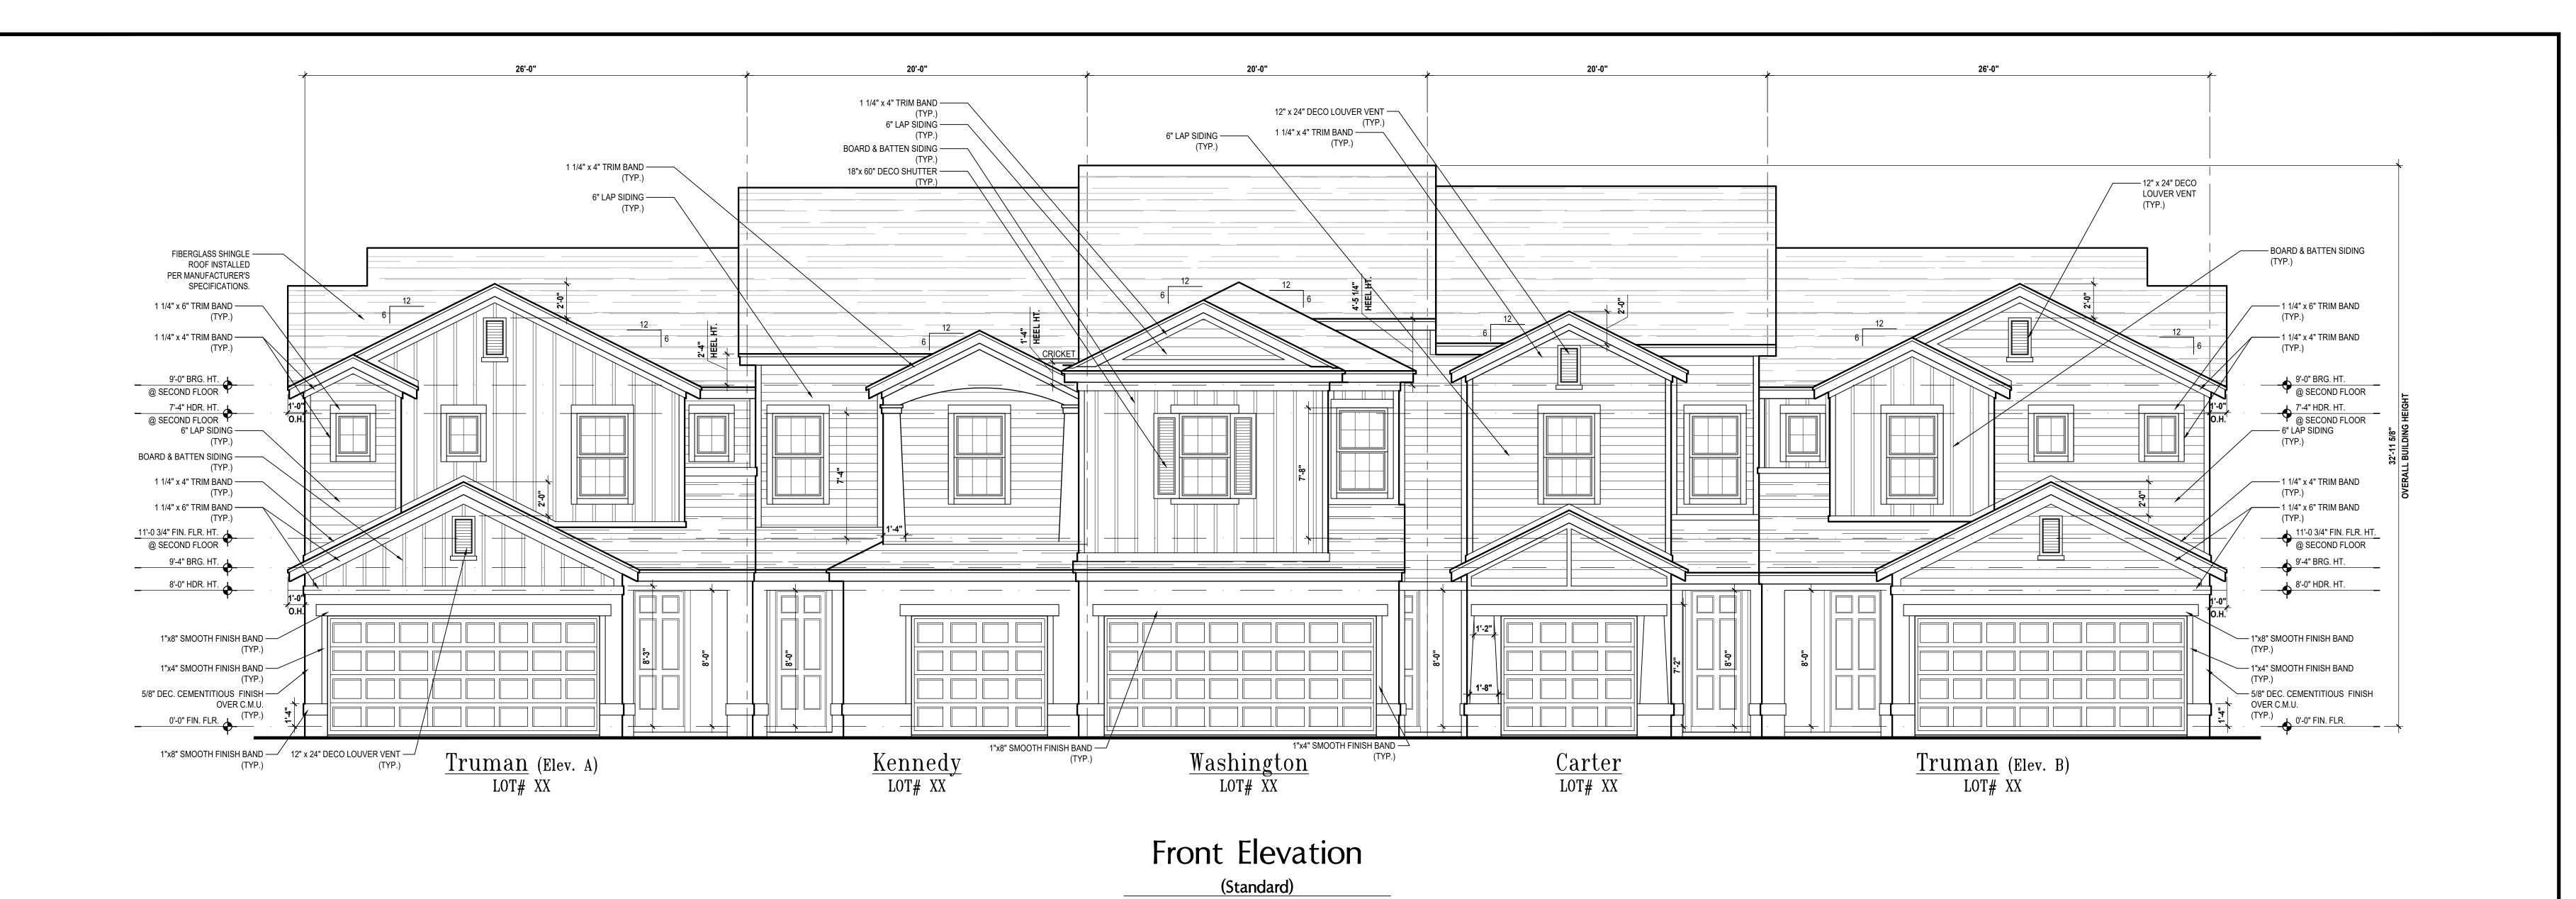

SCALE: 1/4" = 1'-0"



(Standard)

SCALE: 1/4" = 1'-0"





GOBA


REVISIONS

PROJECT: 00-0000
SCALE: AS NOTED
DRAWN BY: C.C. DESIGNED BY: MJS

ELEVATIONS A9

Left Elevation

(Standard)
SCALE: 1/4" = 1'-0"

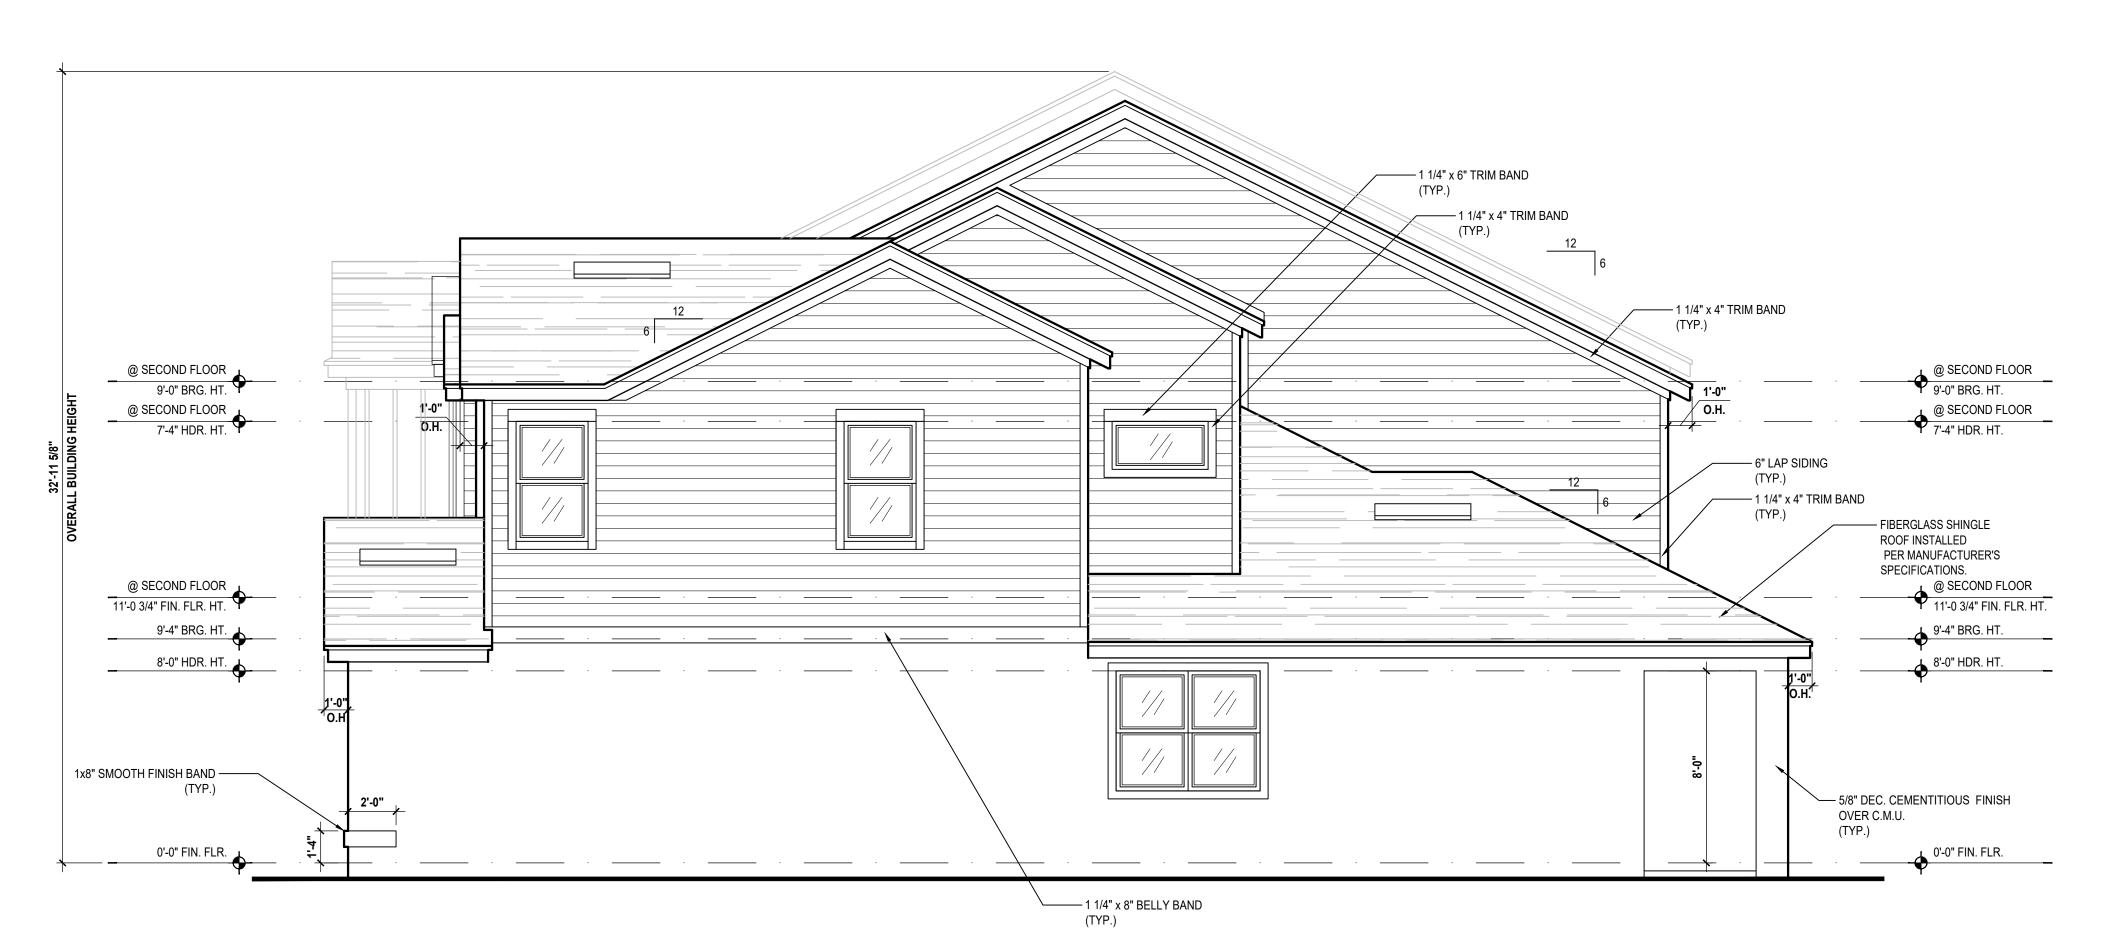

Right Elevation

(Standard)

SCALE: 1/4" = 1'-0"

houzz FIND US ON FACEBOOK & HOUZZ AT MJS CUSTOM HOME DESIGNS









GOBA
GREATER ORLANDO BUILDERS ASSOCIATION

DRAWN BY: C.C. DESIGNED BY: MJS

ELEVATIONS

A10

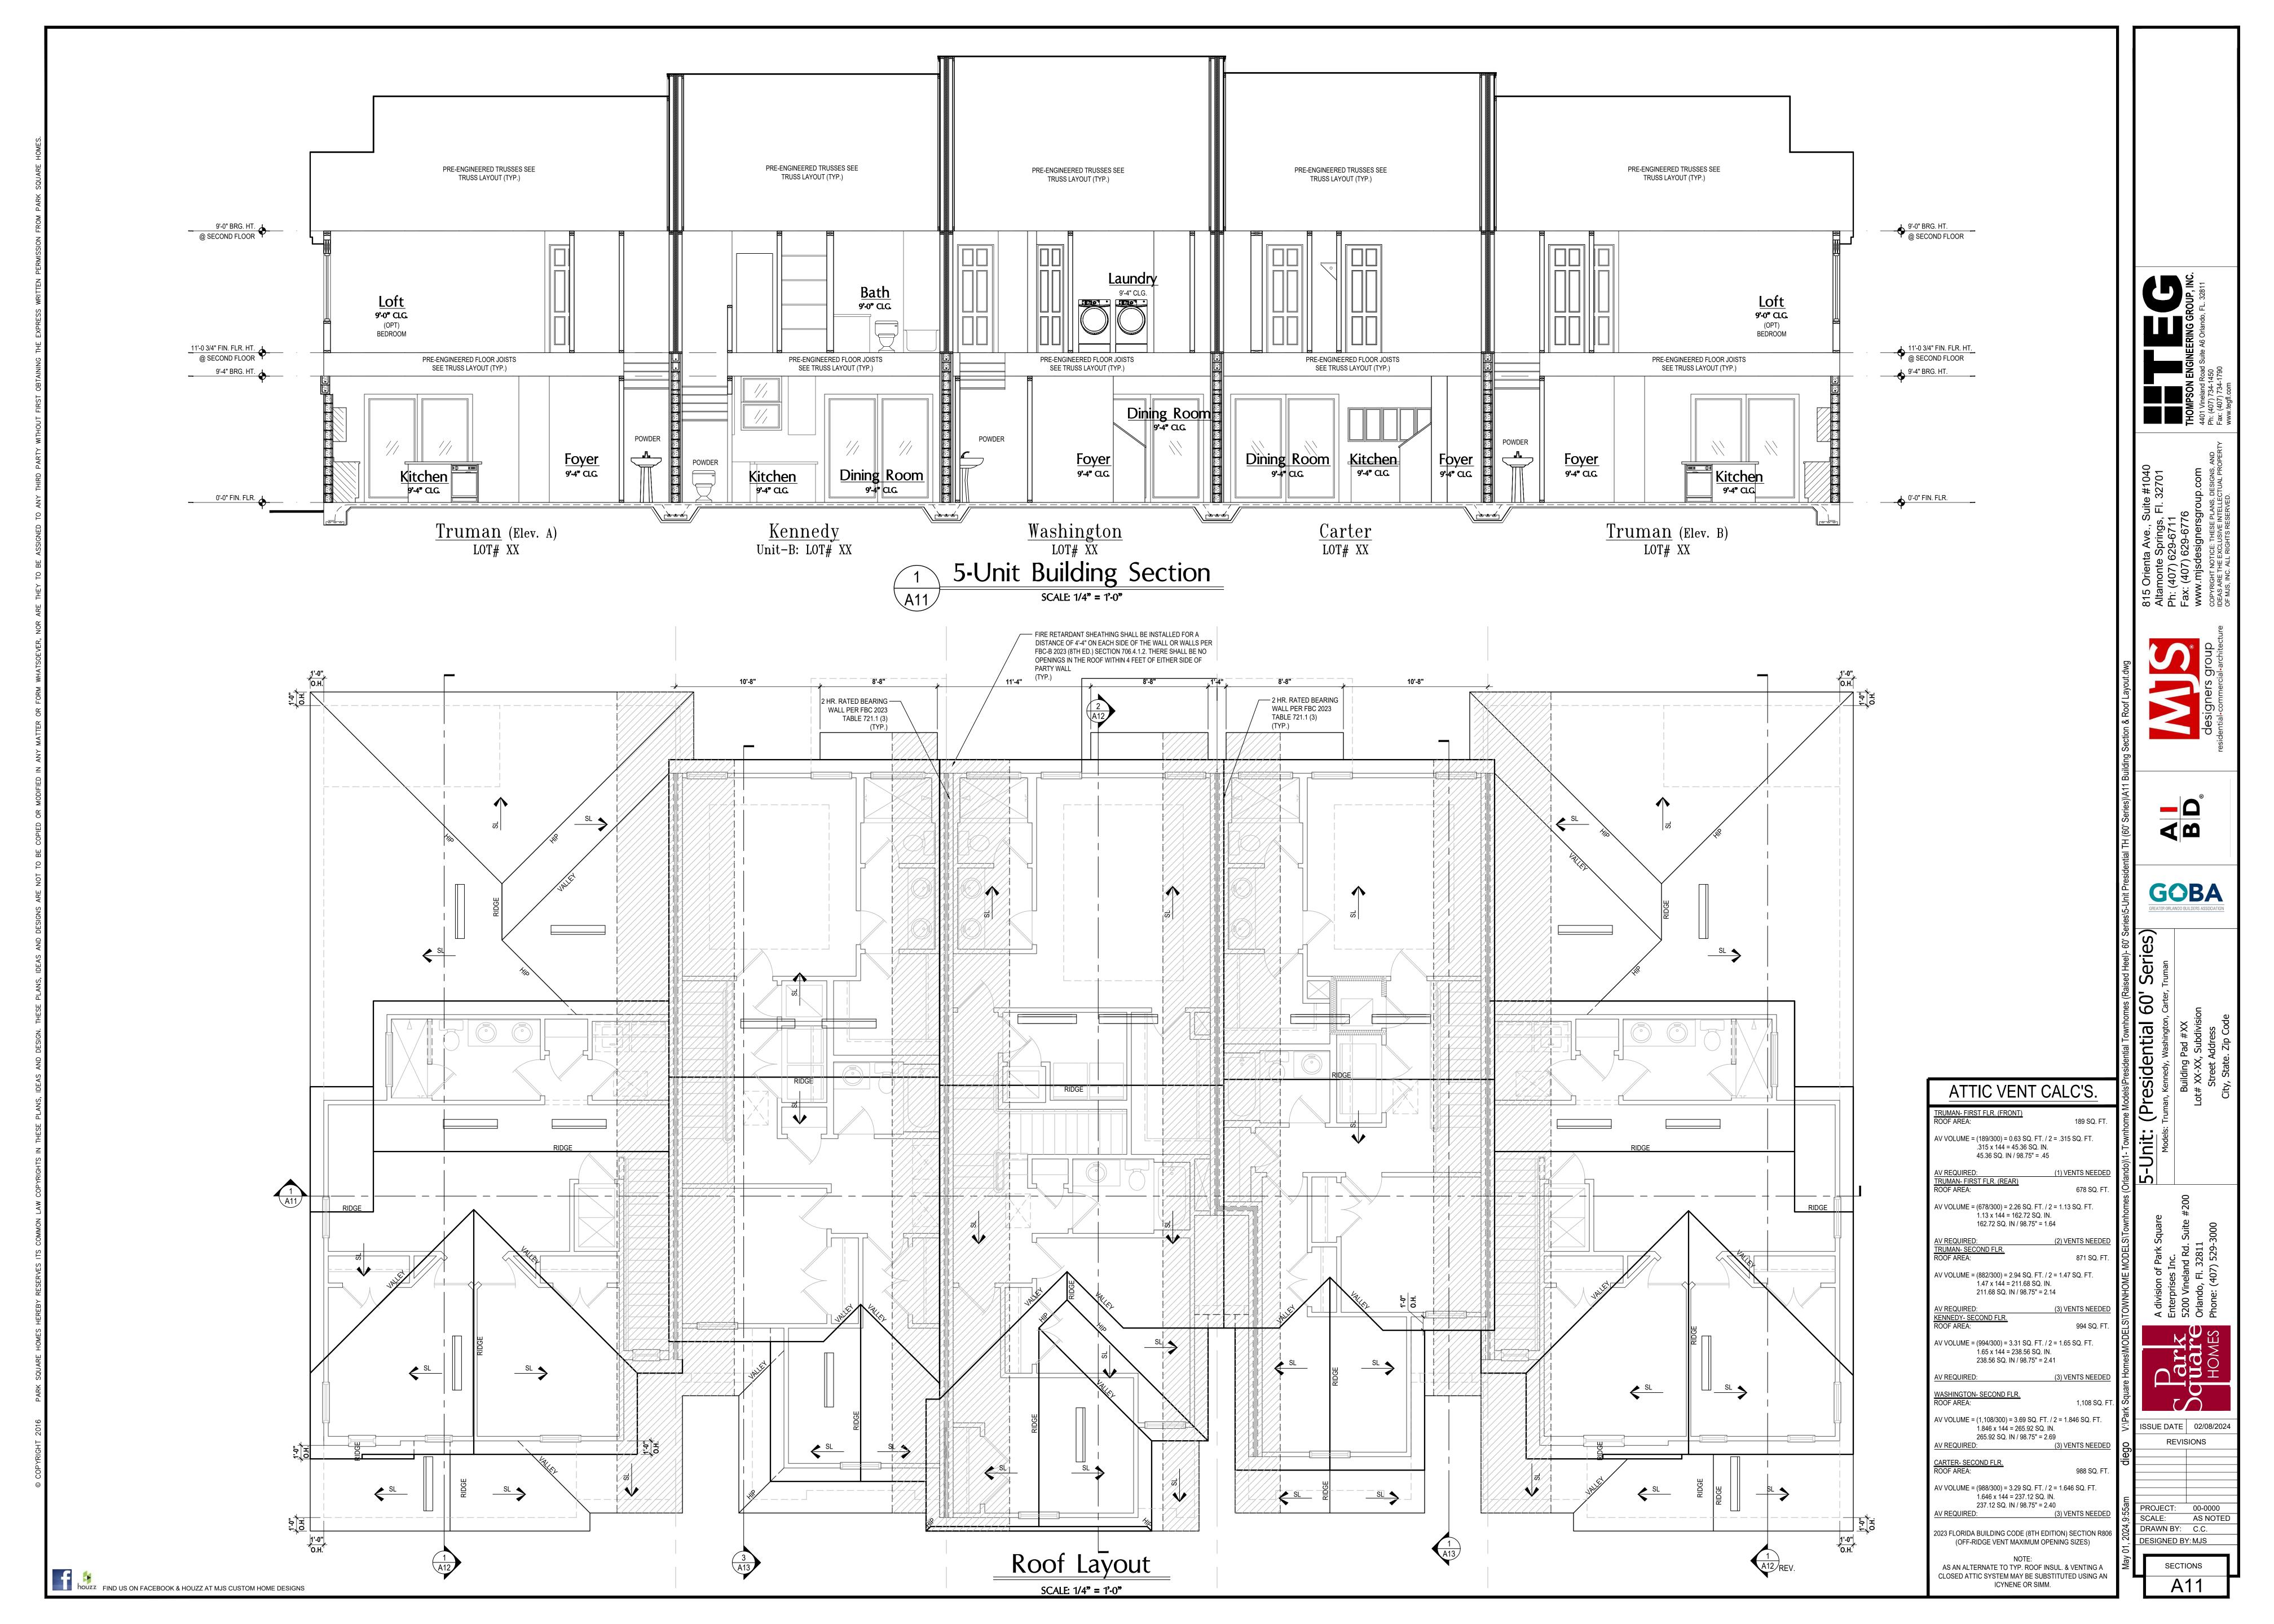

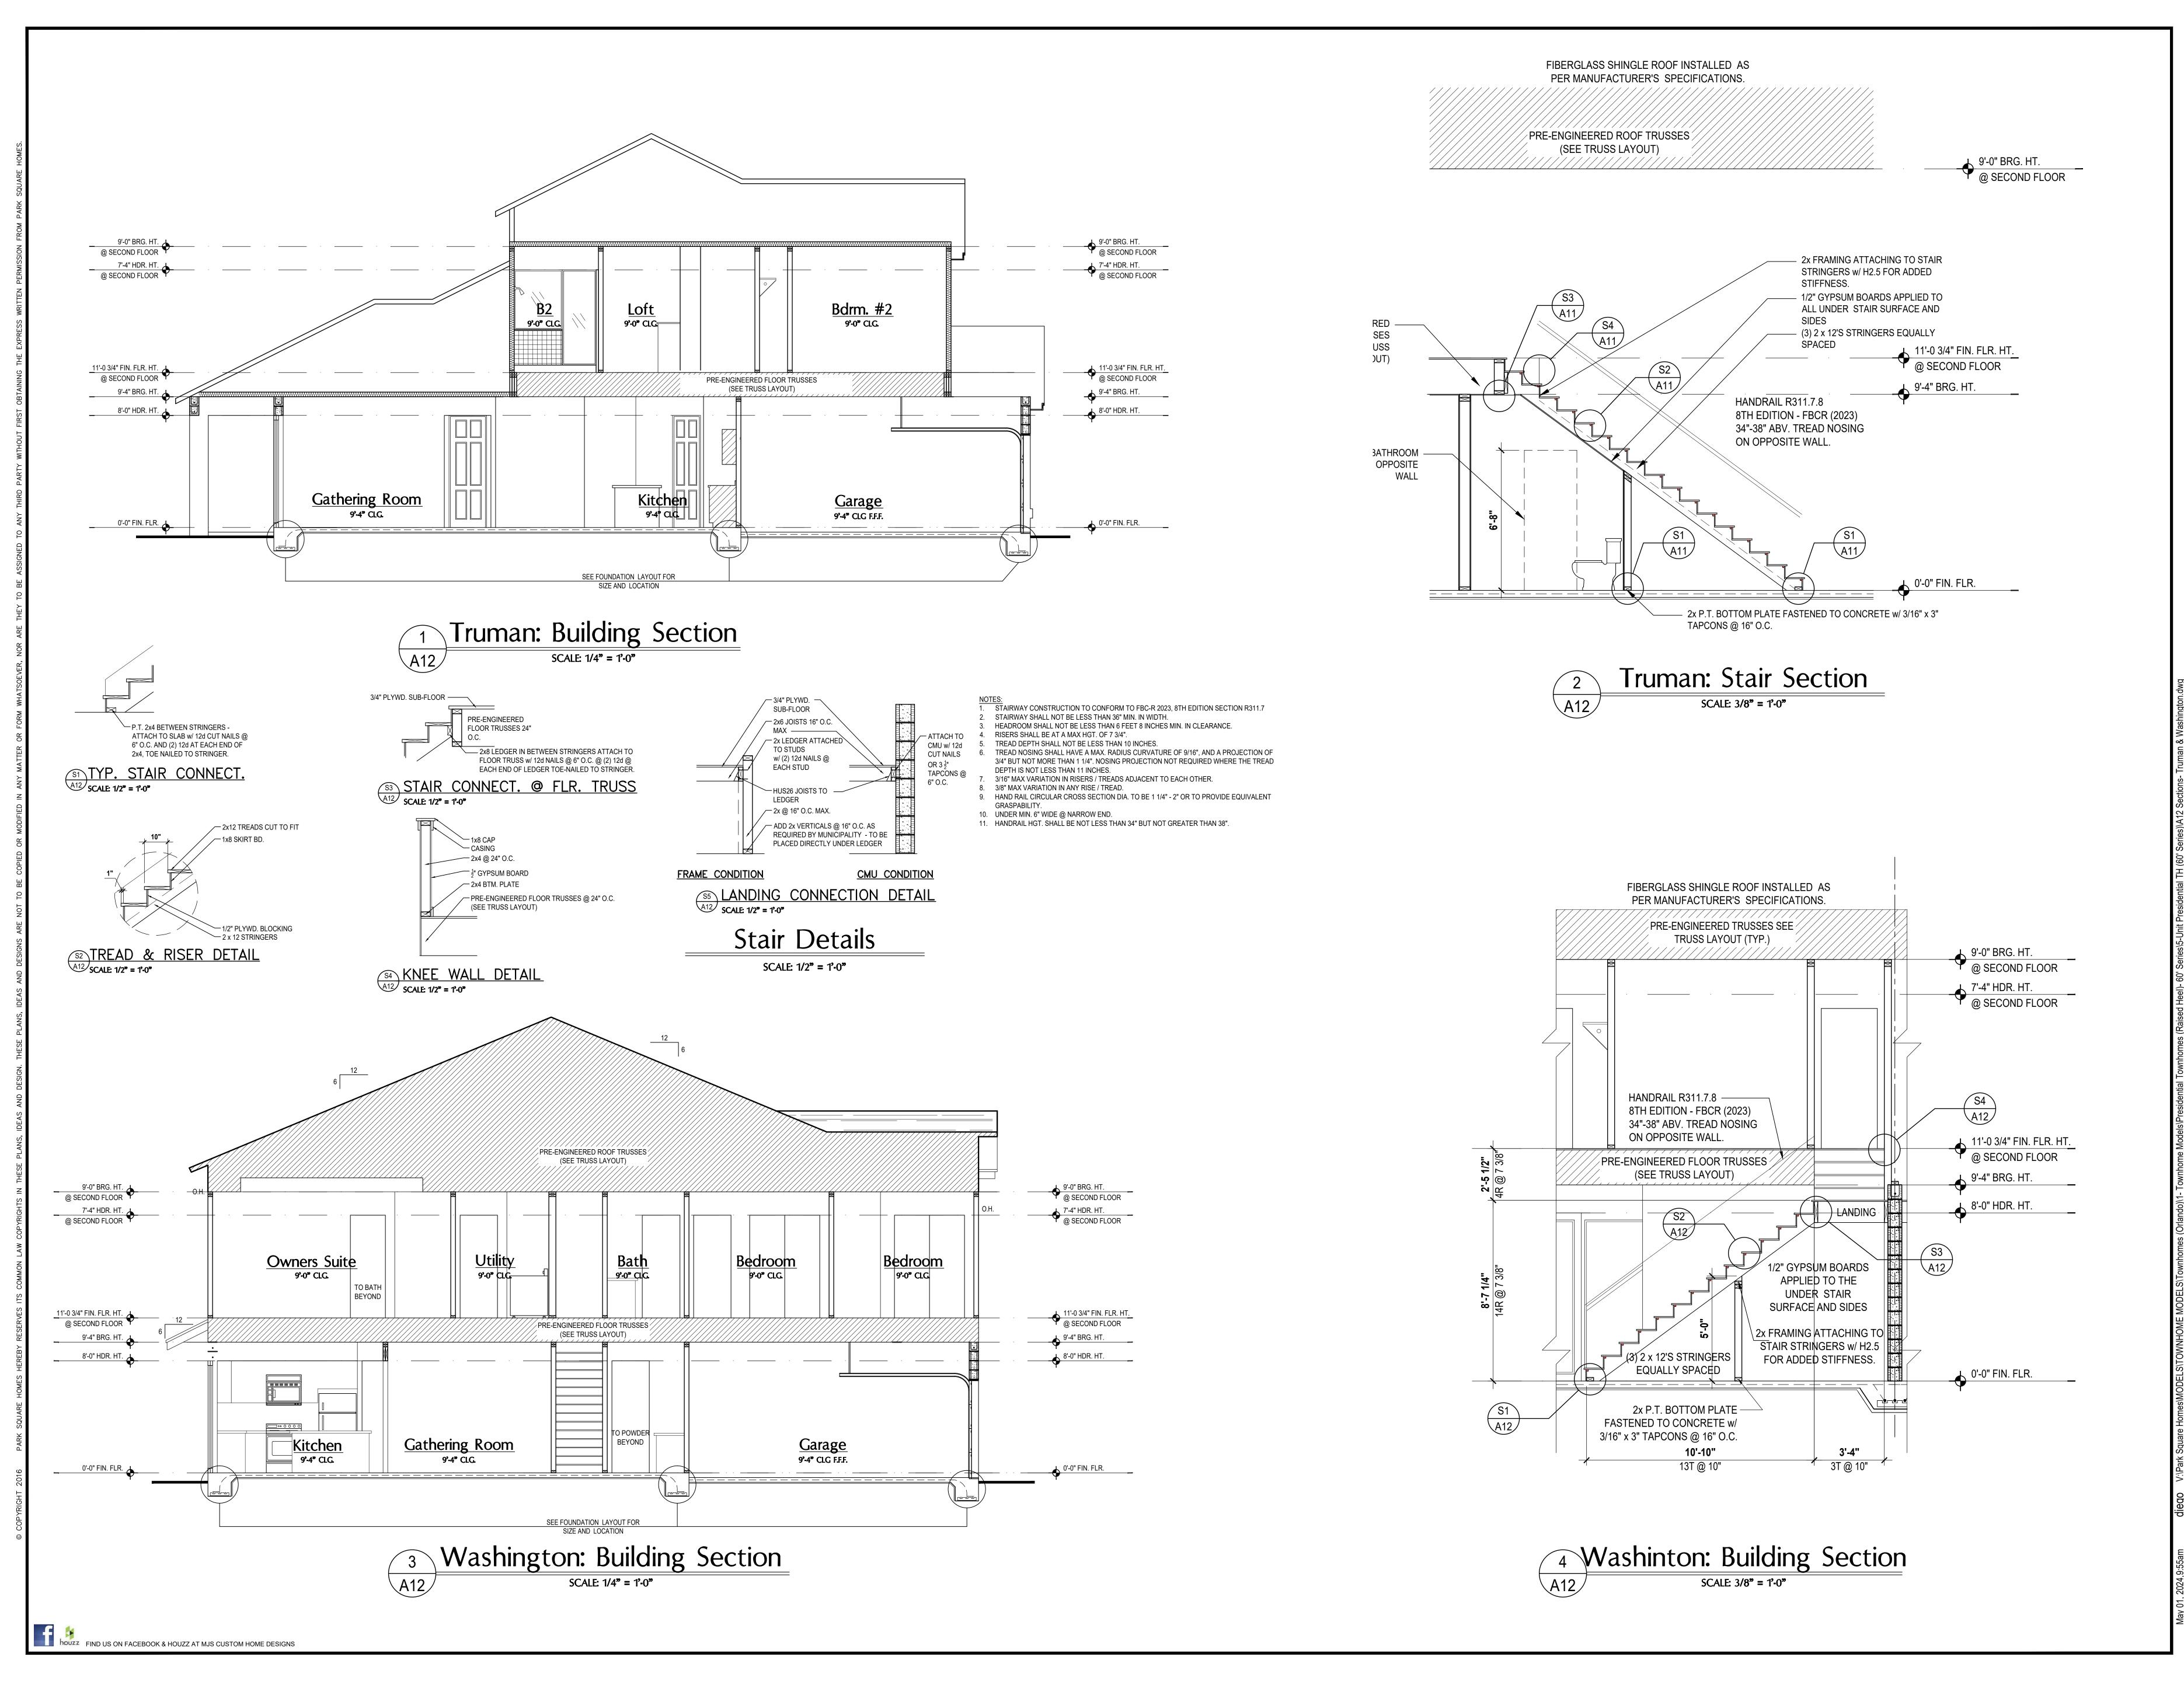

A B **GOBA** SSUE DATE | 02/08/2024


AS NOTED

DRAWN BY: C.C.

DESIGNED BY: MJS


SECTIONS

A12

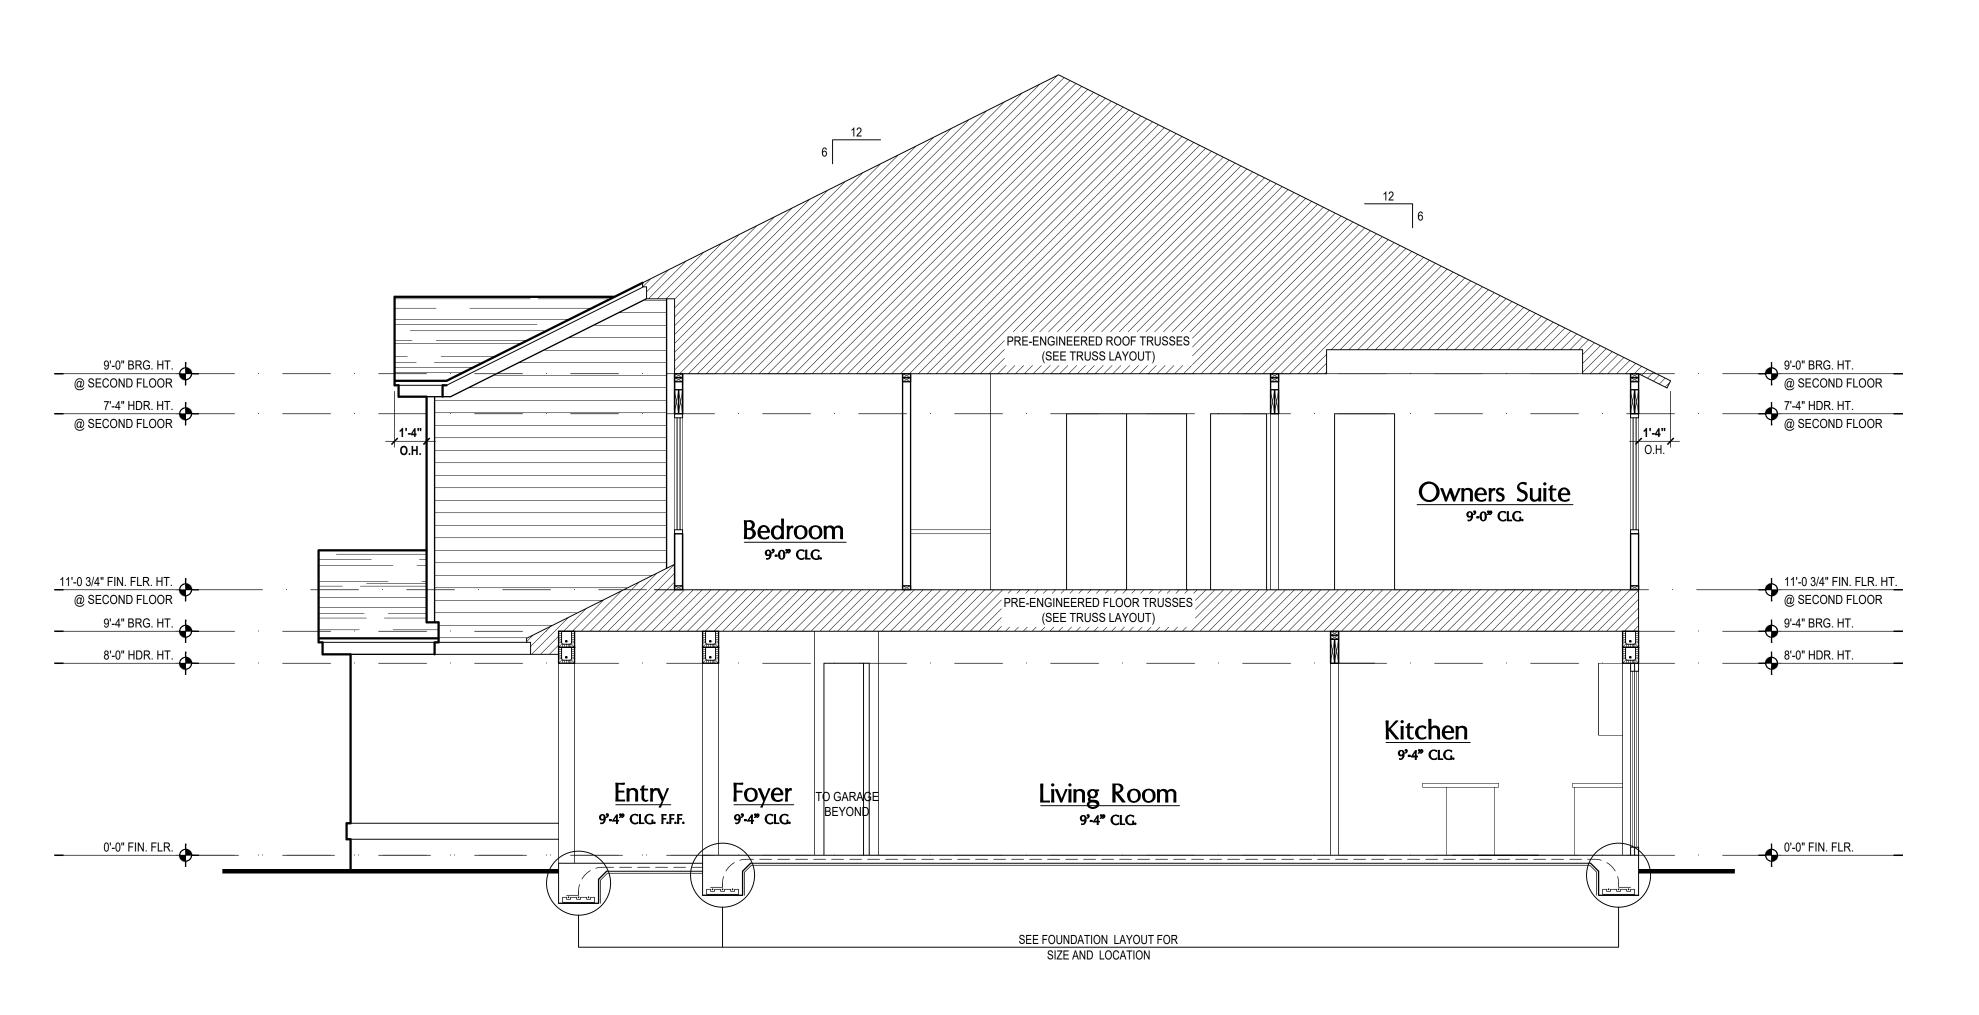


Carter: Building Section

SCALE: 1/4" = 1'-0"

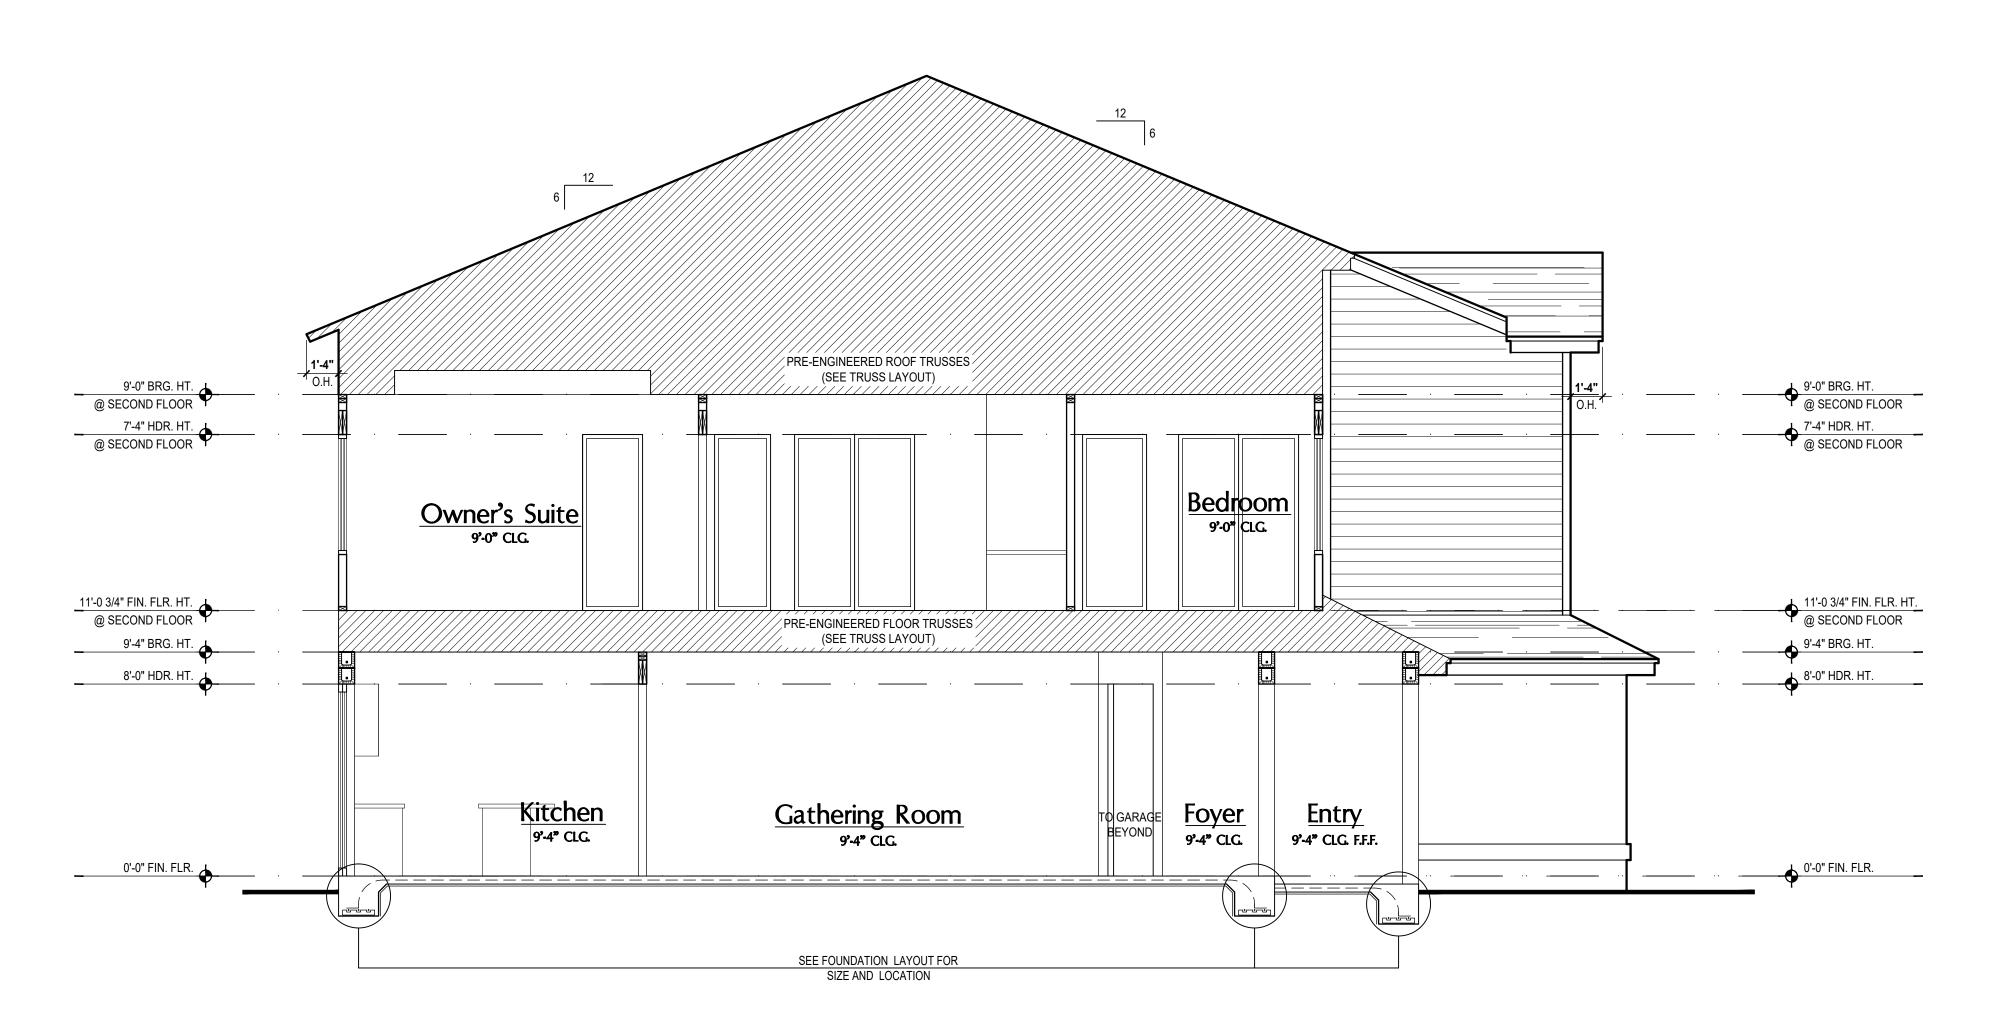


3 Kennedy: Building Section
SCALE: 1/4" = 1'-0"

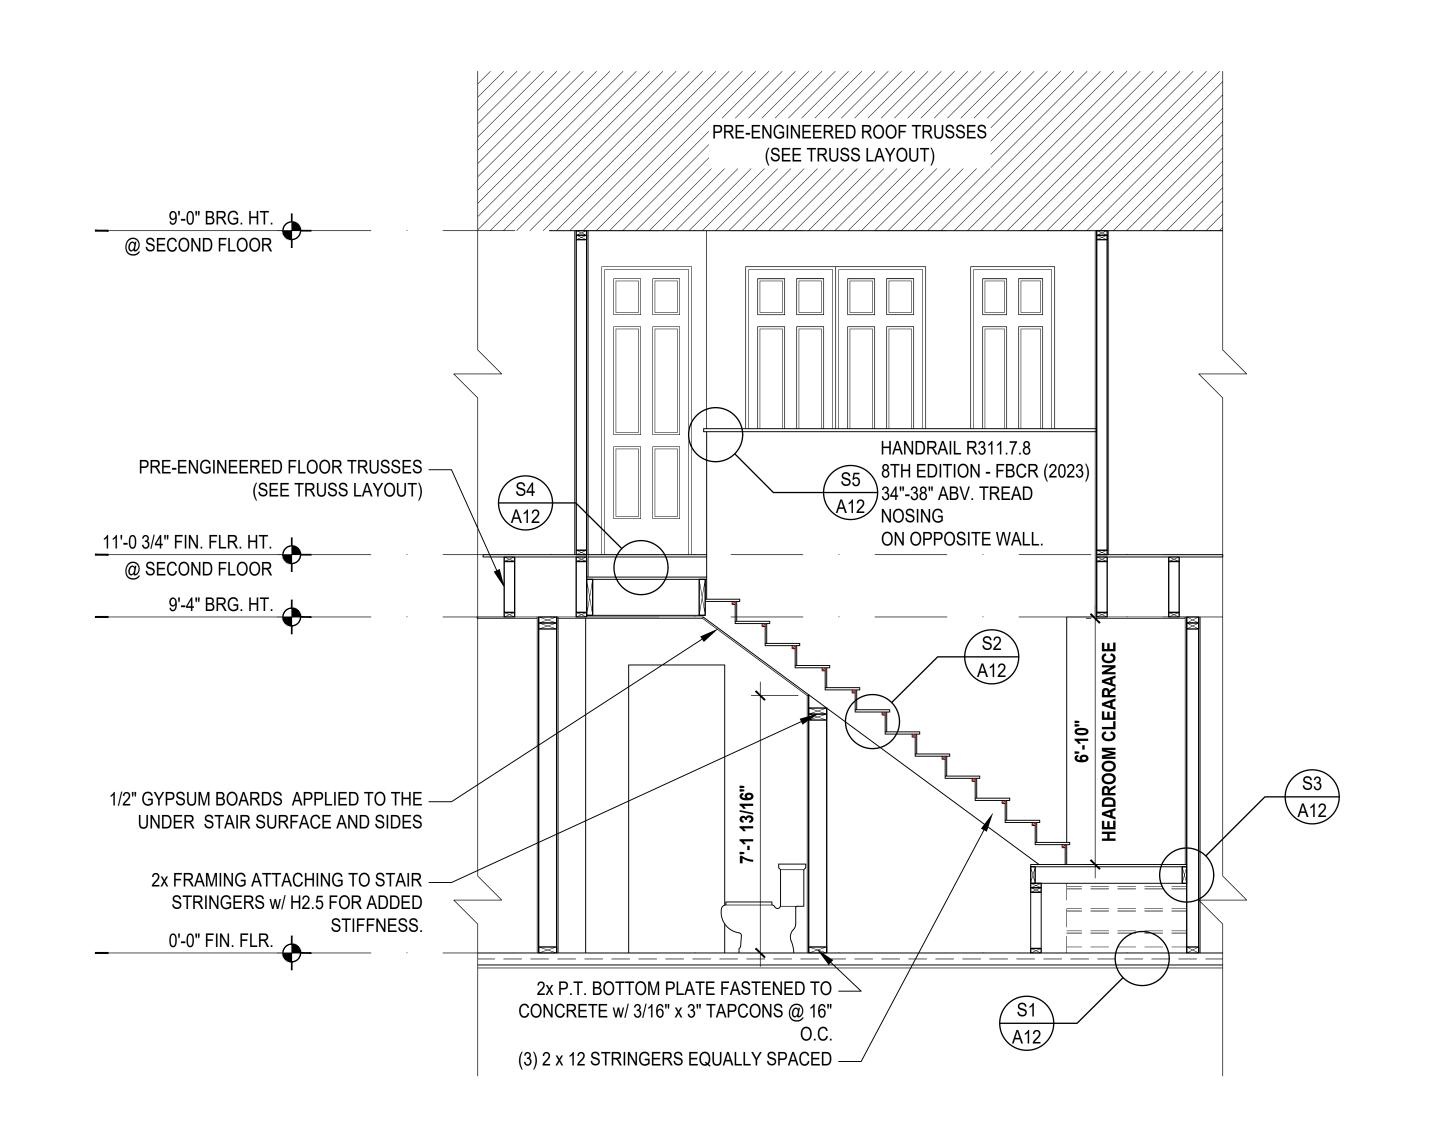

Carter: Stair Section

SCALE: 3/8" = 1'-0"

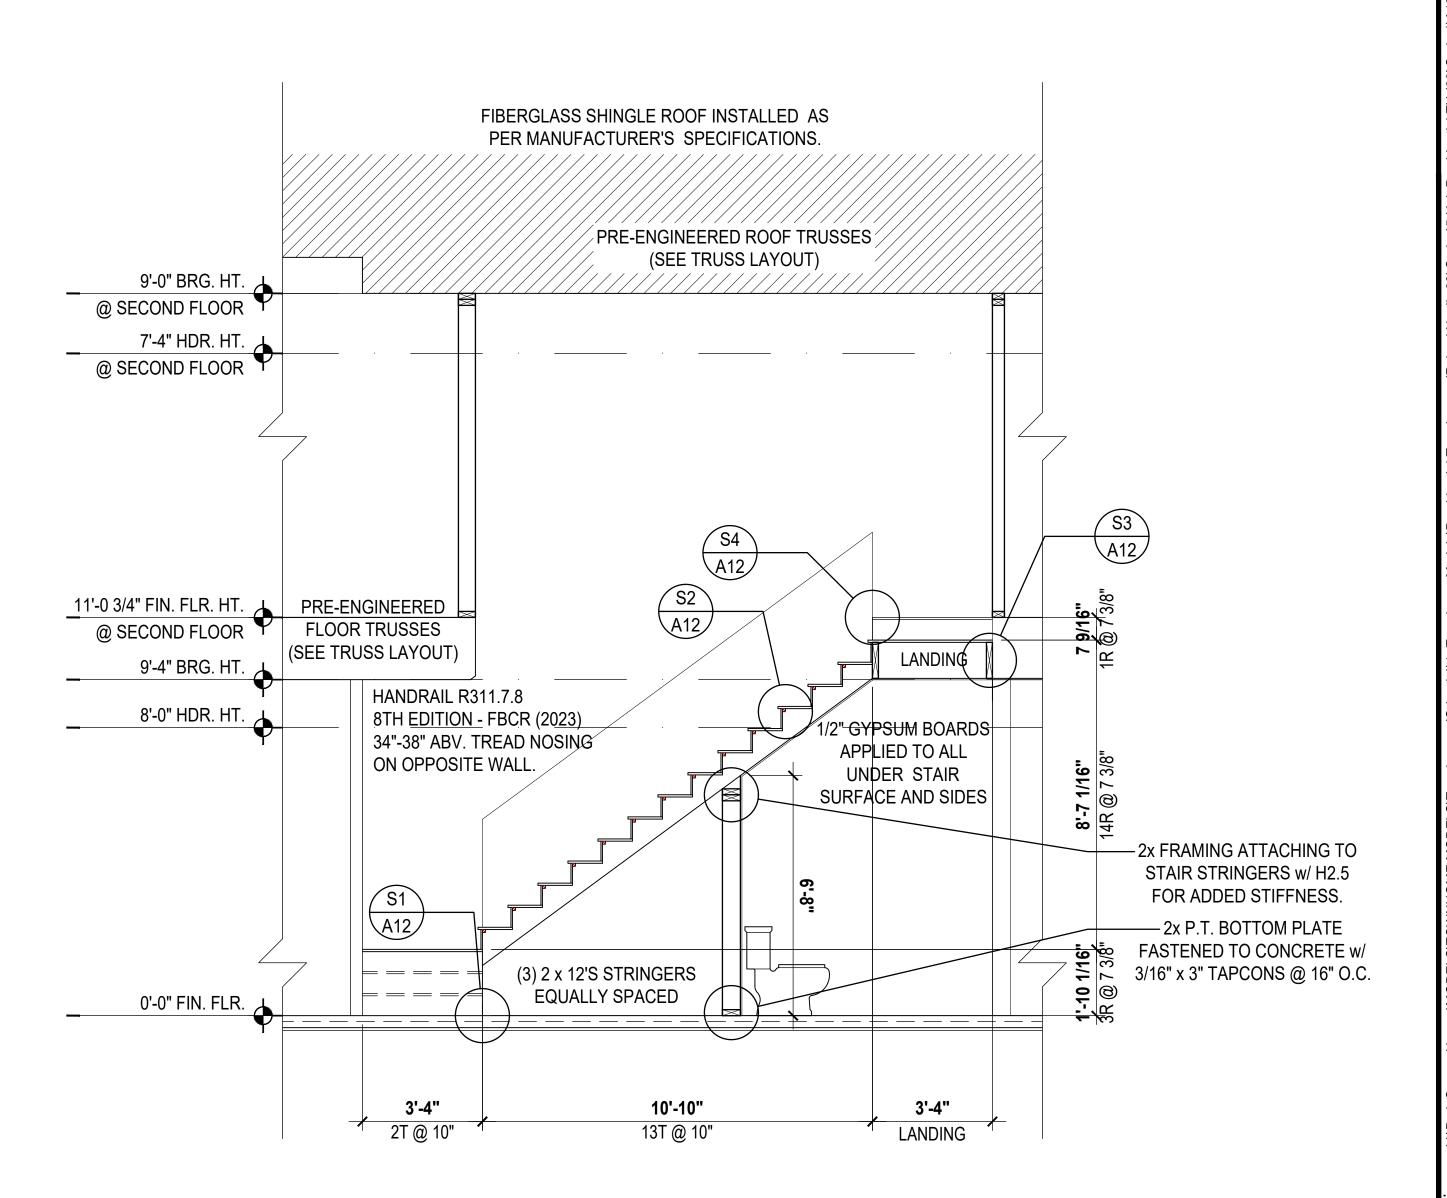


Kennedy: Stair Section

SCALE: 3/8" = 1'-0"




SECTIONS


A13

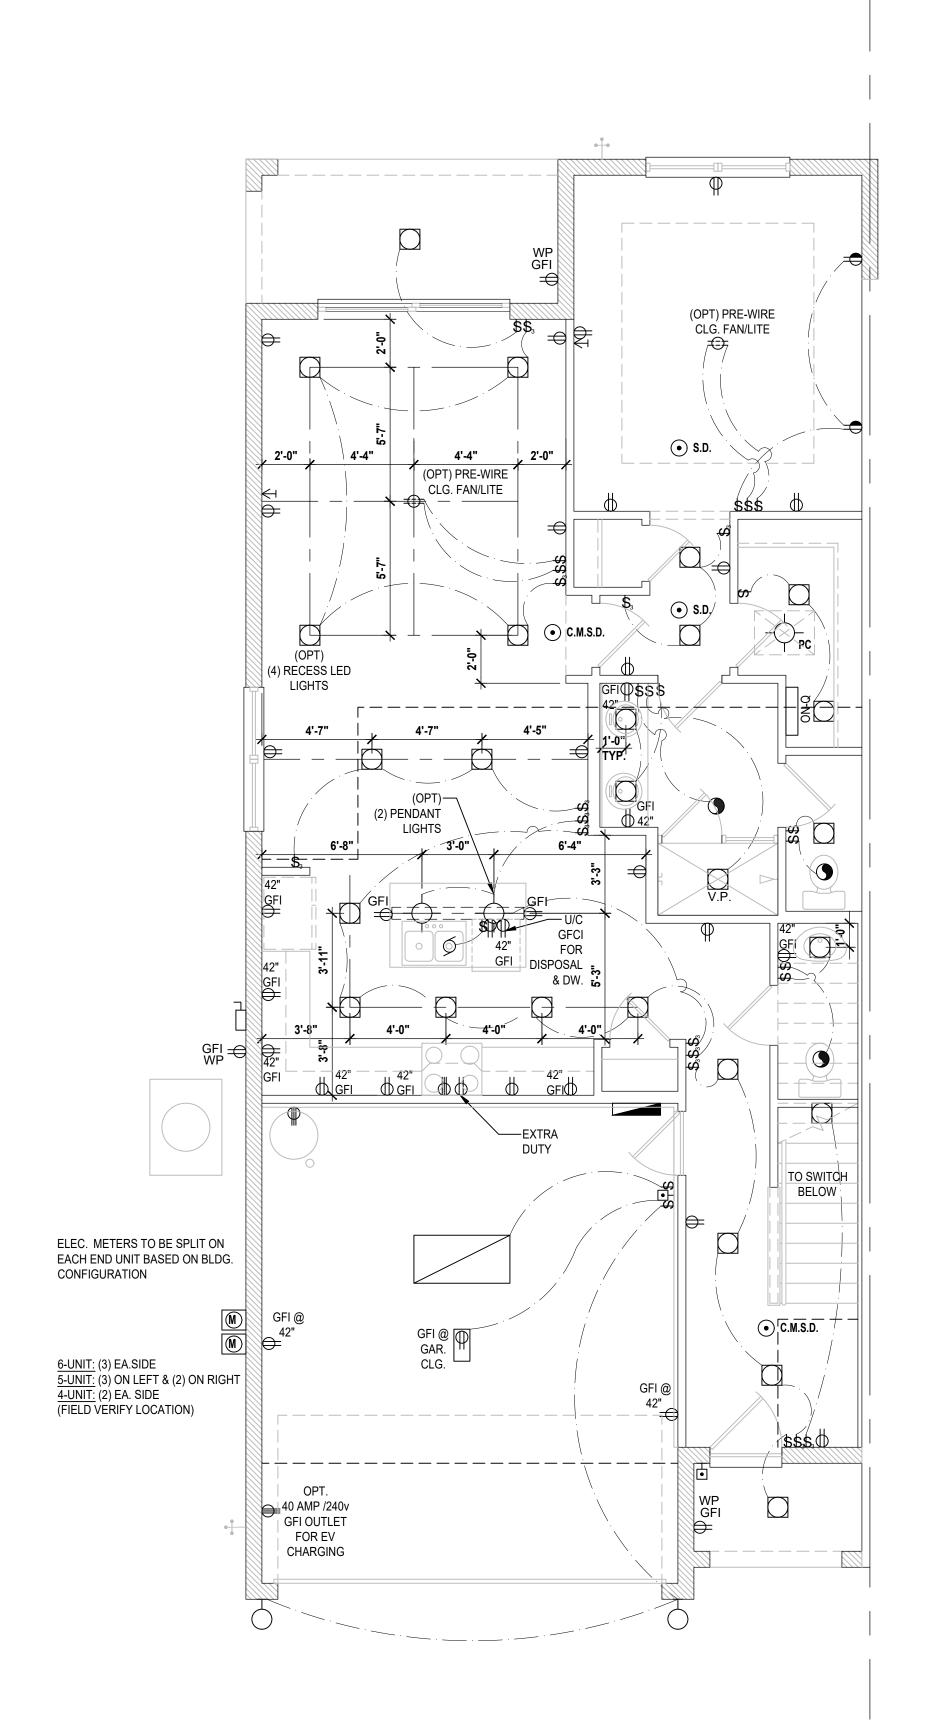

Truman- First Floor (Standard)
SCALE: 1/4" = 1'-0"

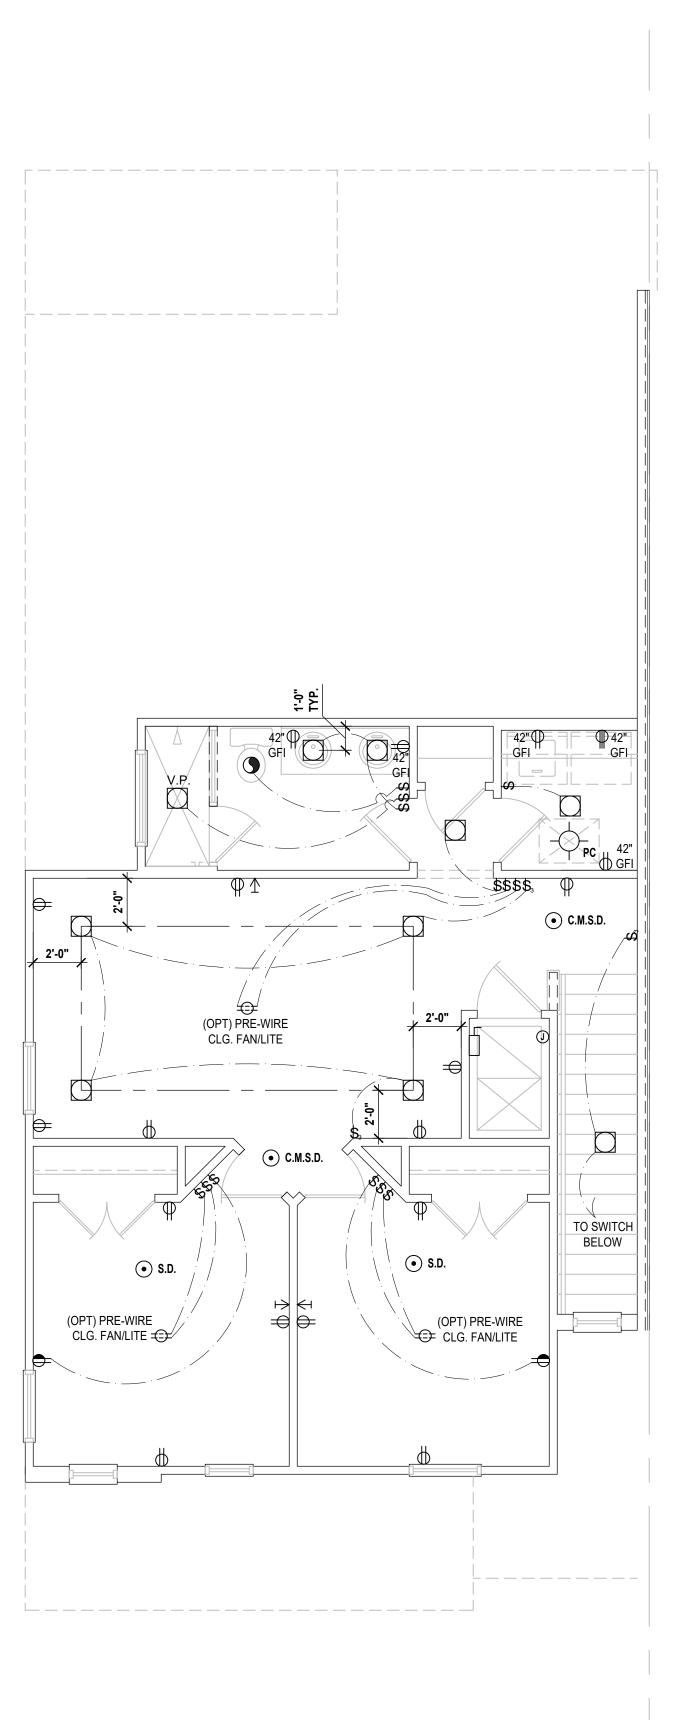

Truman- Second Floor (Elev.- A)
SCALE: 1/4" = 1'-0"

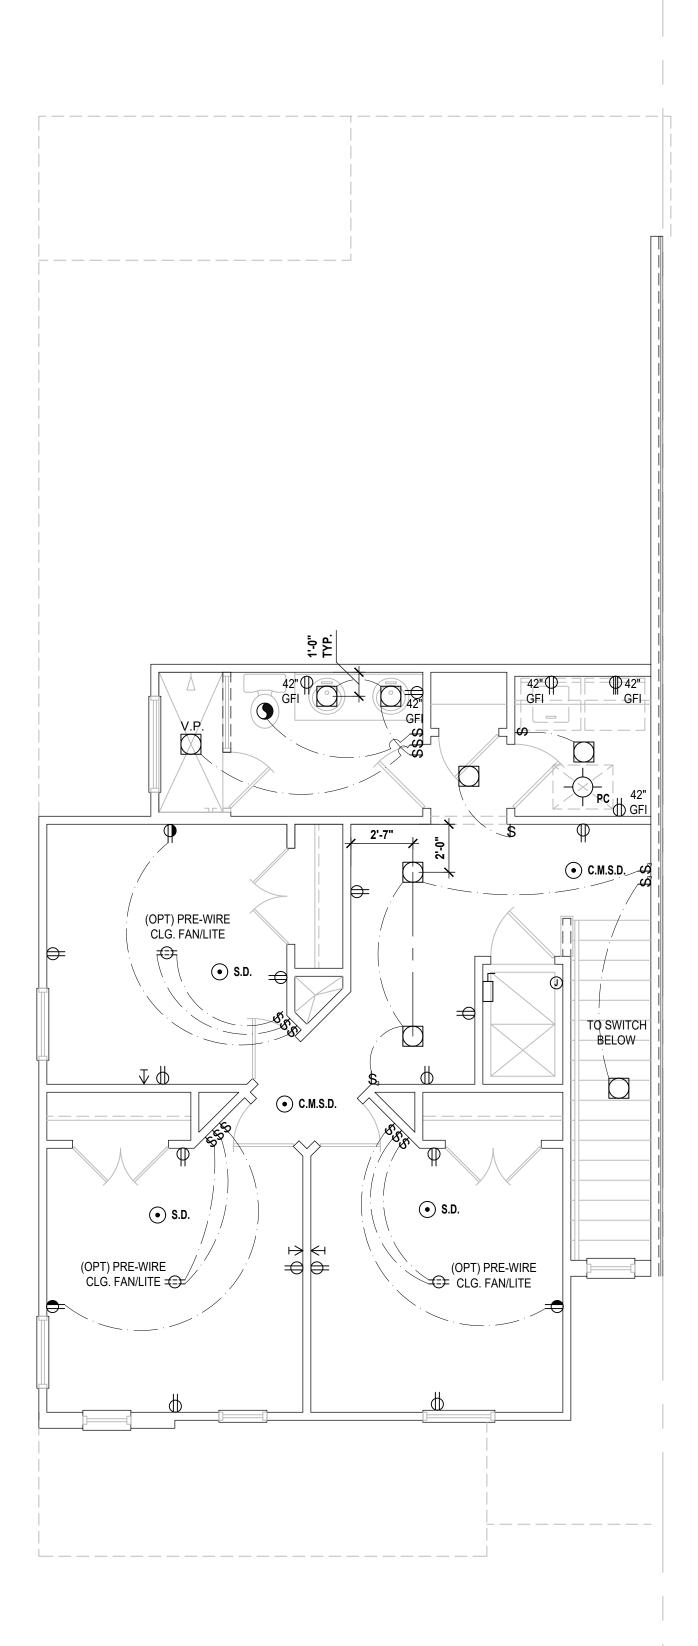

Truman- Second Floor (<u>Opt - 4 Bedroom</u>) SCALE: 1/4" = 1'-0"

GENERAL NOTES KEY

- . BUILDER TO VERIFY EXACT LOCATION OF FLOOR OUTLETS IN FIELD.
- . ALL OUTLETS ARE TO BE AFCI PROTECTED.
 - ALL 15A AND 20A 120V BRANCH CIRCUITS WILL BE AFCI
 - PROTECTED.
- ALL 15A AND 20A 120V BRANCH CIRCUITS LOCATED IN THE GARAGE AND LAUNDRY WILL BE GFCI PROTECTED.
- ALL GARAGE BAYS WILL HAVE DEDICATED GFCI OUTLET. ALL OUTLETS LOCATED IN THE KITCHEN AND
- BATHROOMS ARE TO BE GFCI PROTECTED.
- . DW. AND GARBAGE DISPOSAL ARE TO BE GFCI PROTECTED.
- 8. EXCEPTIONS TO THE GFCI STIPULATION WILL BE ALLOWED ONLY IF ALLOWED PER CURRENT NFPA / NEC.
- OUTLETS LOCATED IN THE LAUNDRY ARE TO BE GFCI AND AFCI PROTECTED.
- 0. OUTLETS LOCATED WITHIN 6'-0" OF A WET AREA ARE TO BE GFCI PROTECTED.
- 11. ALL OUTLETS OVER COUNTERTOPS TO BE 42" A.F.F.
- 2. ALL SMOKE/CARBON MONOXIDE DETECTORS ARE TO BE
- HARD WIRED, INTERCONNECTED AND AFCI PROTECTED. 13. 8'-0" HEIGHT VANITY LIGHTS IN MASTER BATHROOM AND
- 7'-0" IN ALL OTHER BATHROOMS. 14. ANY EXTERIOR WALL ELECTRICAL, MECHANICAL AND
- PLUMBING PENETRATIONS SHOULD BE FITTED WITH QUICKFLASH PANELS (OR SIMILAR).
- 5. RECESSED LUMINAIRES INSTALLED IN THE BUILDING THERMAL ENVELOPE ARE SUBJECT TO THE PROVISIONS
- OF FBCEC R402.4.5. FIXTURES SHALL BE IC-RATED (FOR ZERO CLEARANCE INSULATION CONTACT) AND SEALED AIR TIGHT. ALSO SEE FBCE 410.116.

THIS DIAGRAMMATIC PLAN IS INTENDED TO SHOW LIGHTING AND CONVENIENCE OUTLETS ONLY. IT IS THE ELECTRICAL CONTRACTORS RESPONSIBILITY TO VERIFY THE REQUIREMENT AND LOCATIONS OF ALL ELECTRICAL EQUIPMENT, (INCLUDING KITCHEN EQUIPMENT) AND PROVIDE AND INSTALL COMPLETE ELECTRICAL SERVICE AS REQUIRED PER NFPA, NEC, FBC CODES AND ALL

REIGNING MUNICIPALITY CODES, STANDARDS AND

- ORDINANCES. LOCATION OF FIXTURES AND / OR OUTLETS ARE SUGGESTED LOCATIONS AND MEET MOST LOCAL CODE REQUIREMENTS. ADDITIONS OR ADJUSTMENTS MAY BE MADE BETWEEN THE OWNER AND BUILDER IN THE FIELD. ALL ELECTRICAL WORK AND APPLIANCES ARE IN FULL COMPLIANCE WITH N.F.P.A., N.E.C., F.B.C. 8TH EDITION (2023) RESIDENTIAL, AND ALL APPLICABLE LOCAL STANDARDS, CODES, AND ORDINANCES. VARIOUS SYMBOLS ON ELECTRICAL LEGEND MAY OR MAY NOT BE USED ON THIS PLAN.
- SMOKE DETECTOR REQUIREMENTS: ALL SMOKE/CARBON DETECTOR LOCATIONS MUST BE A MINNIMUM OF 3' FROM ANY BATHROOM PER FBC-R314.3 (4). THEY MUST ALSO BE LOCATED NO MORE THAN 10' FROM NY BEDROOM DOOR OPENING PER FBC-R315.1.

ELECTRICAL KEY:

CEILING MOUNTED LIGHT

PULL CHAIN LIGHT

FLUSH-MOUNT LED

WALL MOUNTED LIGHT

WALL WASH RECESSED DUPLEX RECEPTACLE 220 V RECEPTACLE

FLOOR RECEPTACLE

WALL SWITCH 3-WAY SWITCH

DIMMER SWITCH

FLUORESCENT LIGHT

ELECTRICAL PANEL

• S.D. | SMOKE DETECTOR

WALL SCONCE

JUNCTION BOX

A.F. ARC FAULT PROTECTION

• L.V. LOW VOLTAGE V.P. VAPOR PROOF

以 IC INTERCOM

CEILING FAN

▼ TELEPHONE JACK CABLE JACK

WATER PROOF RECEPTACLE

GROUND FAULT INTERRUPT

PRE-WIRE GARAGE DOOR OPENER

Ho DOOR BELL / GARAGE DOOR SWITCH

C.M.S.D. CARBON MONOXIDE / SMOKE DETEC


FLUSH MOUNT FLUORESCENT LIGHT

FAN / LIGHT COMBINATION

GARBAGE DISPOSAL MOTOR

DISCONNECT SWITCH ELECTRICAL METER



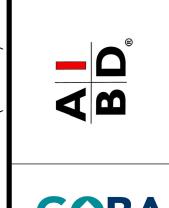









REVISIONS

PROJECT: 00-0000
SCALE: AS NOTED
DRAWN BY: C.C.
DESIGNED BY: MJS

ELECTRICAL LAYOUT

Electrical Layout SCALE: 1/4" = 1'-0"

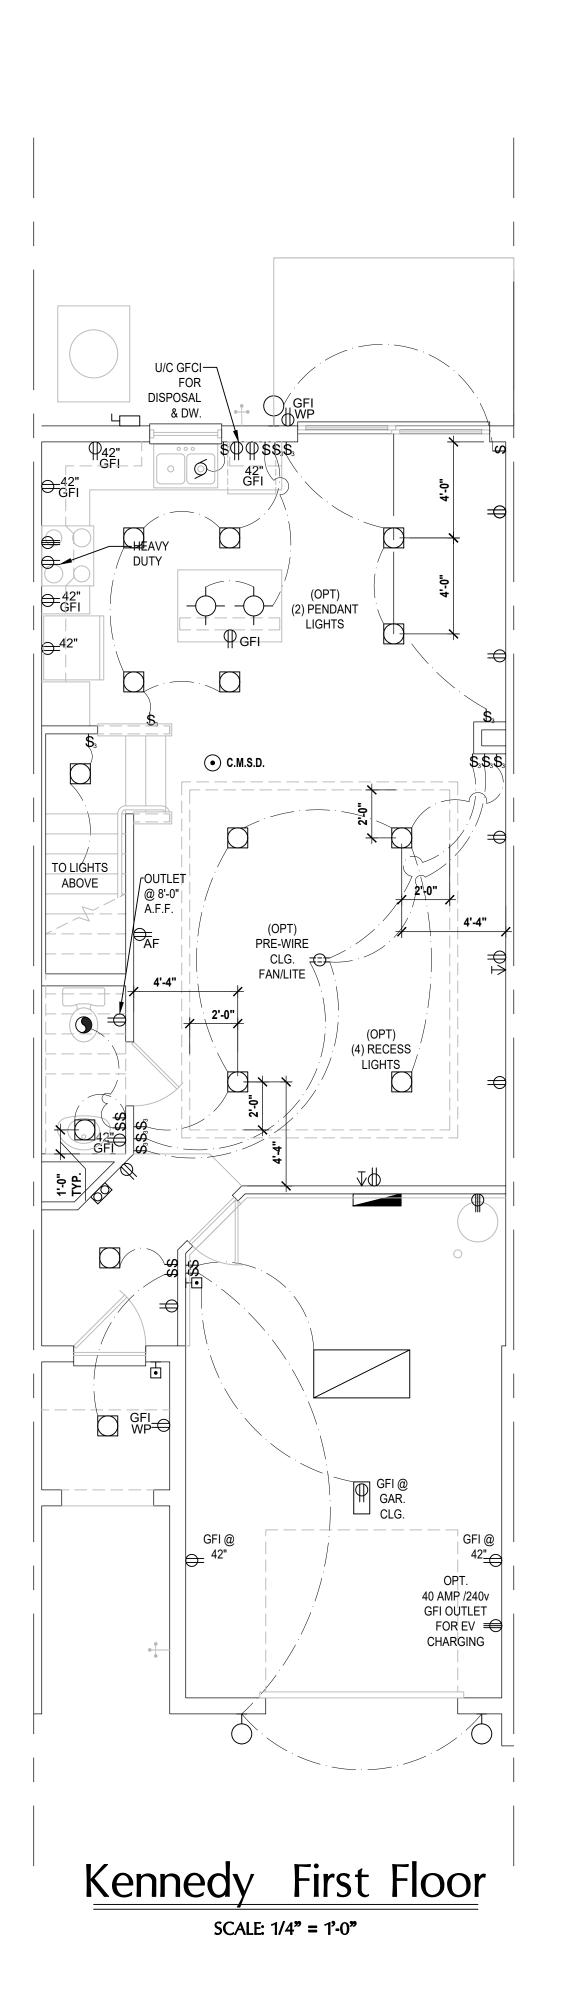

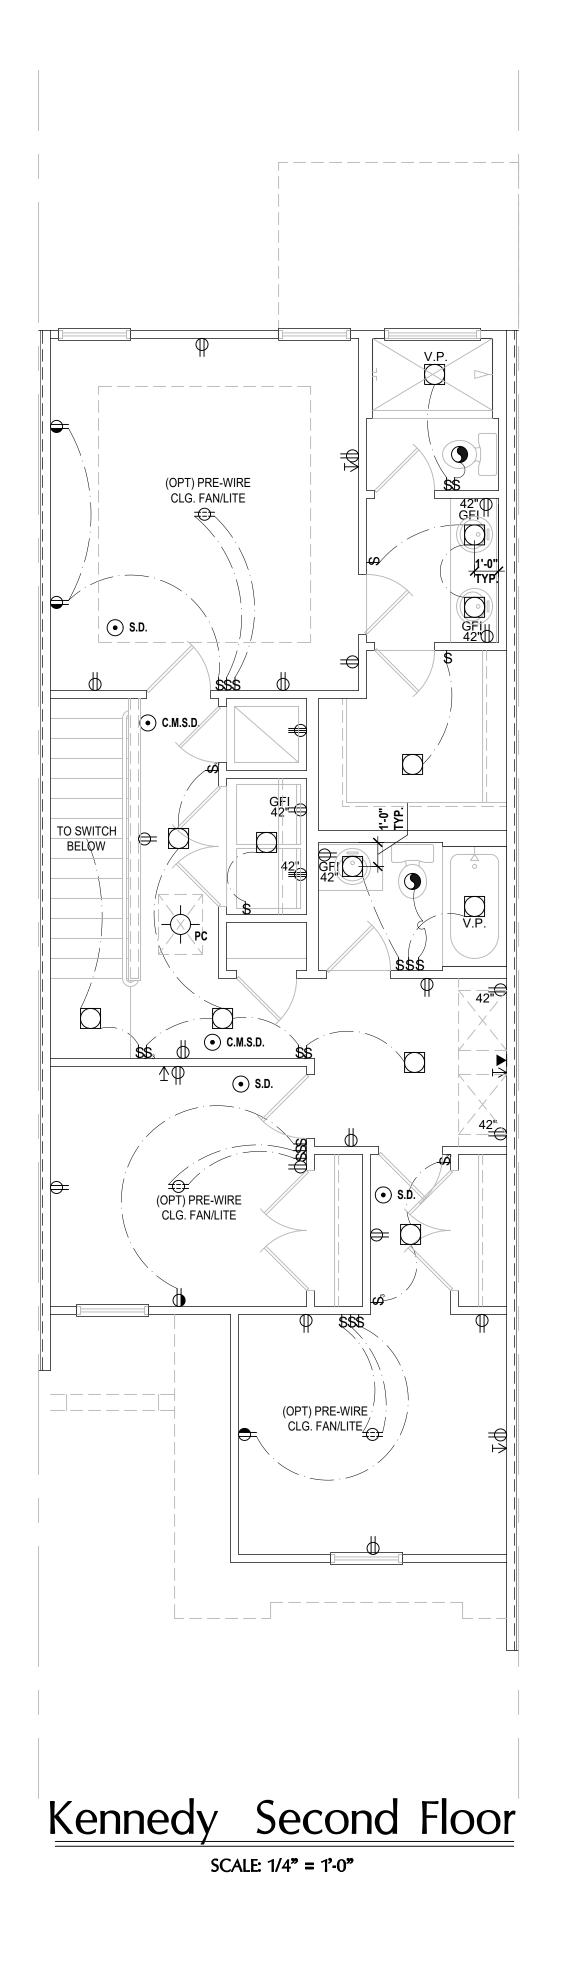

GENERAL NOTES KEY:

- . BUILDER TO VERIFY EXACT LOCATION OF FLOOR OUTLETS IN FIELD.
- . ALL OUTLETS ARE TO BE AFCI PROTECTED.
- ALL 15A AND 20A 120V BRANCH CIRCUITS WILL BE AFCI
- PROTECTED.
- ALL 15A AND 20A 120V BRANCH CIRCUITS LOCATED IN
- THE GARAGE AND LAUNDRY WILL BE GFCI PROTECTED. ALL GARAGE BAYS WILL HAVE DEDICATED GFCI OUTLET.
- ALL OUTLETS LOCATED IN THE KITCHEN AND
- BATHROOMS ARE TO BE GFCI PROTECTED. . DW. AND GARBAGE DISPOSAL ARE TO BE GFCI
- PROTECTED. 8. EXCEPTIONS TO THE GFCI STIPULATION WILL BE
- ALLOWED ONLY IF ALLOWED PER CURRENT NFPA / NEC.

10. OUTLETS LOCATED WITHIN 6'-0" OF A WET AREA ARE TO

- . OUTLETS LOCATED IN THE LAUNDRY ARE TO BE GFCI AND AFCI PROTECTED.
- 11. ALL OUTLETS OVER COUNTERTOPS TO BE 42" A.F.F.

BE GFCI PROTECTED.

HARD WIRED, INTERCONNECTED AND AFCI PROTECTED. 13. 8'-0" HEIGHT VANITY LIGHTS IN MASTER BATHROOM AND

2. ALL SMOKE/CARBON MONOXIDE DETECTORS ARE TO BE

- 7'-0" IN ALL OTHER BATHROOMS. 14. ANY EXTERIOR WALL ELECTRICAL, MECHANICAL AND
- PLUMBING PENETRATIONS SHOULD BE FITTED WITH QUICKFLASH PANELS (OR SIMILAR).
- 5. RECESSED LUMINAIRES INSTALLED IN THE BUILDING THERMAL ENVELOPE ARE SUBJECT TO THE PROVISIONS OF FBCEC R402.4.5. FIXTURES SHALL BE IC-RATED (FOR
- ZERO CLEARANCE INSULATION CONTACT) AND SEALED AIR TIGHT. ALSO SEE FBCE 410.116.
- THIS DIAGRAMMATIC PLAN IS INTENDED TO SHOW LIGHTING AND CONVENIENCE OUTLETS ONLY. IT IS THE ELECTRICAL CONTRACTORS RESPONSIBILITY TO VERIFY THE REQUIREMENT AND LOCATIONS OF ALL ELECTRICAL EQUIPMENT, (INCLUDING KITCHEN EQUIPMENT) AND PROVIDE AND INSTALL COMPLETE ELECTRICAL SERVICE AS REQUIRED PER NFPA, NEC, FBC CODES AND ALL

REIGNING MUNICIPALITY CODES, STANDARDS AND

ORDINANCES. LOCATION OF FIXTURES AND / OR OUTLETS ARE SUGGESTED LOCATIONS AND MEET MOST LOCAL CODE REQUIREMENTS. ADDITIONS OR ADJUSTMENTS MAY BE MADE BETWEEN THE OWNER AND BUILDER IN THE FIELD. ALL ELECTRICAL WORK AND APPLIANCES ARE IN FULL COMPLIANCE WITH N.F.P.A., N.E.C., F.B.C. 8TH EDITION (2023) RESIDENTIAL, AND ALL APPLICABLE LOCAL STANDARDS, CODES, AND ORDINANCES. VARIOUS SYMBOLS ON ELECTRICAL LEGEND MAY OR MAY NOT BE USED ON THIS PLAN.

SMOKE DETECTOR REQUIREMENTS: ALL SMOKE/CARBON DETECTOR LOCATIONS MUST BE A MINNIMUM OF 3' FROM ANY BATHROOM PER FBC-R314.3 (4). THEY MUST ALSO BE LOCATED NO MORE THAN 10' FROM ANY BEDROOM DOOR OPENING PER FBC-R315.1.

ELECTRICAL KEY:

CEILING MOUNTED LIGHT

PULL CHAIN LIGHT

FLUSH-MOUNT LED

WALL MOUNTED LIGHT WALL WASH RECESSED DUPLEX RECEPTACLE 220 V RECEPTACLE

1/2 HOT, 1/2 SWITCHED

FLOOR RECEPTACLE PRE-WIRE FOR CLG. FAN

⇒_{GFI} | GROUND FAULT INTERRUPT

WALL SWITCH 3-WAY SWITCH

\$□ DIMMER SWITCH

▼ TELEPHONE JACK

FLUORESCENT LIGHT

ELECTRICAL PANEL

☐ DISCONNECT SWITCH M ELECTRICAL METER

> WALL SCONCE CHANDELIER SPOT LIGHT

SPEAKER

• L.V. LOW VOLTAGE V.P. VAPOR PROOF

以 IC INTERCOM

JUNCTION BOX

A.F. ARC FAULT PROTECTION

FAN / LIGHT COMBINATION

GARBAGE DISPOSAL MOTOR

S.D. | SMOKE DETECTOR

← CABLE JACK

00

WATER PROOF RECEPTACLE

PRE-WIRE GARAGE DOOR OPENER

Ho DOOR BELL / GARAGE DOOR SWITCH

C.M.S.D. CARBON MONOXIDE / SMOKE DETECTOR

FLUSH MOUNT FLUORESCENT LIGHT

GOBA




REVISIONS

PROJECT: 00-0000
SCALE: AS NOTED
DRAWN BY: C.C.


DESIGNED BY: MJS

Electrical Layout ELECTRICAL LAYOUT

SCALE: 1/4" = 1'-0"

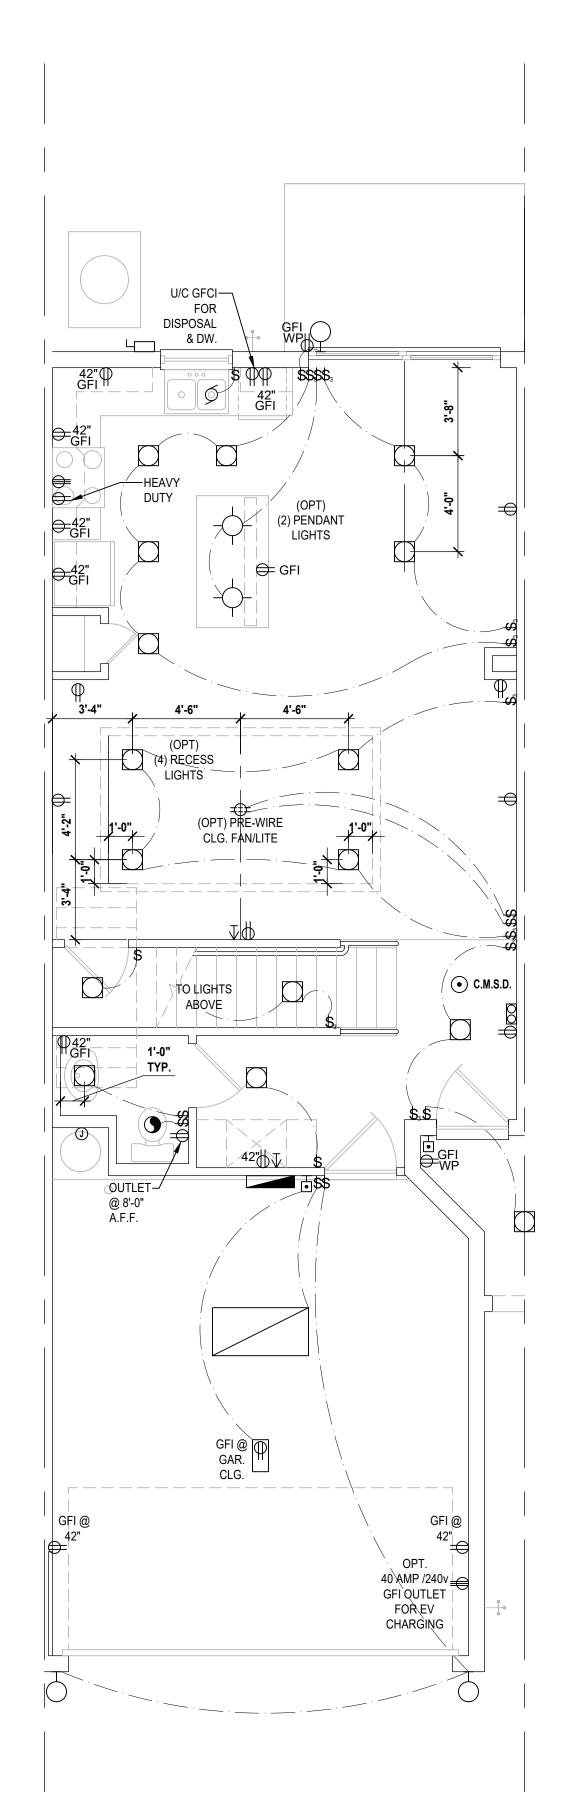

Washington- First Floor (Standard) SCALE: 1/4" = 1'-0"

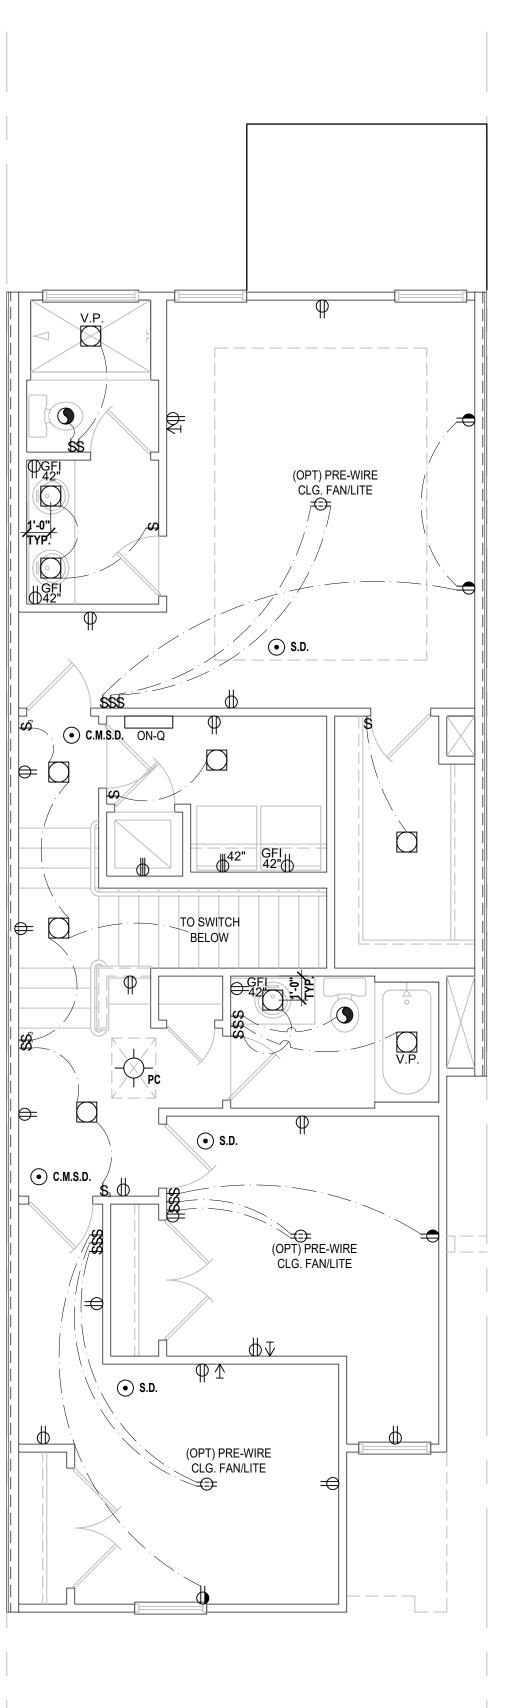

Washington- Second Floor (Standard)
SCALE: 1/4" = 1'-0"



- . BUILDER TO VERIFY EXACT LOCATION OF FLOOR OUTLETS IN FIELD.
- . ALL OUTLETS ARE TO BE AFCI PROTECTED.
- ALL 15A AND 20A 120V BRANCH CIRCUITS WILL BE AFCI
- PROTECTED.
- ALL 15A AND 20A 120V BRANCH CIRCUITS LOCATED IN THE GARAGE AND LAUNDRY WILL BE GFCI PROTECTED.
- ALL GARAGE BAYS WILL HAVE DEDICATED GFCI OUTLET.
- ALL OUTLETS LOCATED IN THE KITCHEN AND
- BATHROOMS ARE TO BE GFCI PROTECTED. . DW. AND GARBAGE DISPOSAL ARE TO BE GFCI

PROTECTED.

BE GFCI PROTECTED.

- 8. EXCEPTIONS TO THE GFCI STIPULATION WILL BE
- ALLOWED ONLY IF ALLOWED PER CURRENT NFPA / NEC. OUTLETS LOCATED IN THE LAUNDRY ARE TO BE GFCI
- AND AFCI PROTECTED. 0. OUTLETS LOCATED WITHIN 6'-0" OF A WET AREA ARE TO
- 11. ALL OUTLETS OVER COUNTERTOPS TO BE 42" A.F.F.

AIR TIGHT. ALSO SEE FBCE 410.116.

- 2. ALL SMOKE/CARBON MONOXIDE DETECTORS ARE TO BE
- HARD WIRED, INTERCONNECTED AND AFCI PROTECTED. 13. 8'-0" HEIGHT VANITY LIGHTS IN MASTER BATHROOM AND
- 7'-0" IN ALL OTHER BATHROOMS.
- 14. ANY EXTERIOR WALL ELECTRICAL, MECHANICAL AND PLUMBING PENETRATIONS SHOULD BE FITTED WITH QUICKFLASH PANELS (OR SIMILAR).
- 5. RECESSED LUMINAIRES INSTALLED IN THE BUILDING THERMAL ENVELOPE ARE SUBJECT TO THE PROVISIONS OF FBCEC R402.4.5. FIXTURES SHALL BE IC-RATED (FOR ZERO CLEARANCE INSULATION CONTACT) AND SEALED

THIS DIAGRAMMATIC PLAN IS INTENDED TO SHOW LIGHTING AND CONVENIENCE OUTLETS ONLY. IT IS THE ELECTRICAL CONTRACTORS RESPONSIBILITY TO VERIFY THE REQUIREMENT AND LOCATIONS OF ALL ELECTRICAL EQUIPMENT, (INCLUDING KITCHEN EQUIPMENT) AND PROVIDE AND INSTALL COMPLETE ELECTRICAL SERVICE AS REQUIRED PER NFPA, NEC, FBC CODES AND ALL REIGNING MUNICIPALITY CODES, STANDARDS AND

ORDINANCES. LOCATION OF FIXTURES AND / OR OUTLETS ARE SUGGESTED LOCATIONS AND MEET MOST LOCAL CODE REQUIREMENTS. ADDITIONS OR ADJUSTMENTS MAY BE MADE BETWEEN THE OWNER AND BUILDER IN THE FIELD. ALL ELECTRICAL WORK AND APPLIANCES ARE IN FULL COMPLIANCE WITH N.F.P.A., N.E.C., F.B.C. 8TH EDITION (2023) RESIDENTIAL, AND ALL APPLICABLE LOCAL STANDARDS, CODES, AND ORDINANCES. VARIOUS SYMBOLS ON ELECTRICAL LEGEND MAY OR

SMOKE DETECTOR REQUIREMENTS: ALL SMOKE/CARBON DETECTOR LOCATIONS MUST BE A MINNIMUM OF 3' FROM ANY BATHROOM PER FBC-R314.3 (4). THEY MUST ALSO BE LOCATED NO MORE THAN 10' FROM ANY BEDROOM DOOR OPENING PER FBC-R315.1.

ELECTRICAL KEY:

CEILING MOUNTED LIGHT

PULL CHAIN LIGHT

FLUSH-MOUNT LED

WALL MOUNTED LIGHT WALL WASH RECESSED DUPLEX RECEPTACLE

GROUND FAULT INTERRUPT

PRE-WIRE GARAGE DOOR OPENER

Ho DOOR BELL / GARAGE DOOR SWITCH

C.M.S.D. CARBON MONOXIDE / SMOKE DETEC

FLUSH MOUNT FLUORESCENT LIGHT

FAN / LIGHT COMBINATION GARBAGE DISPOSAL MOTOR

DISCONNECT SWITCH ELECTRICAL METER

WALL SWITCH 3-WAY SWITCH DIMMER SWITCH

── FLUORESCENT LIGHT ELECTRICAL PANEL

• S.D. | SMOKE DETECTOR

WALL SCONCE

JUNCTION BOX

A.F. ARC FAULT PROTECTION

• L.V. LOW VOLTAGE

V.P. VAPOR PROOF

以 IC INTERCOM

CEILING FAN

▼ TELEPHONE JACK CABLE JACK

MAY NOT BE USED ON THIS PLAN.



A B








REVISIONS


PROJECT: 00-0000
SCALE: AS NOTED
DRAWN BY: C.C.

DESIGNED BY: MJS

ELECTRICAL LAYOUT **E**3

Electrical Layout SCALE: 1/4" = 1'-0"

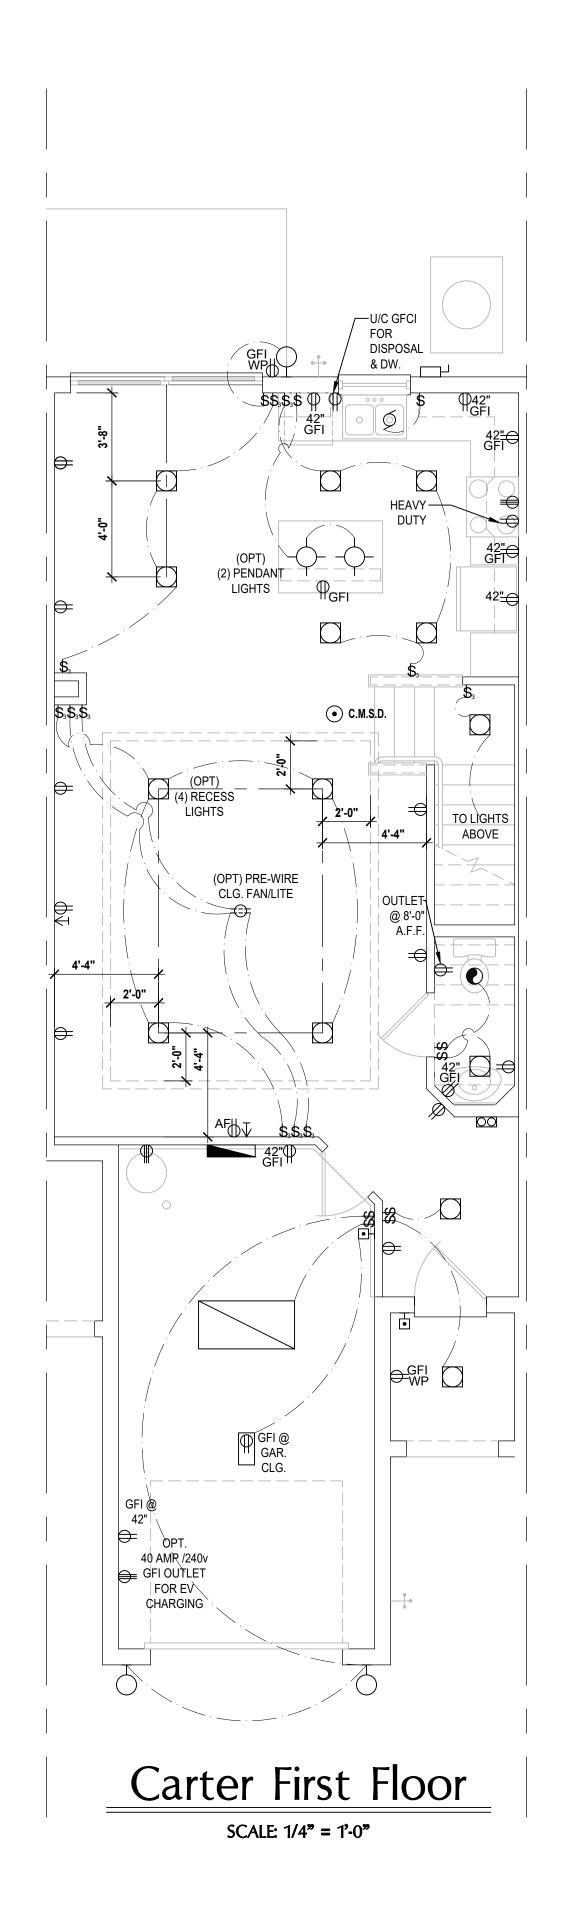

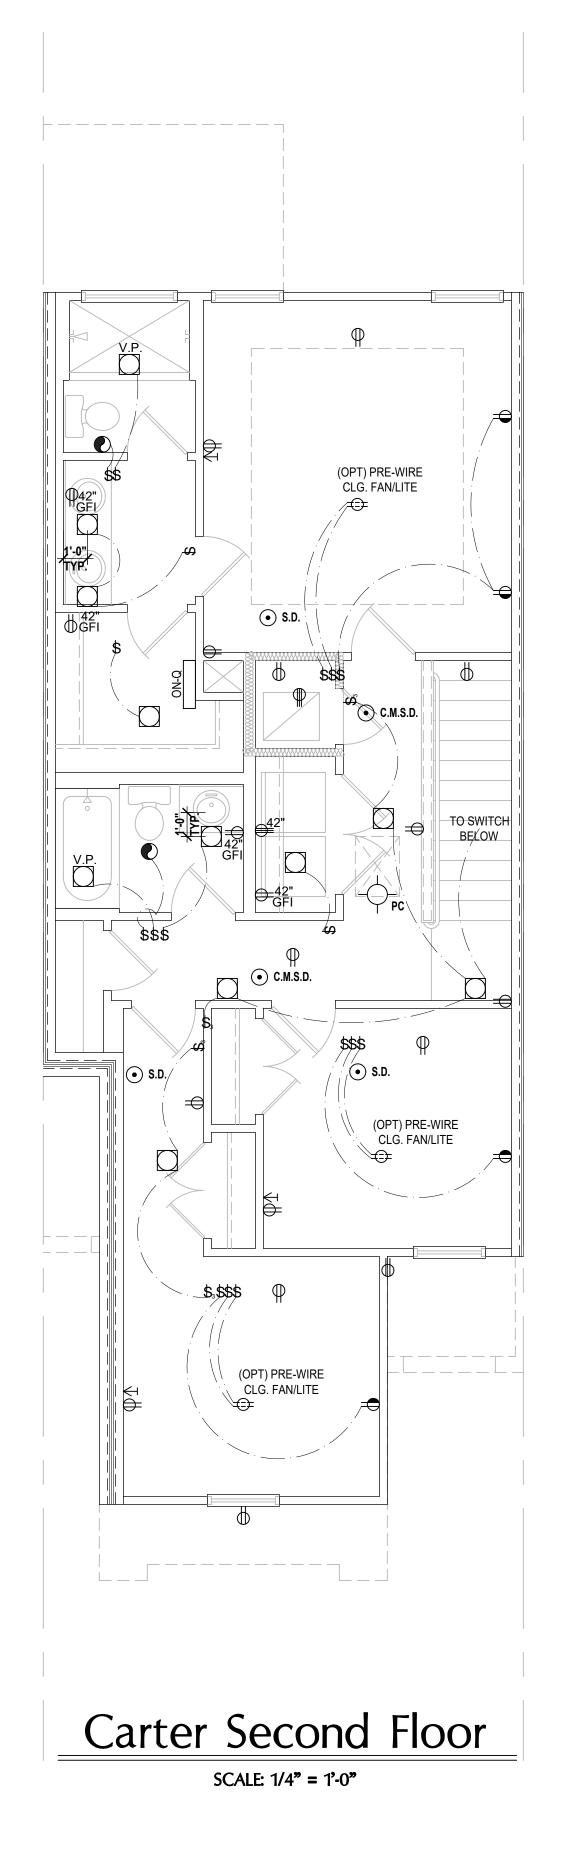

GENERAL NOTES KEY:

- BUILDER TO VERIFY EXACT LOCATION OF FLOOR
 OUTLETS IN FIELD.
- 2. ALL OUTLETS ARE TO BE AFCI PROTECTED.
- 3. ALL 15A AND 20A 120V BRANCH CIRCUITS WILL BE AFCI
- PROTECTED.
- ALL 15A AND 20A 120V BRANCH CIRCUITS LOCATED IN

ALL GARAGE BAYS WILL HAVE DEDICATED GFCI OUTLET.

- THE GARAGE AND LAUNDRY WILL BE GFCI PROTECTED.
- 6. ALL OUTLETS LOCATED IN THE KITCHEN AND
- BATHROOMS ARE TO BE GFCI PROTECTED.

 7. DW. AND GARBAGE DISPOSAL ARE TO BE GFCI

PROTECTED.

- 8. EXCEPTIONS TO THE GFCI STIPULATION WILL BE ALLOWED ONLY IF ALLOWED PER CURRENT NFPA / NEC.
- OUTLETS LOCATED IN THE LAUNDRY ARE TO BE GFCI AND AFCI PROTECTED.
- 10. OUTLETS LOCATED WITHIN 6'-0" OF A WET AREA ARE TO BE GFCI PROTECTED.
- 11. ALL OUTLETS OVER COUNTERTOPS TO BE 42" A.F.F. (U.N.O.).
- (U.N.O.).

 12. ALL SMOKE/CARBON MONOXIDE DETECTORS ARE TO BE
- HARD WIRED, INTERCONNECTED AND AFCI PROTECTED.

 13. 8'-0" HEIGHT VANITY LIGHTS IN MASTER BATHROOM AND
- 7'-0" IN ALL OTHER BATHROOMS.
- 14. ANY EXTERIOR WALL ELECTRICAL, MECHANICAL AND PLUMBING PENETRATIONS SHOULD BE FITTED WITH QUICKFLASH PANELS (OR SIMILAR).
- 5. RECESSED LUMINAIRES INSTALLED IN THE BUILDING THERMAL ENVELOPE ARE SUBJECT TO THE PROVISIONS OF FBCEC R402.4.5. FIXTURES SHALL BE IC-RATED (FOR

AIR TIGHT. ALSO SEE FBCE 410.116.

ZERO CLEARANCE INSULATION CONTACT) AND SEALED

NOTES:

ORDINANCES.

THIS DIAGRAMMATIC PLAN IS INTENDED TO SHOW
LIGHTING AND CONVENIENCE OUTLETS ONLY. IT IS THE
ELECTRICAL CONTRACTORS RESPONSIBILITY TO VERIFY
THE REQUIREMENT AND LOCATIONS OF ALL ELECTRICAL
EQUIPMENT, (INCLUDING KITCHEN EQUIPMENT) AND
PROVIDE AND INSTALL COMPLETE ELECTRICAL SERVICE
AS REQUIRED PER NFPA, NEC, FBC CODES AND ALL
REIGNING MUNICIPALITY CODES, STANDARDS AND

LOCATION OF FIXTURES AND / OR OUTLETS ARE SUGGESTED LOCATIONS AND MEET MOST LOCAL CODE REQUIREMENTS. ADDITIONS OR ADJUSTMENTS MAY BE MADE BETWEEN THE OWNER AND BUILDER IN THE FIELD. ALL ELECTRICAL WORK AND APPLIANCES ARE IN FULL COMPLIANCE WITH N.F.P.A., N.E.C., F.B.C. 8TH EDITION (2023) RESIDENTIAL, AND ALL APPLICABLE LOCAL STANDARDS, CODES, AND ORDINANCES. VARIOUS SYMBOLS ON ELECTRICAL LEGEND MAY OR MAY NOT BE USED ON THIS PLAN.

SMOKE DETECTOR REQUIREMENTS:
ALL SMOKE/CARBON DETECTOR LOCATIONS MUST BE A
MINNIMUM OF 3' FROM ANY BATHROOM PER FBC-R314.3 (4).
THEY MUST ALSO BE LOCATED NO MORE THAN 10' FROM
ANY BEDROOM DOOR OPENING PER FBC-R315.1.

ELECTRICAL KEY:

CEILING MOUNTED LIGHT

PULL CHAIN LIGHT

FLUSH-MOUNT LED

WALL MOUNTED LIGHT
WALL WASH RECESSED
DUPLEX RECEPTACLE
220 V RECEPTACLE
1/2 HOT, 1/2 SWITCHED

WATER PROOF RECEPTACLE

PRE-WIRE GARAGE DOOR OPENER

Ho DOOR BELL / GARAGE DOOR SWITCH

C.M.S.D. CARBON MONOXIDE / SMOKE DETECTOR

FLUSH MOUNT FLUORESCENT LIGHT

FLOOR RECEPTACLE
PRE-WIRE FOR CLG. FAN

⇒_{GFI} | GROUND FAULT INTERRUPT

\$ WALL SWITCH
\$₃ 3-WAY SWITCH
\$□ DIMMER SWITCH

▼ TELEPHONE JACK

FLUORESCENT LIGHT

ELECTRICAL PANEL

L DISCONNECT SWITCH

S.D. SMOKE DETECTOR

WALL SCONCE
CHANDELIER
SPOT LIGHT

SPEAKER

L.V. LOW VOLTAGEV.P. VAPOR PROOF

以 IC INTERCOM

JUNCTION BOX

A.F. ARC FAULT PROTECTION

FAN / LIGHT COMBINATION

GARBAGE DISPOSAL MOTOR

← CABLE JACK

THOMPSON ENGINEERING GROUP 4401 Vineland Road Suite A6 Orlando, FL. 32 Ph. (407) 734-1790 Fax: (407) 734-1790

Altamonte Springs, FI. 32701
Ph: (407) 629-6711
Fax: (407) 629-6776
www.mjsdesignersgroup.com
copyright notice: these plans, designs, ideas are the exclusive intellectual pro
of MJS, INC. ALL RIGHTS RESERVED.







dential 60' Series)
edy, Washington, Carter, Truman
ling Pad #XX
-XX, Subdivision
eet Address

1it: (Presidential

Aodels: Truman, Kennedy, Washingtor
Building Pad #XX
Lot# XX-XX, Subdivis

es Inc.
eland Rd. Suite #200
Fl. 32811

A division of Park Sq Enterprises Inc. 5200 Vineland Rd. Si Orlando, Fl. 32811 Phone: (407) 529-30




ISSUE DATE 02/08/2
REVISIONS


PROJECT: 0

PROJECT: 00-0000
SCALE: AS NOTED
DRAWN BY: C.C.
DESIGNED BY: MJS


ELECTRICAL LAYOUT

E4

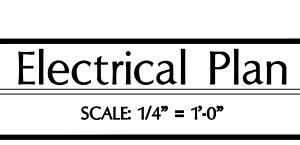


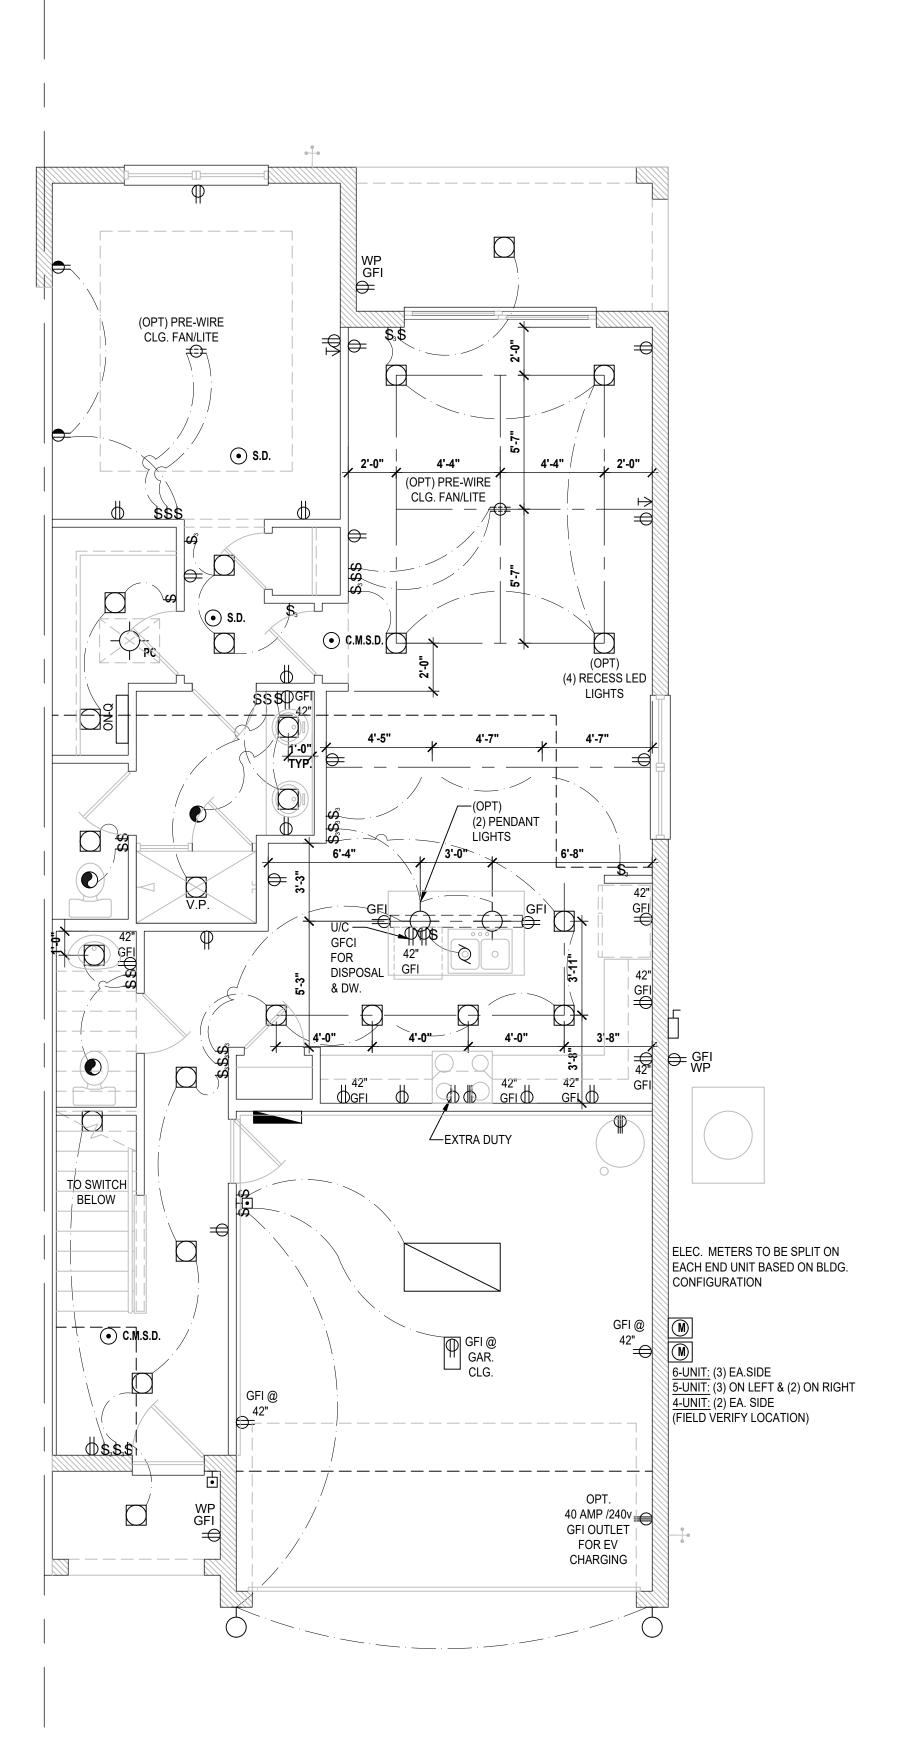

Truman-Rev. First Floor (Standard)
SCALE: 1/4" = 1'-0"

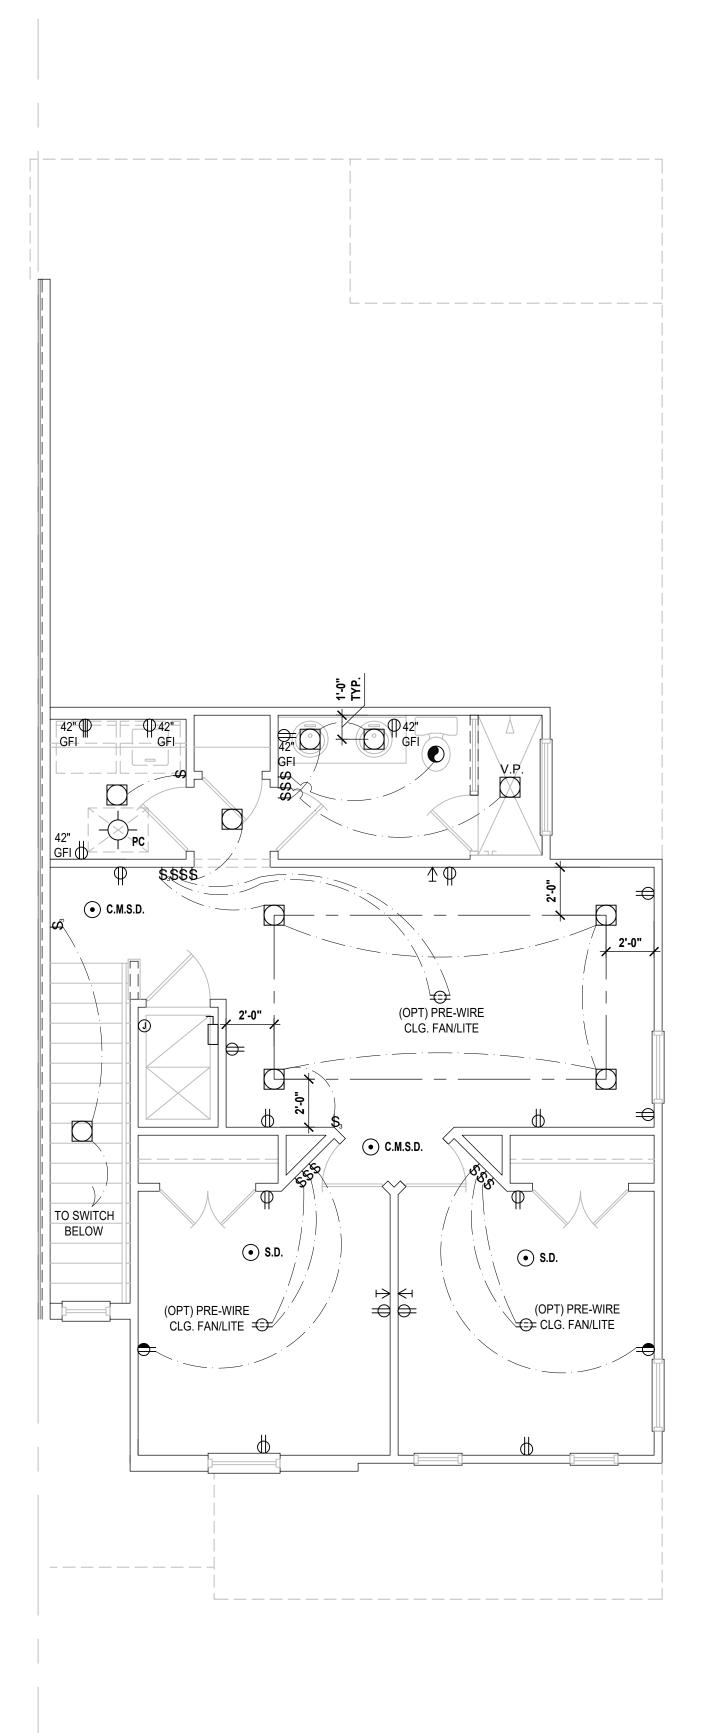

Truman-Rev. Second Floor (Elev.- B) SCALE: 1/4" = 1'-0"

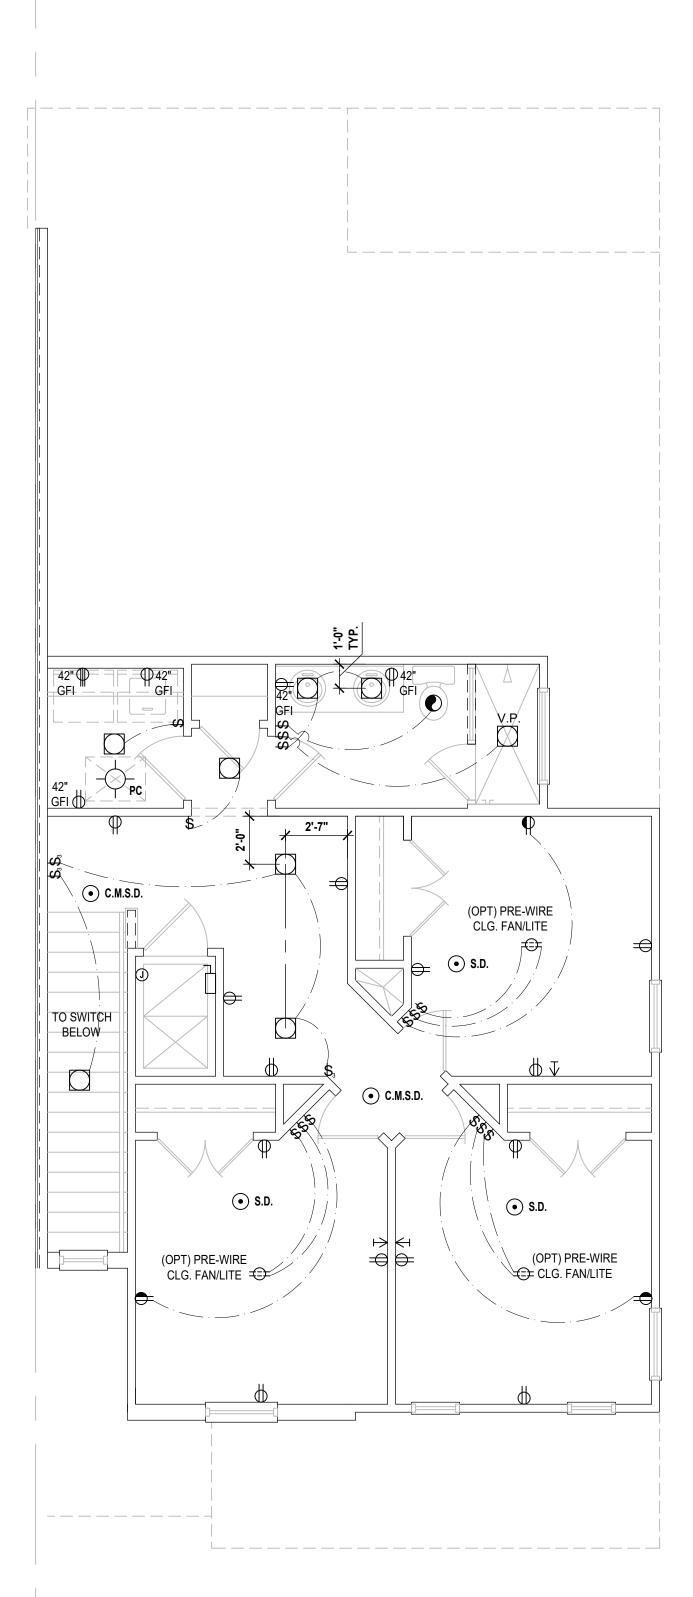

Truman-Rev. Second Floor $\frac{\text{(Opt - 4 Bedroom)}}{\text{SCALE: 1/4" = 1'-0"}}$

GENERAL NOTES KEY

- . BUILDER TO VERIFY EXACT LOCATION OF FLOOR OUTLETS IN FIELD.
- . ALL OUTLETS ARE TO BE AFCI PROTECTED.
- ALL 15A AND 20A 120V BRANCH CIRCUITS WILL BE AFCI
- PROTECTED.
- ALL 15A AND 20A 120V BRANCH CIRCUITS LOCATED IN

ALL GARAGE BAYS WILL HAVE DEDICATED GFCI OUTLET.

- THE GARAGE AND LAUNDRY WILL BE GFCI PROTECTED.
- ALL OUTLETS LOCATED IN THE KITCHEN AND
- BATHROOMS ARE TO BE GFCI PROTECTED.
- . DW. AND GARBAGE DISPOSAL ARE TO BE GFCI PROTECTED.
- ALLOWED ONLY IF ALLOWED PER CURRENT NFPA / NEC.

8. EXCEPTIONS TO THE GFCI STIPULATION WILL BE

- OUTLETS LOCATED IN THE LAUNDRY ARE TO BE GFCI AND AFCI PROTECTED.
- BE GFCI PROTECTED.

0. OUTLETS LOCATED WITHIN 6'-0" OF A WET AREA ARE TO

- 11. ALL OUTLETS OVER COUNTERTOPS TO BE 42" A.F.F.
- 2. ALL SMOKE/CARBON MONOXIDE DETECTORS ARE TO BE HARD WIRED, INTERCONNECTED AND AFCI PROTECTED.
- 7'-0" IN ALL OTHER BATHROOMS.

13. 8'-0" HEIGHT VANITY LIGHTS IN MASTER BATHROOM AND

- 14. ANY EXTERIOR WALL ELECTRICAL, MECHANICAL AND PLUMBING PENETRATIONS SHOULD BE FITTED WITH QUICKFLASH PANELS (OR SIMILAR).
- 5. RECESSED LUMINAIRES INSTALLED IN THE BUILDING THERMAL ENVELOPE ARE SUBJECT TO THE PROVISIONS
- OF FBCEC R402.4.5. FIXTURES SHALL BE IC-RATED (FOR ZERO CLEARANCE INSULATION CONTACT) AND SEALED AIR TIGHT. ALSO SEE FBCE 410.116.
- THIS DIAGRAMMATIC PLAN IS INTENDED TO SHOW LIGHTING AND CONVENIENCE OUTLETS ONLY. IT IS THE ELECTRICAL CONTRACTORS RESPONSIBILITY TO VERIFY THE REQUIREMENT AND LOCATIONS OF ALL ELECTRICAL EQUIPMENT, (INCLUDING KITCHEN EQUIPMENT) AND PROVIDE AND INSTALL COMPLETE ELECTRICAL SERVICE AS REQUIRED PER NFPA, NEC, FBC CODES AND ALL

REIGNING MUNICIPALITY CODES, STANDARDS AND

- ORDINANCES. LOCATION OF FIXTURES AND / OR OUTLETS ARE SUGGESTED LOCATIONS AND MEET MOST LOCAL CODE REQUIREMENTS. ADDITIONS OR ADJUSTMENTS MAY BE MADE BETWEEN THE OWNER AND BUILDER IN THE FIELD. ALL ELECTRICAL WORK AND APPLIANCES ARE IN FULL COMPLIANCE WITH N.F.P.A., N.E.C., F.B.C. 8TH EDITION (2023) RESIDENTIAL, AND ALL APPLICABLE LOCAL STANDARDS, CODES, AND ORDINANCES. VARIOUS SYMBOLS ON ELECTRICAL LEGEND MAY OR MAY NOT BE USED ON THIS PLAN.
- SMOKE DETECTOR REQUIREMENTS: ALL SMOKE/CARBON DETECTOR LOCATIONS MUST BE A MINNIMUM OF 3' FROM ANY BATHROOM PER FBC-R314.3 (4). THEY MUST ALSO BE LOCATED NO MORE THAN 10' FROM NY BEDROOM DOOR OPENING PER FBC-R315.1.

ELECTRICAL KEY:

CEILING MOUNTED LIGHT

PULL CHAIN LIGHT

FLUSH-MOUNT LED

WALL MOUNTED LIGHT WALL WASH RECESSED DUPLEX RECEPTACLE 220 V RECEPTACLE

FLOOR RECEPTACLE

WALL SWITCH

3-WAY SWITCH

▼ TELEPHONE JACK CABLE JACK

DIMMER SWITCH

── FLUORESCENT LIGHT

DISCONNECT SWITCH ELECTRICAL METER

C.M.S.D. CARBON MONOXIDE / SMOKE DETEC

ELECTRICAL PANEL

• S.D. | SMOKE DETECTOR

WALL SCONCE

FAN / LIGHT COMBINATION

JUNCTION BOX

A.F. ARC FAULT PROTECTION

• L.V. LOW VOLTAGE V.P. VAPOR PROOF

以 IC INTERCOM

CEILING FAN


GROUND FAULT INTERRUPT

PRE-WIRE GARAGE DOOR OPENER

DOOR BELL / GARAGE DOOR SWITCH

FLUSH MOUNT FLUORESCENT LIGHT

GARBAGE DISPOSAL MOTOR

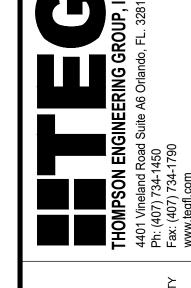









REVISIONS

PROJECT: 00-0000
SCALE: AS NOTED
DRAWN BY: C.C.
DESIGNED BY: MJS

ELECTRICAL LAYOUT

Electrical Layout

houzz FIND US ON FACEBOOK & HOUZZ AT MJS CUSTOM HOME DESIGNS

SCALE: 1/4" = 1'-0"