

(SUBDIVISION NAME) TOWNHOMES



4-UNIT PRESIDENTIAL TH (60' SERIES)

(TRUMAN, WASHINGTON, CARTER, TRUMAN-REV.)

PAD SIZE 92'-0"x 60'-0"

FIRST FLOOR OVERALL SECOND FLOOR OVERALL SECOND FLOOR OVERALL (OPT. BDRM.#4) FLOOR PLANS (TRUMAN) FLOOR PLANS (WASHINGTON) FLOOR PLANS (CARTER) FLOOR PLANS (TRUMAN-REV.) FRONT & REAR ELEVATIONS **LEFT & RIGHT ELEVATIONS** A10 BUILDING SECTION & ROOF LAYOUT SECTIONS: TRUMAN & WASHINGTON SECTIONS: CARTER ELECTRICAL LAYOUT (TRUMAN) ELECTRICAL LAYOUT (WASHINGTON) ELECTRICAL LAYOUT (CARTER) ELECTRICAL LAYOUT (TRUMAN-REV.)

REVISION SCHEDULE:

DATE:	DESCRIPTION:	BY:
	DATE:	DATE: DESCRIPTION: DATE:

DISTRIBUTED LIVE LOAD (IN POUNDS PER SQ. FT.)	ENGINEERING KEY			
UNINHABITABLE ATTICS WITHOUT STORAGE 10 UNINHABITABLE ATTICS WITH LIMITED STORAGE 20 HABITABLE ATTICS & ATTICS SERVED WITH FIXED STAIRS 30 BALCONIES (EXTERIOR) AND DECKS 40 FIRE ESCAPES 40 GUARDS AND HANDRAILS 200 GUARD IN-FILL COMPONENTS 50 PASSENGER VEHICLE GARAGES 50 ROOMS OTHER THAN SLEEPING ROOMS 40 SLEEPING ROOMS 30	B. FLOORS LIVE LOAD IS 40 PSF, BALCONIES, DECKS, STAIRS, LIVE LOAD IS 60PSF NOTE: THIS STRUCTURE HAS BEEN DESIGNED TO MEET OR EXCEED REQUIREMENTS OF THE (2023) FLORIDA BUILDING CODE RES. (8TH EDITION) 1. WIND EXPOSURE - CATEGORY (B) 2. ULTIMATE WIND SPEED - 140MPH. NOMINAL WIND SPEED -			
ANSI STANDARD FOR MEASURING HOUSES				
THE ANSI STANDARD FOR MEASURING HOUSES:	DESIGN STATEMENT			
NATIONAL STANDARD Z765-1996 NEW CONSTRUCTION THE ANSI STANDARDS BASE FLOOR AREA CALCULATIONS ON THE EXTERIOR DIMENSIONS OF THE BUILDING AT EACH FLOOR LEVEL AND INCLUDE ALL INTERIOR WALLS AND VOIDS. FOR ATTACHED UNITS, THE OUTSIDE DIMENSION IS THE CENTER LINE OF THE COMMON WALLS. INTERNAL	THIS STRUCTURE HAS BEEN DESIGNED TO MEET OR EXCEED REQUIREMENTS OF THE (2023) FLORIDA BUILDING CODE RESIDENTIAL (8TH EDITION)			
ROOM DIMENSIONS AREN'T USED IN THIS SYSTEM OF MEASURING. THE ANSI STANDARDS BASE FLOOR AREA CALCULATIONS ON THE EXTERIOR DIMENSIONS OF THE BUILDING AT EACH FLOOR LEVEL AND INCLUDE ALL	EFFECTIVE WIND AREA (SQ. FT.)	WIND PRESSURE AND SUCTION (PSF.) (+) VALUE DENOTES PRESSURE (-) VALUE DENOTES SUCTION		
INTERIOR WALLS AND VOIDS. FOR ATTACHED UNITS, THE OUTSIDE DIMENSION IS THE CENTER LINE OF THE COMMON WALLS. INTERNAL	AREA	4	5	
ROOM DIMENSIONS AREN'T USED IN THIS SYSTEM OF MEASURING.	10	(+) 34.7 / (-) 37.7	(+) 34.7/ (-) 46.5	
THE ANSI STANDARDS BASE FLOOR AREA CALCULATIONS ON THE EXTERIOR DIMENSIONS OF THE BUILDING AT EACH FLOOR LEVEL AND	20	(+) 33.2 / (-) 36.1	(+) 33.2 / (-) 43.4	
INCLUDE ALL INTERIOR WALLS AND VOIDS SEPARATED INTO TWO AREAS:	50	(+) 33.1 / (-) 34.0	(+) 31.1 / (-) 39.2	
	100	(+) 29.5 / (-) 32.5	(+) 29.5 / (-) 36.1	
AIR-CONDITIONED SPACE NON-AIR-CONDITIONED SPACE (GARAGES, PATIOS, PORCHES,	GARAGE DOORS			
BREEZEWAYS)	18'-0" x 8'-0'	' 16'-0" x 7'-0"	OVERHANG	
THE ANSI STANDARDS DEFINE "FINISHED AREA" AS "AN ENCLOSED AREA IN A HOUSE SUITABLE FOR YEAR-ROUND USE, EMBODYING WALLS, FLOORS, AND CEILINGS THAT ARE LIKE THE REST OF THE	(+) 28.7 (-) 31.6	(+) 29.3 (-) 32.2		
MEASUREMENTS MUST BE TAKEN TO THE NEAREST INCH OR TENTH OF A FOOT, AND FLOOR AREA MUST BE REPORTED TO THE NEAREST	9'-0" x 8'-0"	8'-0" x 7'-0"		
SQUARE FOOT. THESE WOULD INCLUDE BONUS/ATTIC SPACES AND ARE USUALLY LISTED SEPARATELY. GENERAL CONTRACTOR:	(+) 30.3 (-) 33.2	(+) 30.8 (-) 33.8	(-) 39.50	
SEITERAL CONTINACTOR.	WIND PRESSURE AND SUCTION DIAGRAM			
IT IS THE RESPONSIBILITY OF THE GENERAL CONTRACTOR TO INSTALL ALL MATERIALS MEETING FLORIDA APPROVAL COMPLIANCE TO AVOID WATER INTRUSION AND MOISTURE INTRUSION ON WINDOWS, DOORS, ROOF, AND ANY OTHER AREA AROUND EACH UNIT/ HOUSE/ APARTMENT/ CONDOMINIUM/ TOWNHOUSE.				

NUMBER OF STORIES: 2 STORIES

CONCRETE MASONRY RESIDENTIAL

ECIFIC PARAMETERS FROM FBC 2023 USED FOR DESIGN


CONSTRUCTION WOOD FRAME CONSTRUCTION AMERICAN SOCIETY OF CIVIL ENGINEERS

GOBA

DRAWN BY: C.C.

DESIGNED BY: MJS

COVER PAGE

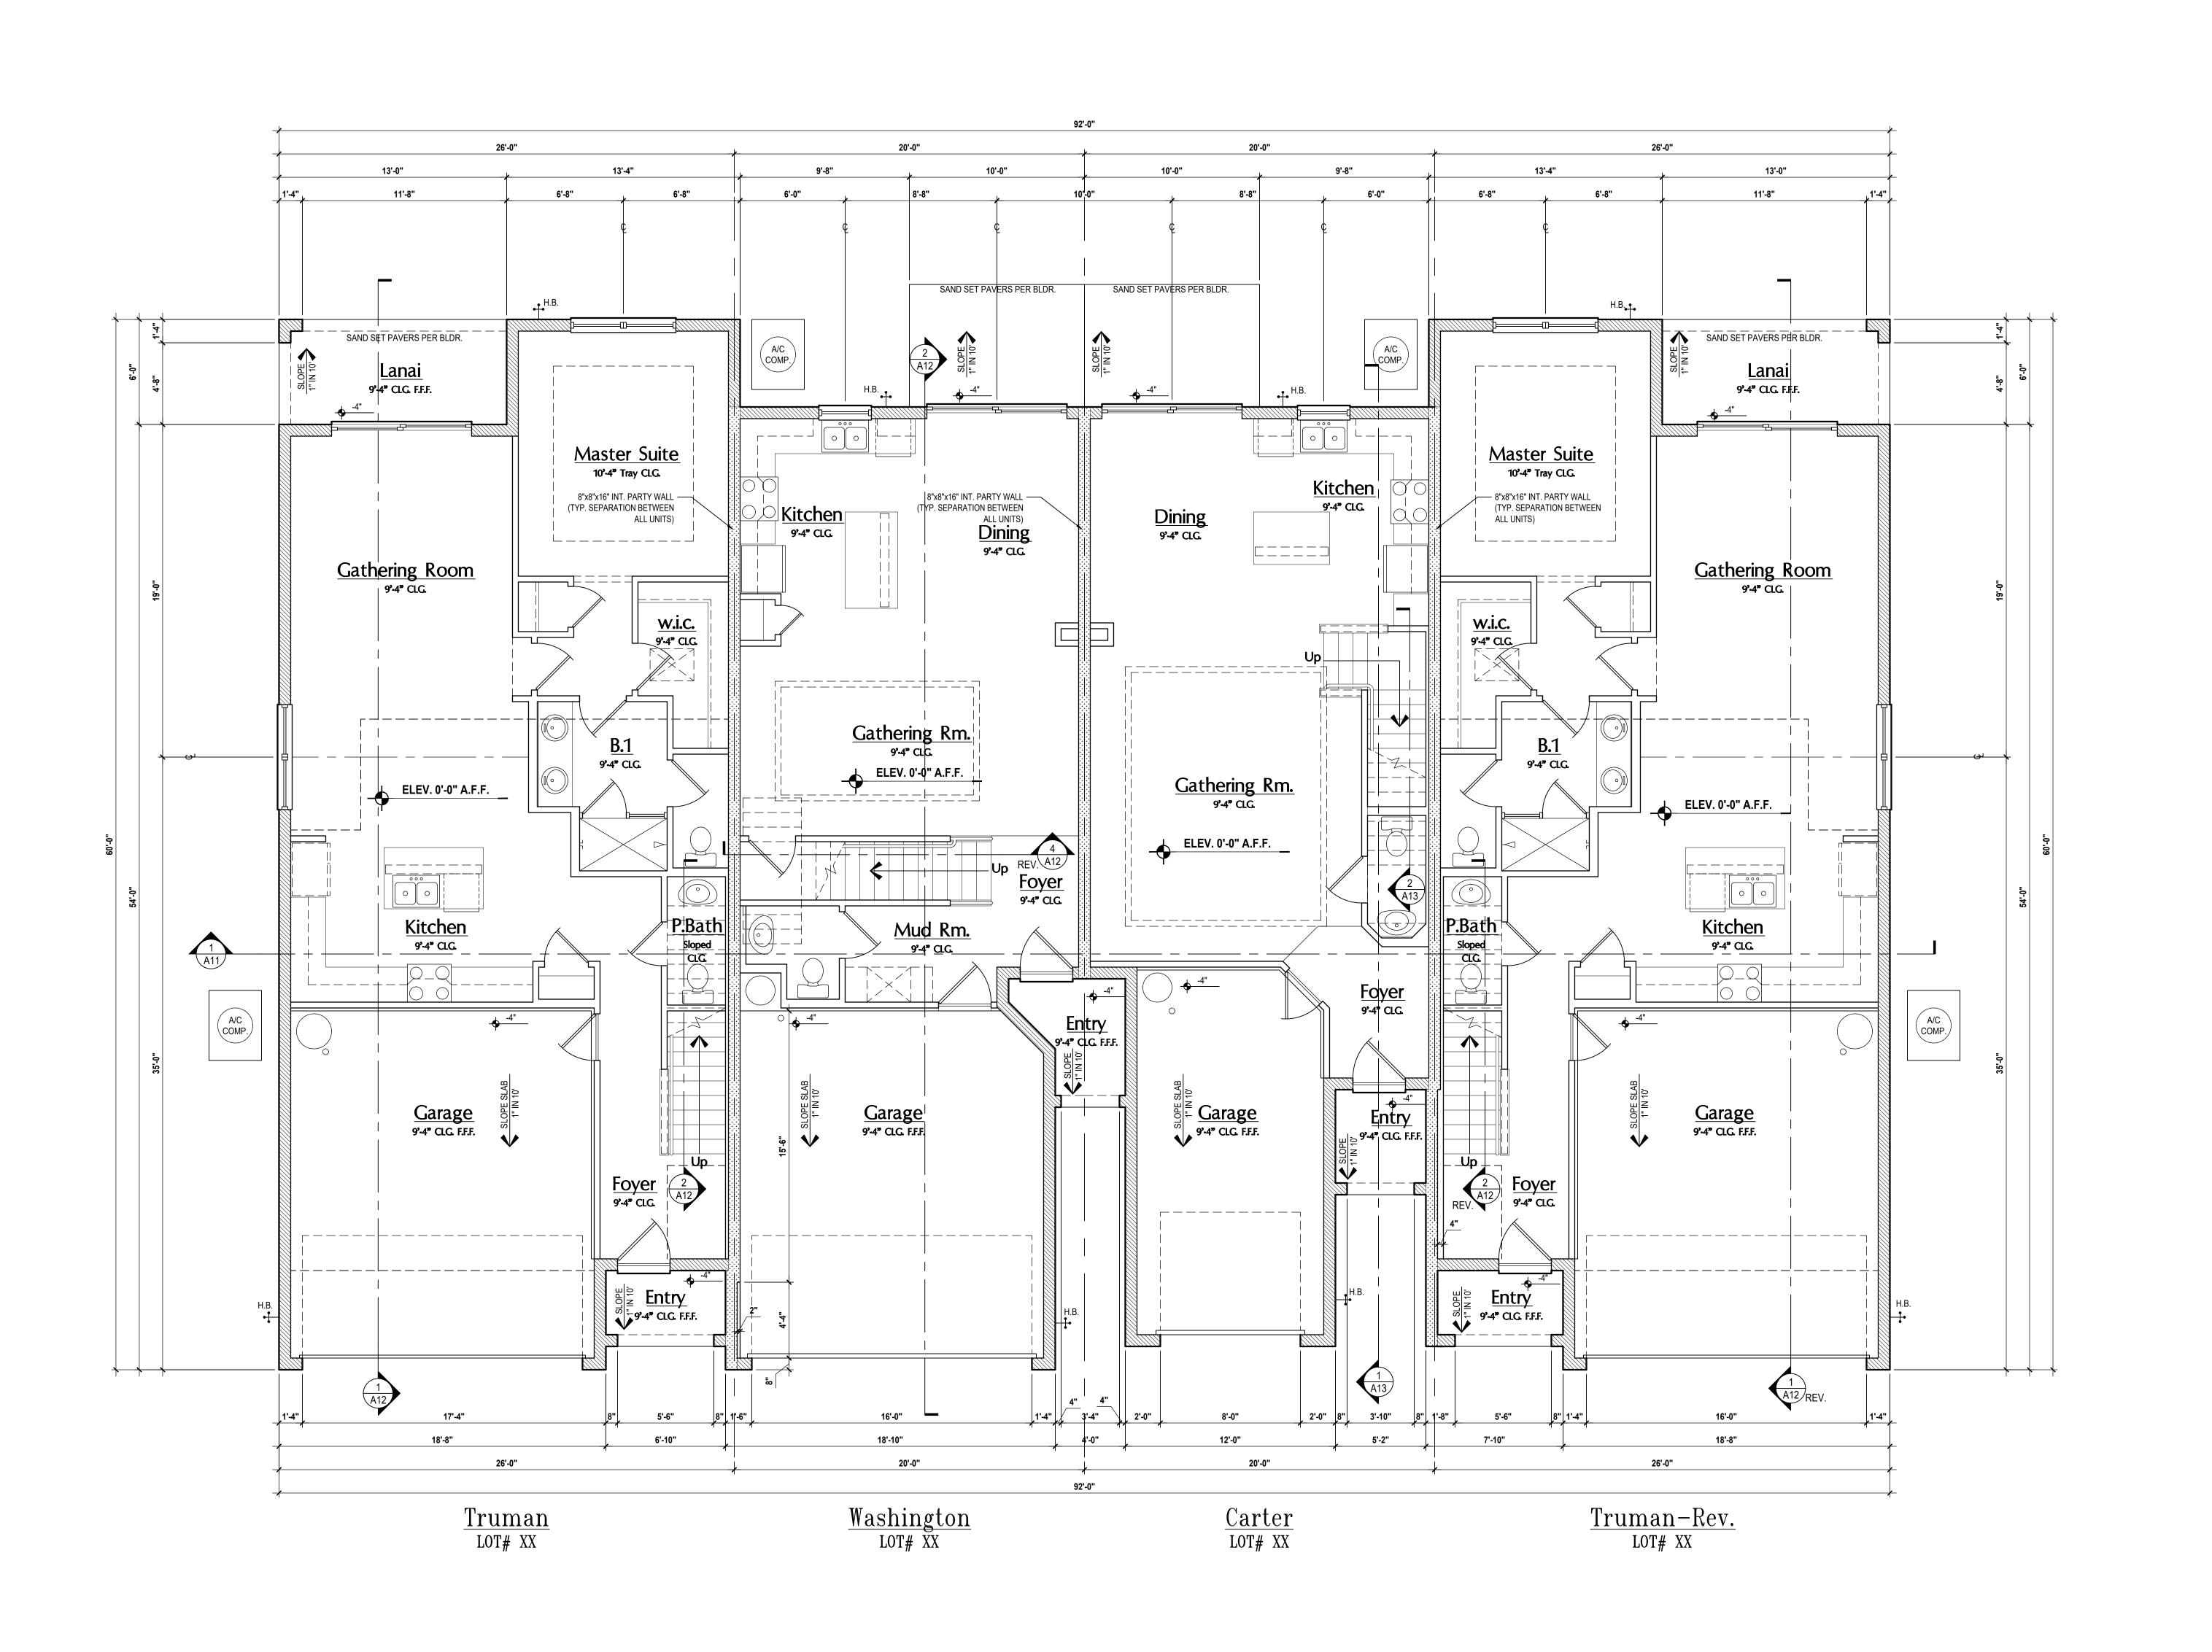

GENERAL NOTES KEY:

TEMP - TEMPERED GLASS FR - FRENCH DOORS SH - SINGLE HUNG SL - SIDE LIGHT DH - DOUBLE HUNG FG - FIXED GLASS CSMT- CASEMENT TR - TRANSOM HR - HORIZONTAL ROLLER GB - GLASS BLOCK BP - BYPASS PKT - POCKET DOOR BF - BIFOLD

SVC - SERVICE DOOR

<u>IOTES:</u>
. CONTRACTOR TO VERIFY ALL DIMENSIONS ON JOB SITE. DO NOT SCALE PRINTS! CONSTRUCTION TO BE FROM

COMMUNITY AND COUNTY CODES.

CALCULATED DIMENSIONS ONLY. ANY DISCREPANCIES OR ERRORS TO BE REPORTED PROMPTLY TO SUPERVISOR FOR MECHANICAL EQUIP. LOCATIONS WILL BE DETERMINED BY

TYP. - TYPICAL

FBC-R M1307.2 & FBC-M 304, AND SHALL BE SUPPORTED ON CONCRETE SLAB OR OTHER APPROVED MATERIAL NOTE LESS THAN 3" ABOVE ADJOINING GROUND, PER FBC-R M1305.1.4.1

A/C CONDENSER UNIT TO BE ANCHORED TO SLAB PER CODE

PROVIDE RECESS H&C WATER W/ DRAIN @ WASHER SPACE. VENT DRYER THRU EXTERIOR WALL U.N.O.

PROVIDE COLD WATER LINE FOR ICE MAKER LINE @ REF.

PROVIDE RECESS H&C WATER W/ DRAIN @ WASHER SPACE. SAG RESISTANT DRYWALL ON ALL CEILINGS.

). PULL ALL DIMENSIONS FROM THE REAR OF PLAN. REFER TO EXTERIOR ELEVATIONS & TYP. DETAIL SHEETS FOR

EXTERIOR WALL FINISH SPEC'S.

REFER TO DETAIL SHEETS FOR FLASHING REQUIREMENTS AT ALL WOOD TO MASONRY INTERFACES.

3. ALL INTERIOR FRAME WALL DIMENSIONS TO BE 3 $\frac{1}{2}$ " U.N.O. ALL EXTERIOR BLOCK WALL DIMENSIONS TO BE $7\frac{1}{2}$ U.N.O. C.M.U. & FRAME WALL SYSTEM SEGMENTS WHICH HAVE AN

CONSIDERED SHEAR WALL SWS = SHEAR WALL SEGMENTS. ENCLOSED SPACE UNDER STAIRS THAT IS ACCESSED BY A DOOR OR ACCESS PANEL SHALL HAVE WALLS, UNDER-STAIR SURFACE AND ANY SOFFITS PROTECTED ON THE ENCLOSED

UNINTERRUPTED LENGTH OF 12'-0" OR MORE SHALL BE

GARAGE DOOR TO BE CERTIFIED BY MFR. FOR MIN. 150 M.P.H. ALL TUB & SHOWER UNITS WILL HAVE ANTI-SCALDING DEVICES

SIDE WITH 1/2-INCH (12.7 MM) GYPSUM BOARD.

ALL OPERABLE WINDOWS LOCATED MORE THAN 72" ABV. SURFACE BELOW SHALL HAVE THE LOWEST PORTION OF WINDOW CLEAR OPENING A MIN. OF 24" ABOVE FINISHED FLOOP BEING SERVER PER (FBC-R312.2).

SEE COLOR SHEET FOR INTERIOR DOOR HEIGHT REQUIREMENTS.

SPECIALTY WINDOWS/DOORS, FIXED GLASS WINDOWS, AND TRANSOMS ARE NOTED ON PLANS.

TEST TO CONFIRM SOIL BEARING CAPACITY AND SURFACE GEO-TECHNICAL CONDITIONS. FOOTINGS SHALL BEAR ON

HONEYCOMB CORE STEEL DOOR NOT LESS THAN 1 3/8"

. ALL DOORS & WINDOWS THAT ARE EGRESS WILL BE LABELED AS SUCH AND CONFORM TO FBC R310.2 EERO SOIL TESTING IS RECOMMENDED, BUT IS NOT REQUIRED. THE DESIGN TEAM AT MJS & E.O.R STRONGLY RECOMMEND A SOIL

UNDISTURBED SOIL A/O PROPERLY COMPACTED FILL (2000 PS MIN.). FILL MATERIAL SHALL BE COMPACTED TO 95% DENSITY OF A STANDARD PROCTOR. TO BE VERIFIED BY GENERAL CONTRACTOR / OWNER. 4. OPENING BETWEEN GARAGE AND RESIDENCE SHALL BE

THICKNESS AS PER FBC-R302.5.1. . 1/2" GYPSUM BOARD APPLIED TO THE GARAGE SIDE OF WAL UNDERSIDE OF DECKING.

6. 5/8" TYPE X DRYWALL ON GARAGE CEILING BELOW ANY HABITABLE SPACE THERMAL BARRIER: FOAM PLASTIC SHALL BE SEPARATED FRO THE INTERIOR OF A BUILDING BY NOT LESS THAN 1/2-INCH (12.7 MM) GYPSUM WALLBOARD, 23/32-INCH (18.2 MM) WOOD

BOTH THE TEMPERATURE TRANSMISSION FIRE TEST AND THE INTEGRITY FIRE TEST OF NFPA 275. . ADDRESS NOTIFICATION SHALL BE IN ACCORDANCE w/ SECTION

STRUCTURAL PANEL OR A MATERIAL THAT IS TESTED IN ACCORDANCE WITH AND MEETS THE ACCEPTANCE CRITERIA O

ANY EXTERIOR WALL ELECTRICAL, MECHANICAL AND PLUMBING PENETRATIONS SHOULD BE FITTED WITH QUICKFLASH PANELS ATTIC ACCESS OPENING SHOULD BE WEATHERSTRIPPED AND

INSULATED TO LEVEL EQUIVALENT TO INSULATION ON THE SURROUNDING AREAS PER FBCEC R402.2.4. FILL VOIDS OF UNDERSIDE OF TUBS & SHOWERS WITH

INSULATION FOR ACOUSTIC DAMPENING. ADD ACOUSTIC OR VIBRATION ISOLATION DEVICES AT GARAGE DOOR OPENERS THAT ARE ADJACENT TO HABITABLE SPACES

GLASS MAT GYPSUM BACKING PANELS (ASTM C1178), FIBER-REINFORCED GYPSUM PANELS (ASTM C1278),

OR NON-ASBESTOS FIBER MAT REINFORCED CEMENTITIOUS BACKER UNITS (ASTM C1325) SHALL BE USED PER FBCR R702.4 PAPER-FACED GYPSUM BOARD SHALL NOT BE USED.

WINDOW / DOOR NOTE KEY

2050 = 2'-0" x 5'-0" 2060 = 2'-0" x 6'-0"

ALL WINDOW CALLOUTS ARE MEASURED IN FEET & INCHES AS PER THE EXAMPLE TABLE ABOVE.

DOOR SIZE CALLOUT: 20 = 2'-0" 40 B.F. = 4'-0" BI-FOLD 24 = 2'-4" 50 B.F. = 5'-0" BI-FOLD 26 = 2'-6" 60 B.F. = 6'-0" BI-FOLD

ALL INTERIOR DOOR HEIGHTS ARE TO BE DETERMINED I


BRG. HT. LEGEND FROM FOUNDATION SLAB TO BOND BEAM. PROVIDE A MM. OF 45" LAP ON ALL STEEL REINFORCING BARS. FOUNDATION: 2-STORY BRG. FOOTING INDICATES 1-HR. FIREWA

> INDICATES 2-AH. PIREW BASED OFF FROM 0'-0" FI FLR. (U.N.O.)

Area Tabulations			
Living:			
1st floor:	3,498	sf	
2nd floor:	3,279	sf	
Total Living:	6,777	sf	
entry:	134	sf	
garage:	1,380	sf	
lanai:	156	sf	
Total Area:	8,447	sf	
natio:	140	ef	

First Floor Plan

SCALE: 1/4" = 1'-0"

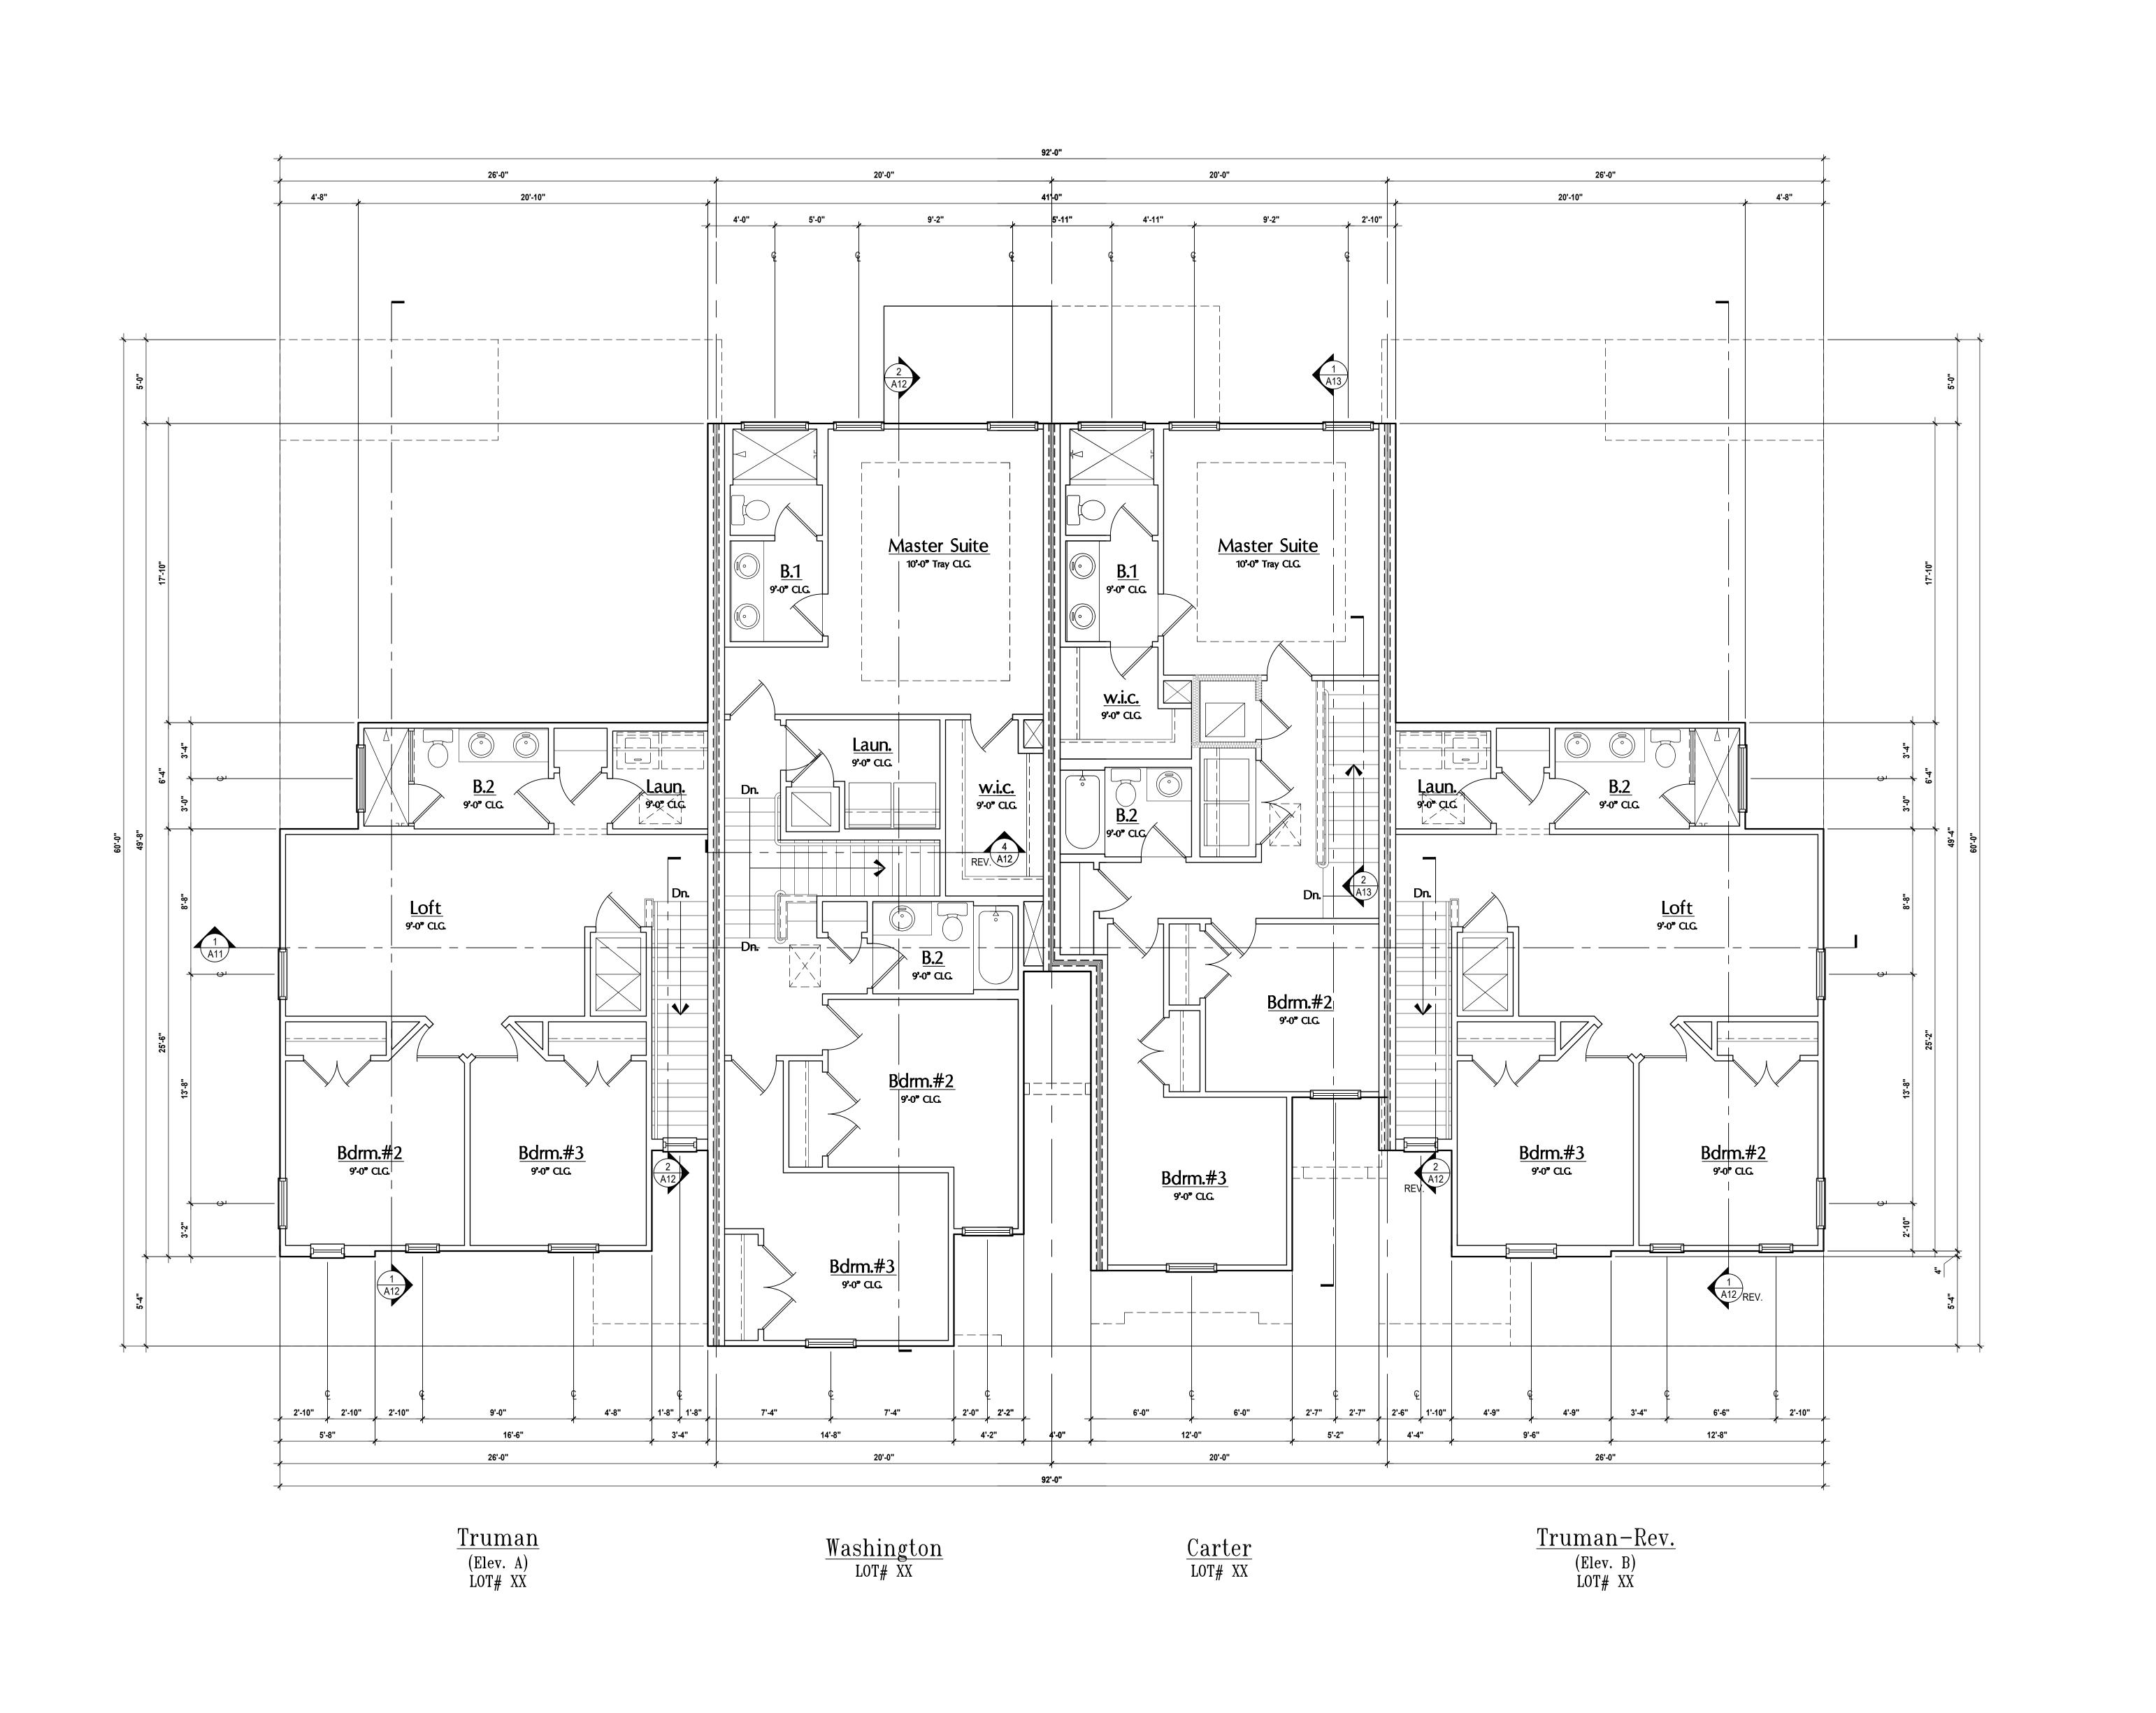

GENERAL NOTES KEY:

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SVC - SERVICE DOOR

NOTES:
1. CONTRACTOR TO VERIFY ALL DIMENSIONS ON JOB SITE. DO NOT SCALE PRINTS! CONSTRUCTION TO BE FROM CALCULATED DIMENSIONS ONLY. ANY DISCREPANCIES OR

TYP. - TYPICAL

ERRORS TO BE REPORTED PROMPTLY TO SUPERVISOR FOR MECHANICAL EQUIP. LOCATIONS WILL BE DETERMINED BY

COMMUNITY AND COUNTY CODES.

A/C CONDENSER UNIT TO BE ANCHORED TO SLAB PER CODE FBC-R M1307.2 & FBC-M 304, AND SHALL BE SUPPORTED ON CONCRETE SLAB OR OTHER APPROVED MATERIAL NOTE LESS THAN 3" ABOVE ADJOINING GROUND, PER FBC-R M1305.1.4.1

PROVIDE RECESS H&C WATER W/ DRAIN @ WASHER SPACE. VENT DRYER THRU EXTERIOR WALL U.N.O.

PROVIDE COLD WATER LINE FOR ICE MAKER LINE @ REF.

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). PULL ALL DIMENSIONS FROM THE REAR OF PLAN. . REFER TO EXTERIOR ELEVATIONS & TYP. DETAIL SHEETS FOR

EXTERIOR WALL FINISH SPEC'S.

REFER TO DETAIL SHEETS FOR FLASHING REQUIREMENTS AT ALL WOOD TO MASONRY INTERFACES.

3. ALL INTERIOR FRAME WALL DIMENSIONS TO BE $3\frac{1}{2}$ " U.N.O. ALL EXTERIOR BLOCK WALL DIMENSIONS TO BE 7 $\frac{1}{2}$ " U.N.O.

5. C.M.U. & FRAME WALL SYSTEM SEGMENTS WHICH HAVE AN UNINTERRUPTED LENGTH OF 12'-0" OR MORE SHALL BE CONSIDERED SHEAR WALL SWS = SHEAR WALL SEGMENTS ENCLOSED SPACE UNDER STAIRS THAT IS ACCESSED BY A

DOOR OR ACCESS PANEL SHALL HAVE WALLS, UNDER-STAIR SURFACE AND ANY SOFFITS PROTECTED ON THE ENCLOSED SIDE WITH 1/2-INCH (12.7 MM) GYPSUM BOARD. GARAGE DOOR TO BE CERTIFIED BY MFR. FOR MIN. 150 M.P.H.

3. ALL TUB & SHOWER UNITS WILL HAVE ANTI-SCALDING DEVICES O. ALL OPERABLE WINDOWS LOCATED MORE THAN 72" ABV.

SURFACE BELOW SHALL HAVE THE LOWEST PORTION OF WINDOW CLEAR OPENING A MIN. OF 24" ABOVE FINISHED FLOOP BEING SERVER PER (FBC-R312.2).

SEE COLOR SHEET FOR INTERIOR DOOR HEIGHT REQUIREMENTS.

SPECIALTY WINDOWS/DOORS, FIXED GLASS WINDOWS, AND TRANSOMS ARE NOTED ON PLANS.

2. ALL DOORS & WINDOWS THAT ARE EGRESS WILL BE LABELED AS SUCH AND CONFORM TO FBC R310.2 EERO B. SOIL TESTING IS RECOMMENDED, BUT IS NOT REQUIRED. THE DESIGN TEAM AT MJS & E.O.R STRONGLY RECOMMEND A SOIL TEST TO CONFIRM SOIL BEARING CAPACITY AND SURFACE

GEO-TECHNICAL CONDITIONS. FOOTINGS SHALL BEAR ON UNDISTURBED SOIL A/O PROPERLY COMPACTED FILL (2000 PS MIN.). FILL MATERIAL SHALL BE COMPACTED TO 95% DENSITY

OF A STANDARD PROCTOR. TO BE VERIFIED BY GENERAL CONTRACTOR / OWNER. 4. OPENING BETWEEN GARAGE AND RESIDENCE SHALL BE HONEYCOMB CORE STEEL DOOR NOT LESS THAN 1 3/8"

5. 1/2" GYPSUM BOARD APPLIED TO THE GARAGE SIDE OF WAL UNDERSIDE OF DECKING. 6. 5/8" TYPE X DRYWALL ON GARAGE CEILING BELOW ANY

THICKNESS AS PER FBC-R302.5.1.

HABITABLE SPACE THERMAL BARRIER: FOAM PLASTIC SHALL BE SEPARATED FROM THE INTERIOR OF A BUILDING BY NOT LESS THAN 1/2-INCH (12.7) MM) GYPSUM WALLBOARD, 23/32-INCH (18.2 MM) WOOD STRUCTURAL PANEL OR A MATERIAL THAT IS TESTED IN

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ACCORDANCE WITH AND MEETS THE ACCEPTANCE CRITERIA OF BOTH THE TEMPERATURE TRANSMISSION FIRE TEST AND THE

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). ATTIC ACCESS OPENING SHOULD BE WEATHERSTRIPPED AND INSULATED TO LEVEL EQUIVALENT TO INSULATION ON THE SURROUNDING AREAS PER FBCEC R402.2.4.

I. FILL VOIDS OF UNDERSIDE OF TUBS & SHOWERS WITH INSULATION FOR ACOUSTIC DAMPENING.

. ADD ACOUSTIC OR VIBRATION ISOLATION DEVICES AT GARAGE DOOR OPENERS THAT ARE ADJACENT TO HABITABLE SPACES

. WHERE WALL TILE IS INSTALLED IN TUB AND SHOWER AREAS, GLASS MAT GYPSUM BACKING PANELS (ASTM C1178), FIBER-REINFORCED GYPSUM PANELS (ASTM C1278), NON-ASBESTOS FIBER-CEMENT BACKER BOARD (ASTM C1288) OR NON-ASBESTOS FIBER MAT REINFORCED CEMENTITIOUS BACKER UNITS (ASTM C1325) SHALL BE USED PER FBCR R702.4. PAPER-FACED GYPSUM BOARD SHALL NOT BE USED.

WINDOW / DOOR NOTE KEY

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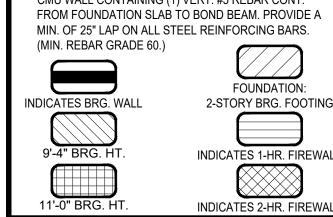
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ALL INTERIOR DOOR HEIGHTS ARE TO BE DETERMINED B


BRG. HT. LEGEND

INDICATES A CONCRETE FILLED CELL WITHIN AN 8"
 CMU WALL CONTAINING (1) VERT. #5 REBAR CONT.



PROJECT: 00-0000
SCALE: AS NOTED
DRAWN BY: C.C.
DESIGNED BY: MJS

Second Flr. Plan second overall SCALE: 1/4" = 1'-0"

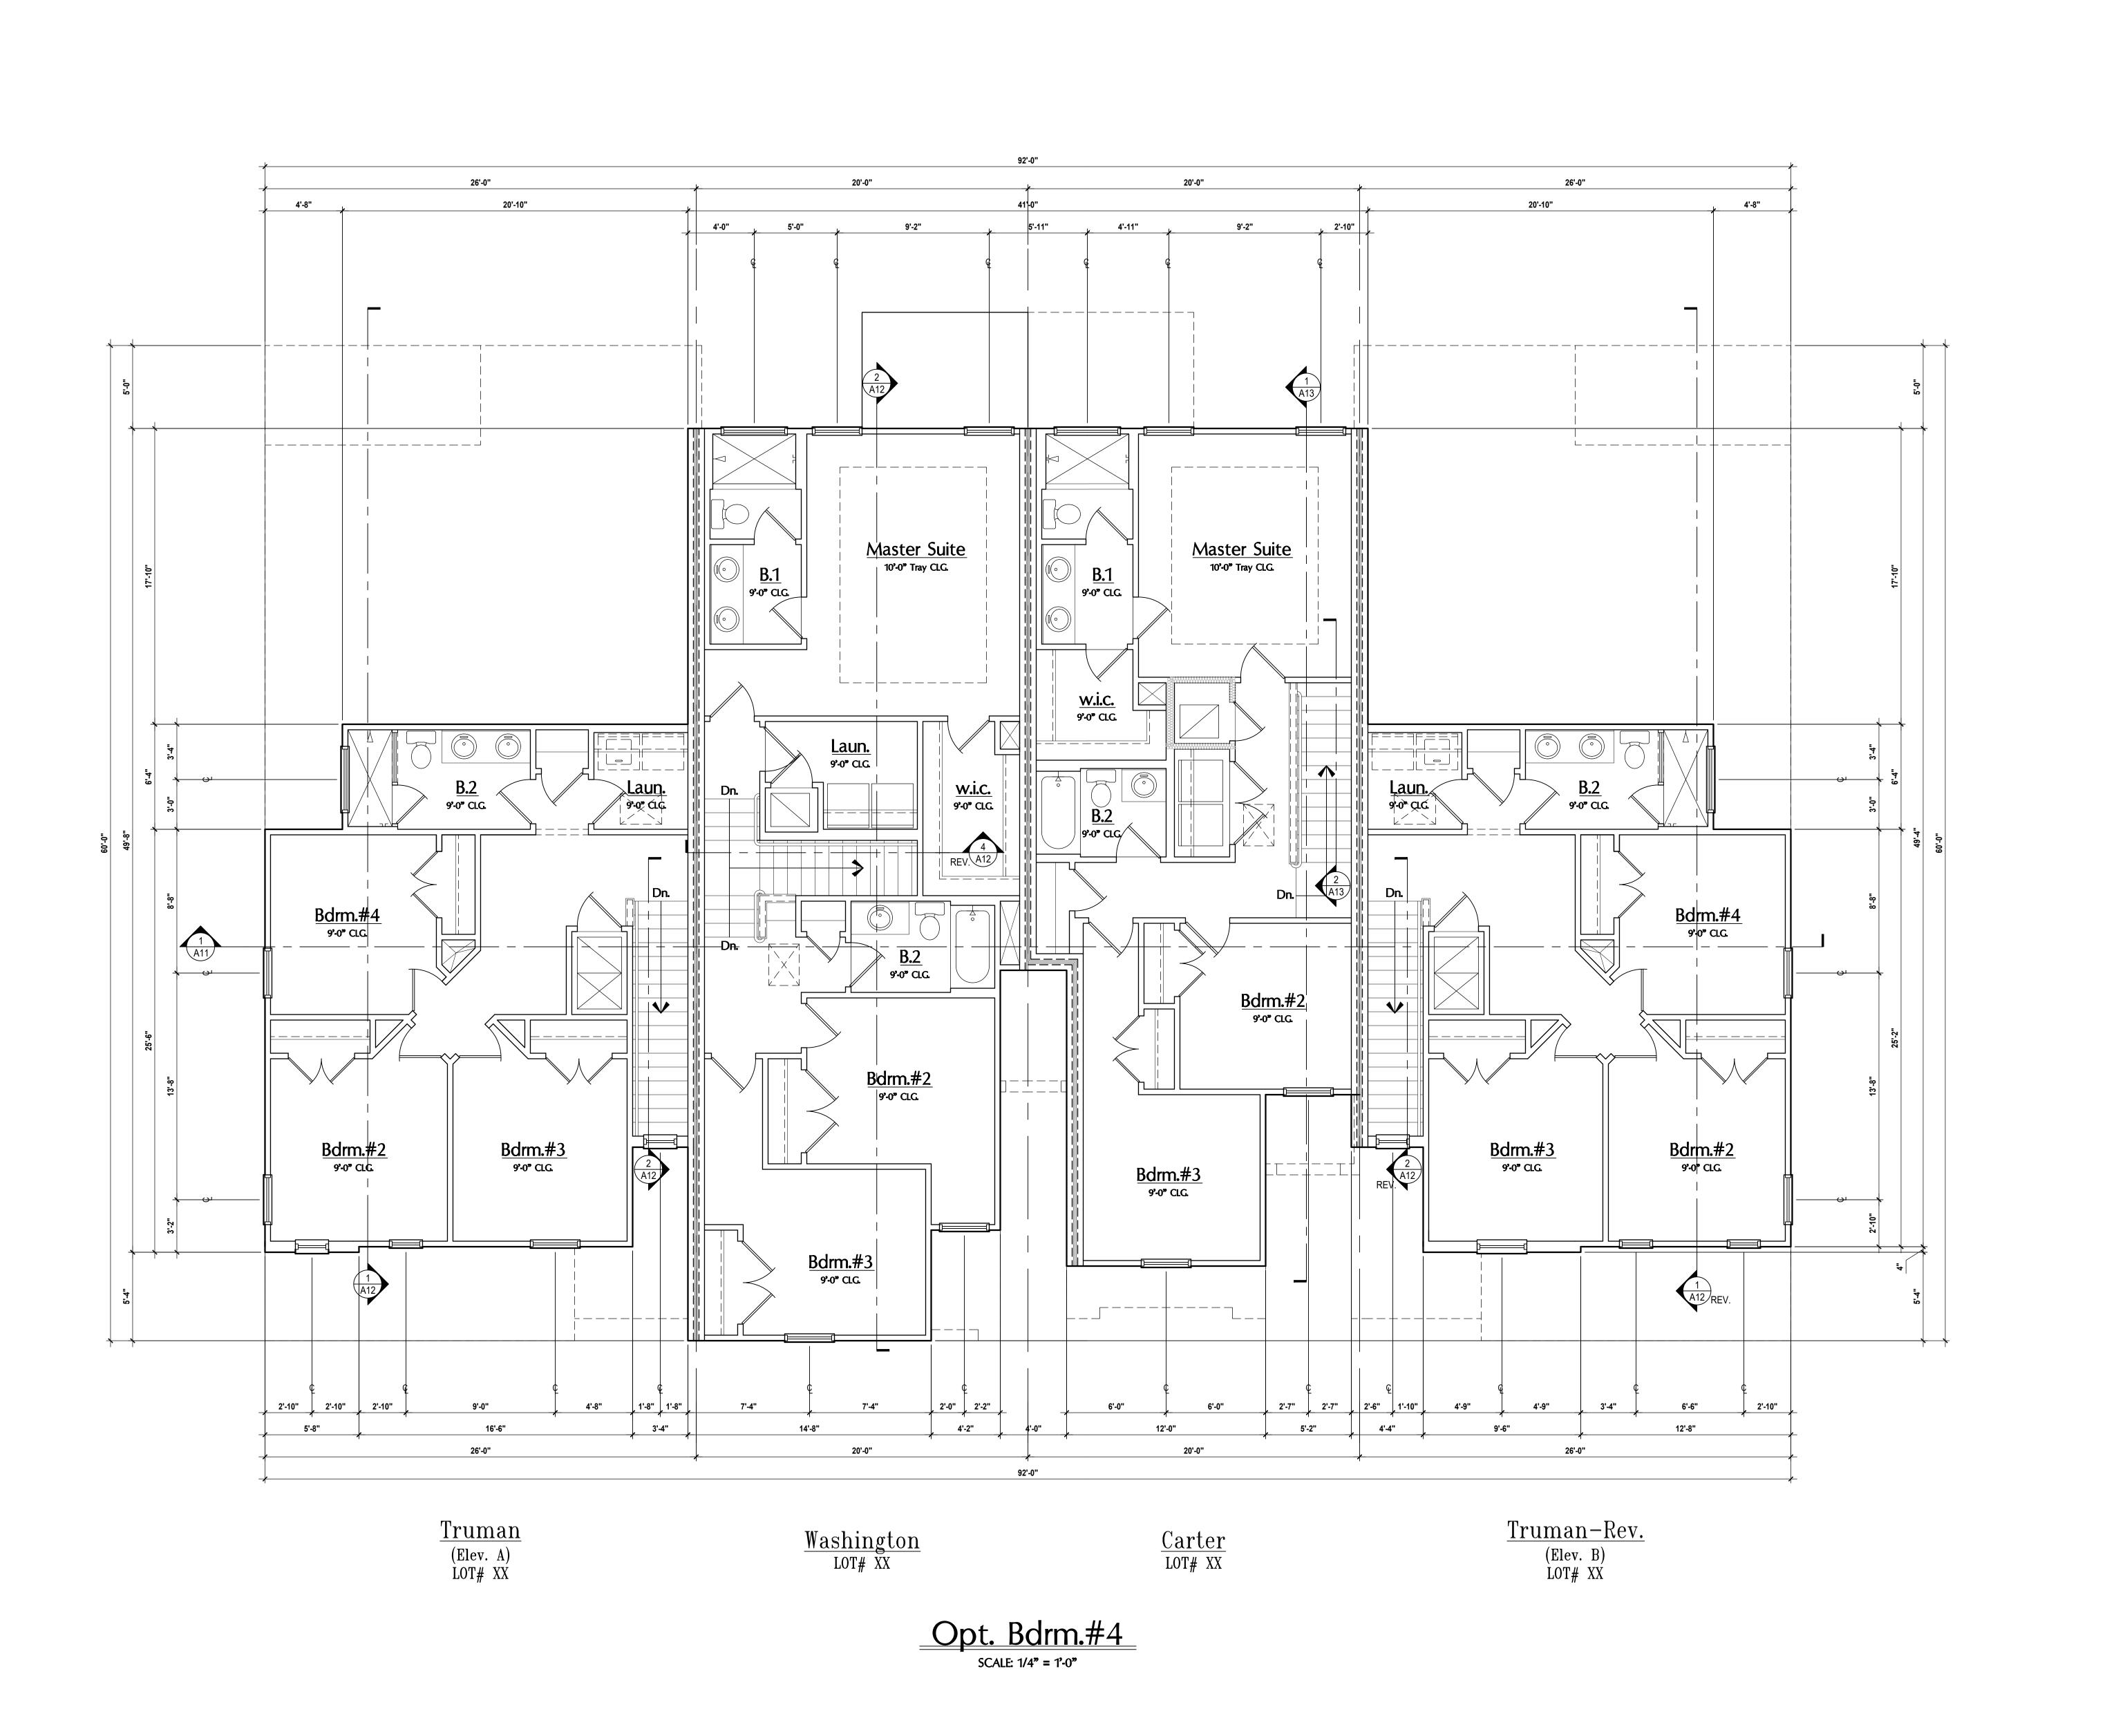

GENERAL NOTES KEY:

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NOTES:
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ALL WOOD TO MASONRY INTERFACES.

3. ALL INTERIOR FRAME WALL DIMENSIONS TO BE $3\frac{1}{2}$ " U.N.O. ALL EXTERIOR BLOCK WALL DIMENSIONS TO BE 7 $\frac{1}{2}$ " U.N.O. 5. C.M.U. & FRAME WALL SYSTEM SEGMENTS WHICH HAVE AN UNINTERRUPTED LENGTH OF 12'-0" OR MORE SHALL BE

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4. OPENING BETWEEN GARAGE AND RESIDENCE SHALL BE HONEYCOMB CORE STEEL DOOR NOT LESS THAN 1 3/8" THICKNESS AS PER FBC-R302.5.1.

CONTRACTOR / OWNER.

5. 1/2" GYPSUM BOARD APPLIED TO THE GARAGE SIDE OF WALL UNDERSIDE OF DECKING. 6. 5/8" TYPE X DRYWALL ON GARAGE CEILING BELOW ANY HABITABLE SPACE

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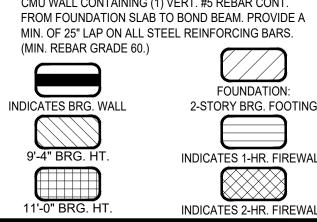
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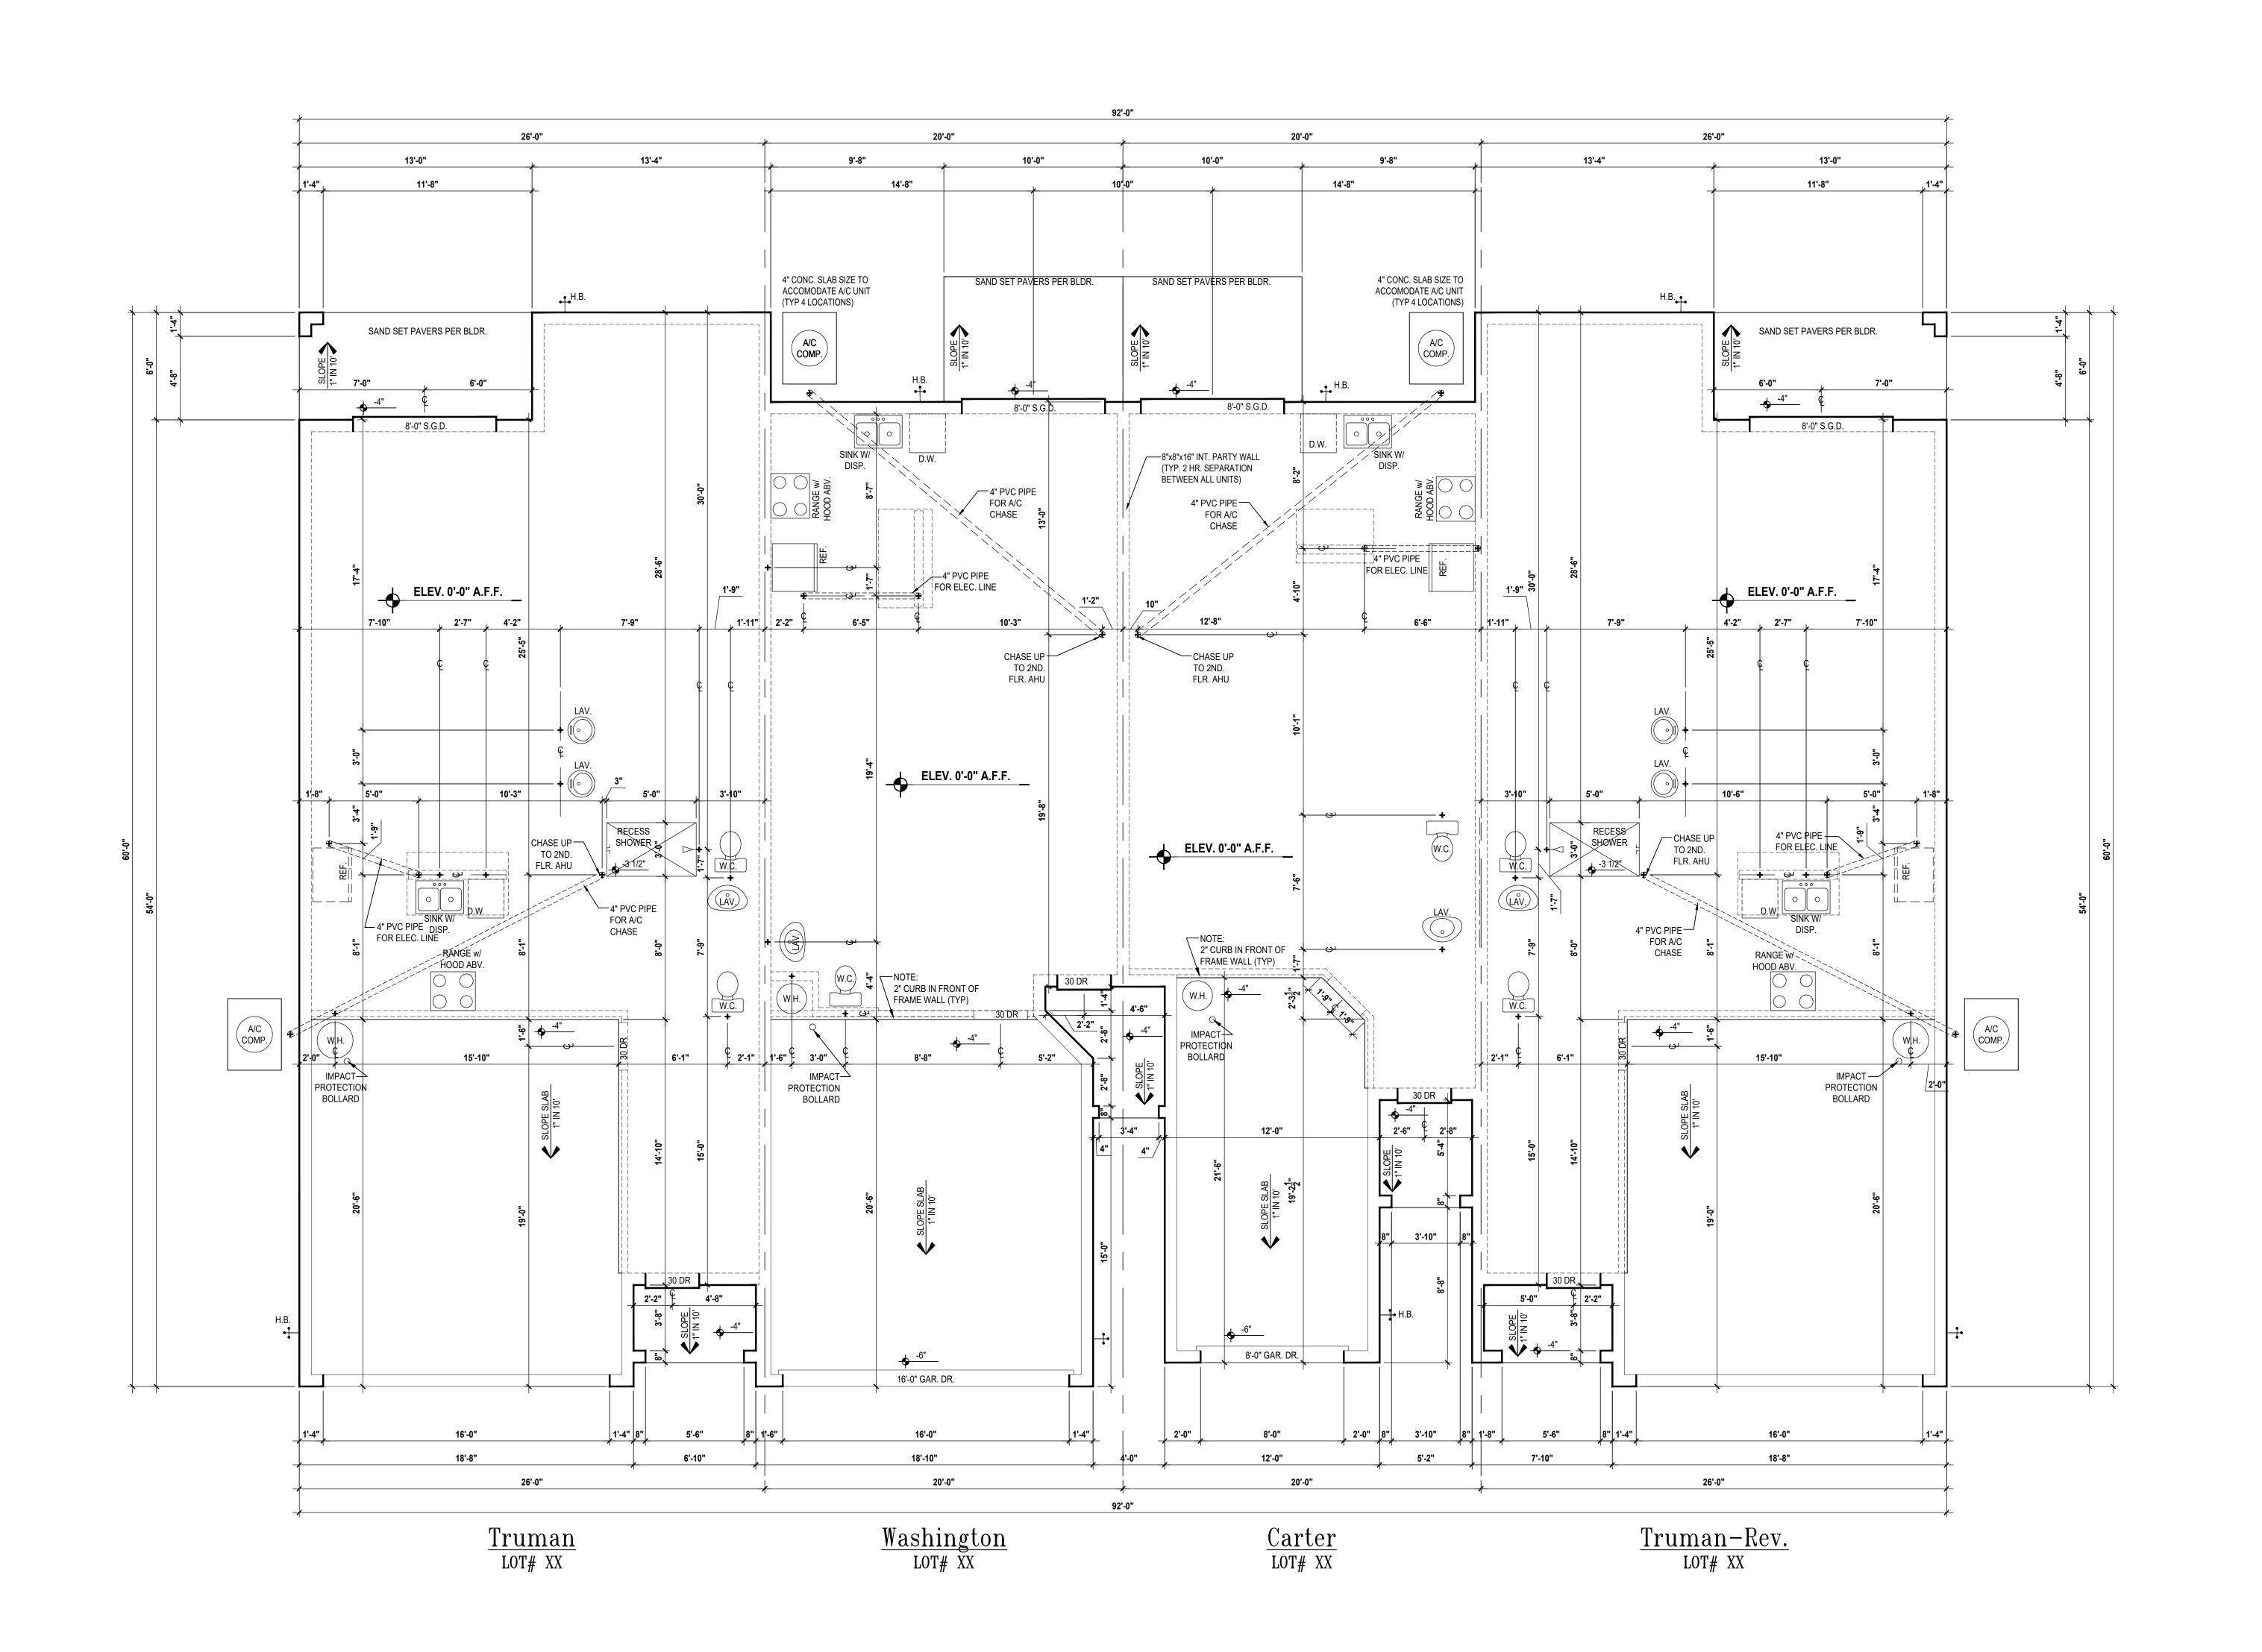
BRG. HT. LEGEND

- INDICATES A CONCRETE FILLED CELL WITHIN AN 8" CMU WALL CONTAINING (1) VERT. #5 REBAR CONT. (MIN. REBAR GRADE 60.) FOUNDATION: INDICATES BRG. WALL



PROJECT: 00-0000
SCALE: AS NOTED
DRAWN BY: C.C.
DESIGNED BY: MJS

Second Flr. Plan second overall SCALE: 1/4" = 1'-0"



GOBA
GREATER ORLANDO BUILDERS ASSOCIATION

Slab Plan


SCALE: 1/4" = 1'-0"

SLAB PLAN

5: 1/4" = 1-0"


Δ3

PROJECT: 00-0000
SCALE: AS NOTED
DRAWN BY: C.C.
DESIGNED BY: MJS

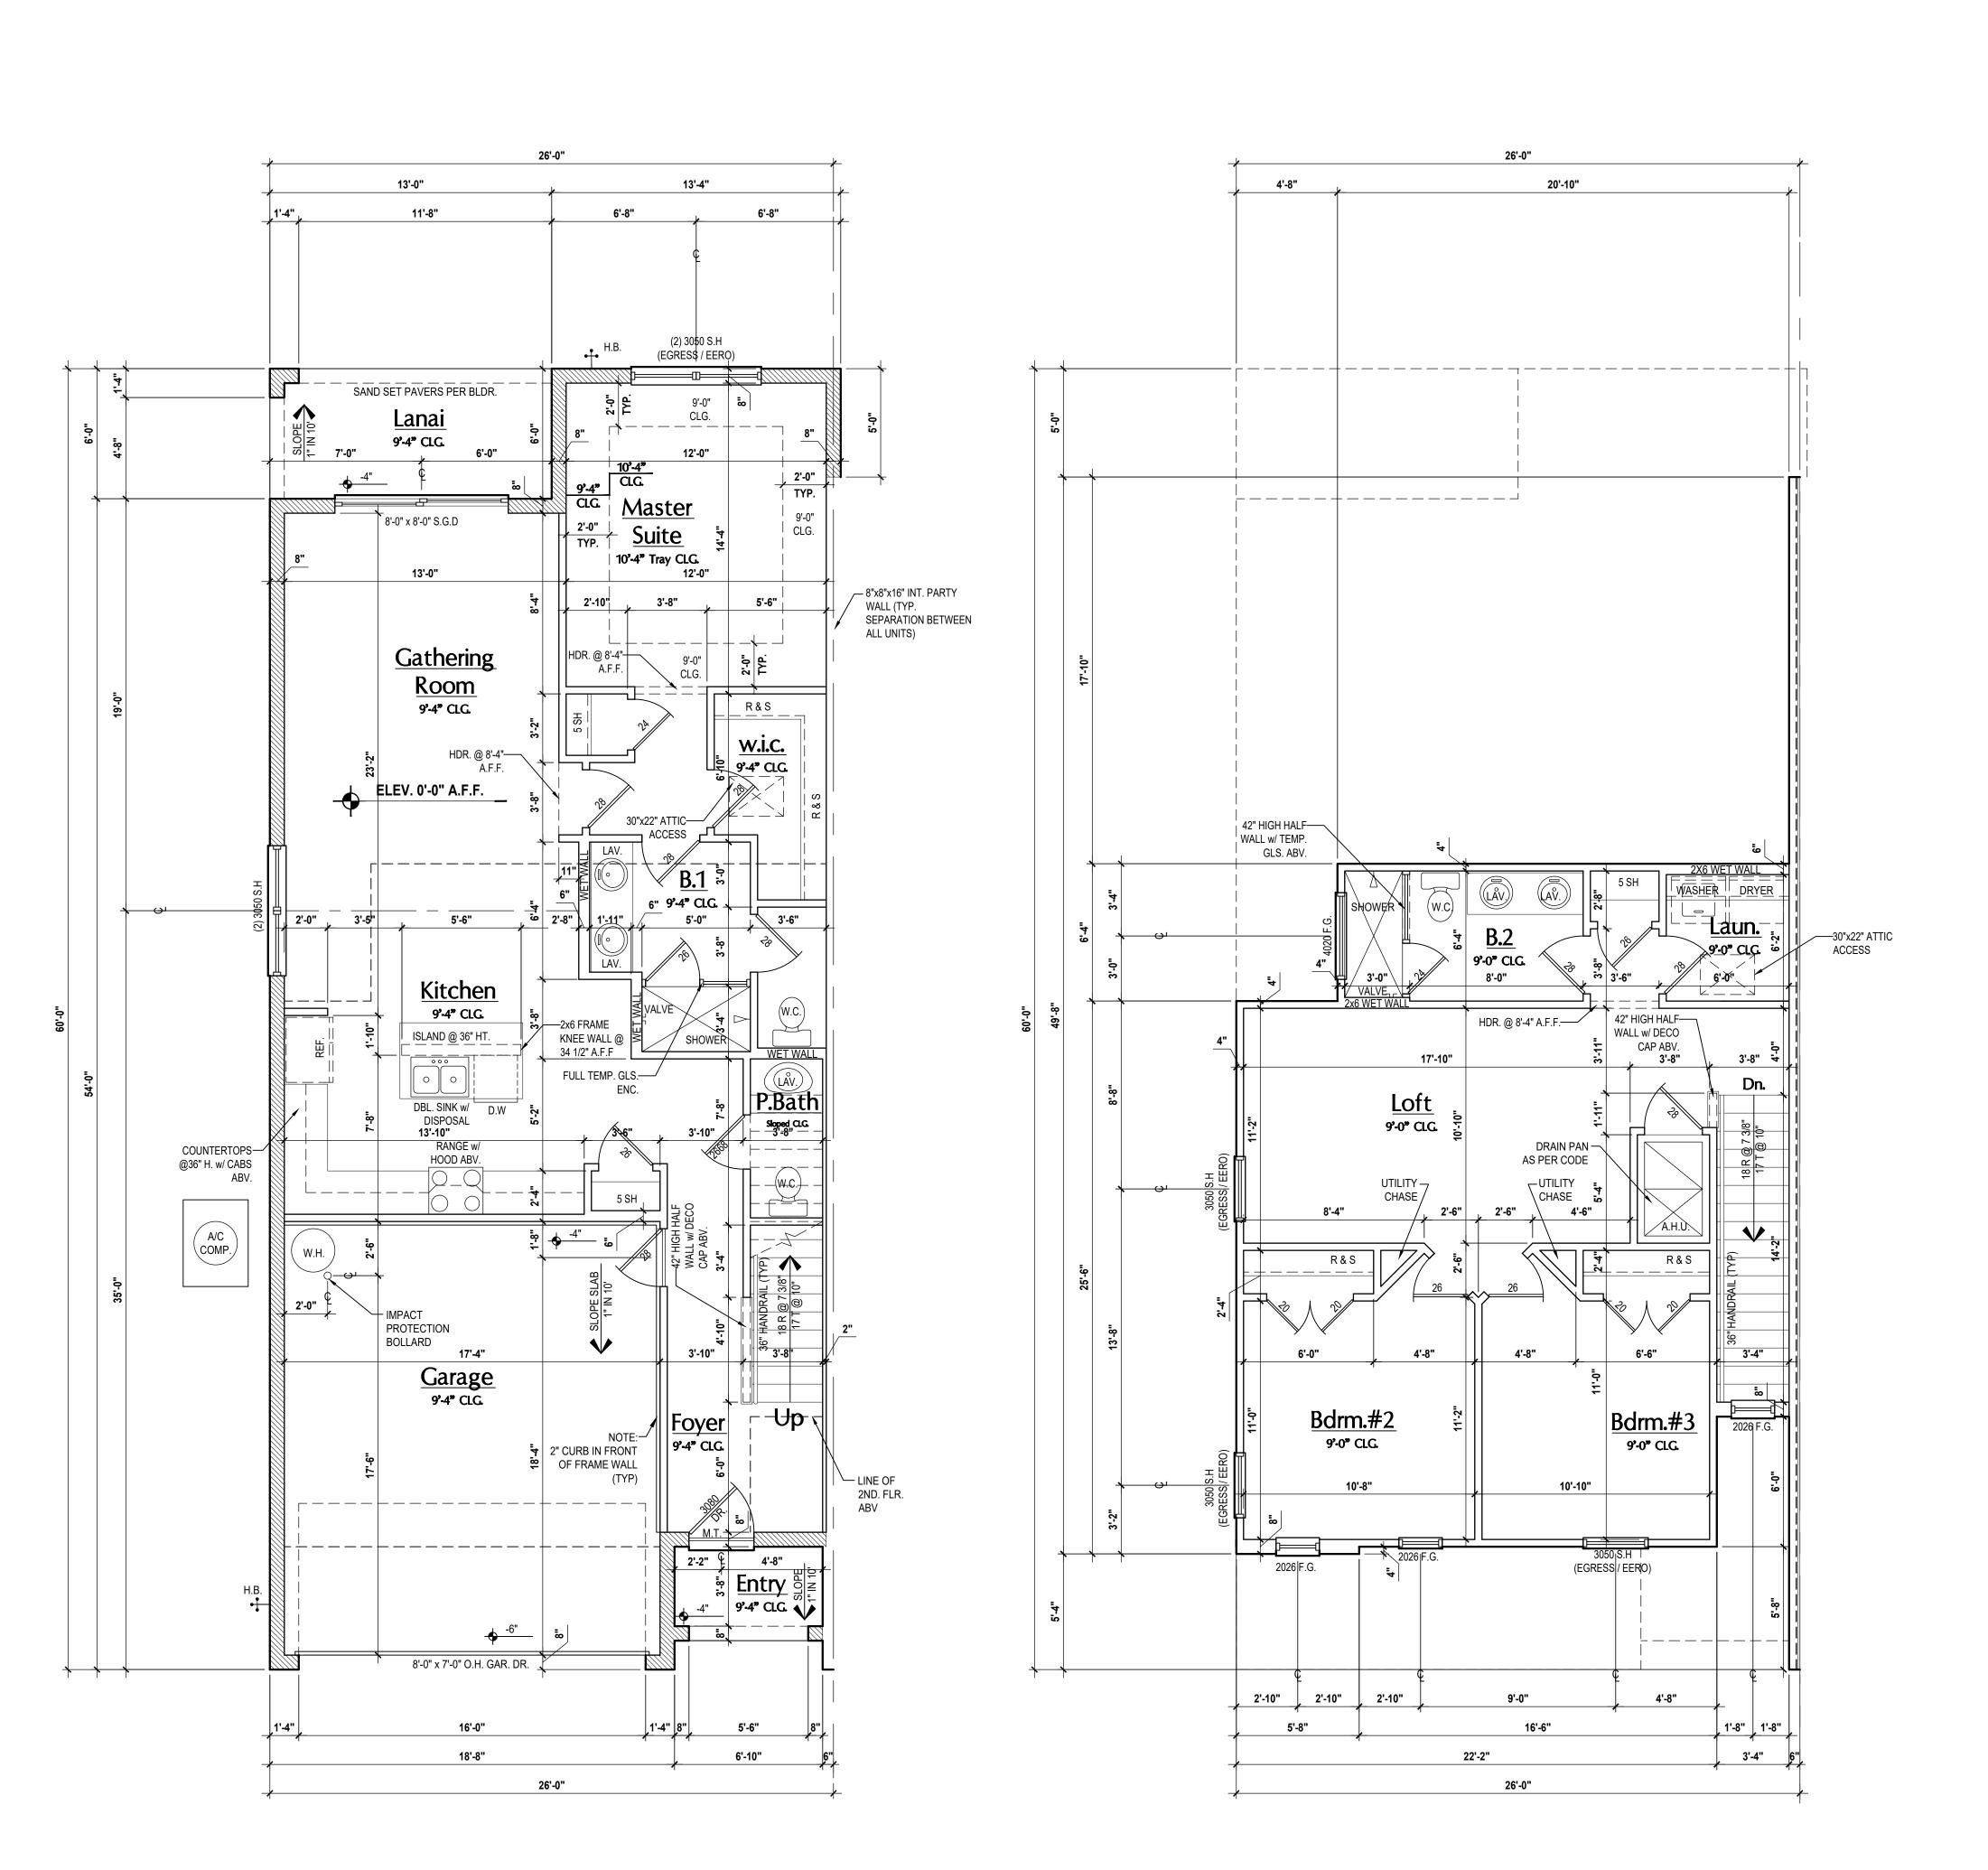

Truman- First Floor Plan (Standard)
SCALE: 1/4" = 1'-0"

Truman- Second Floor Plan

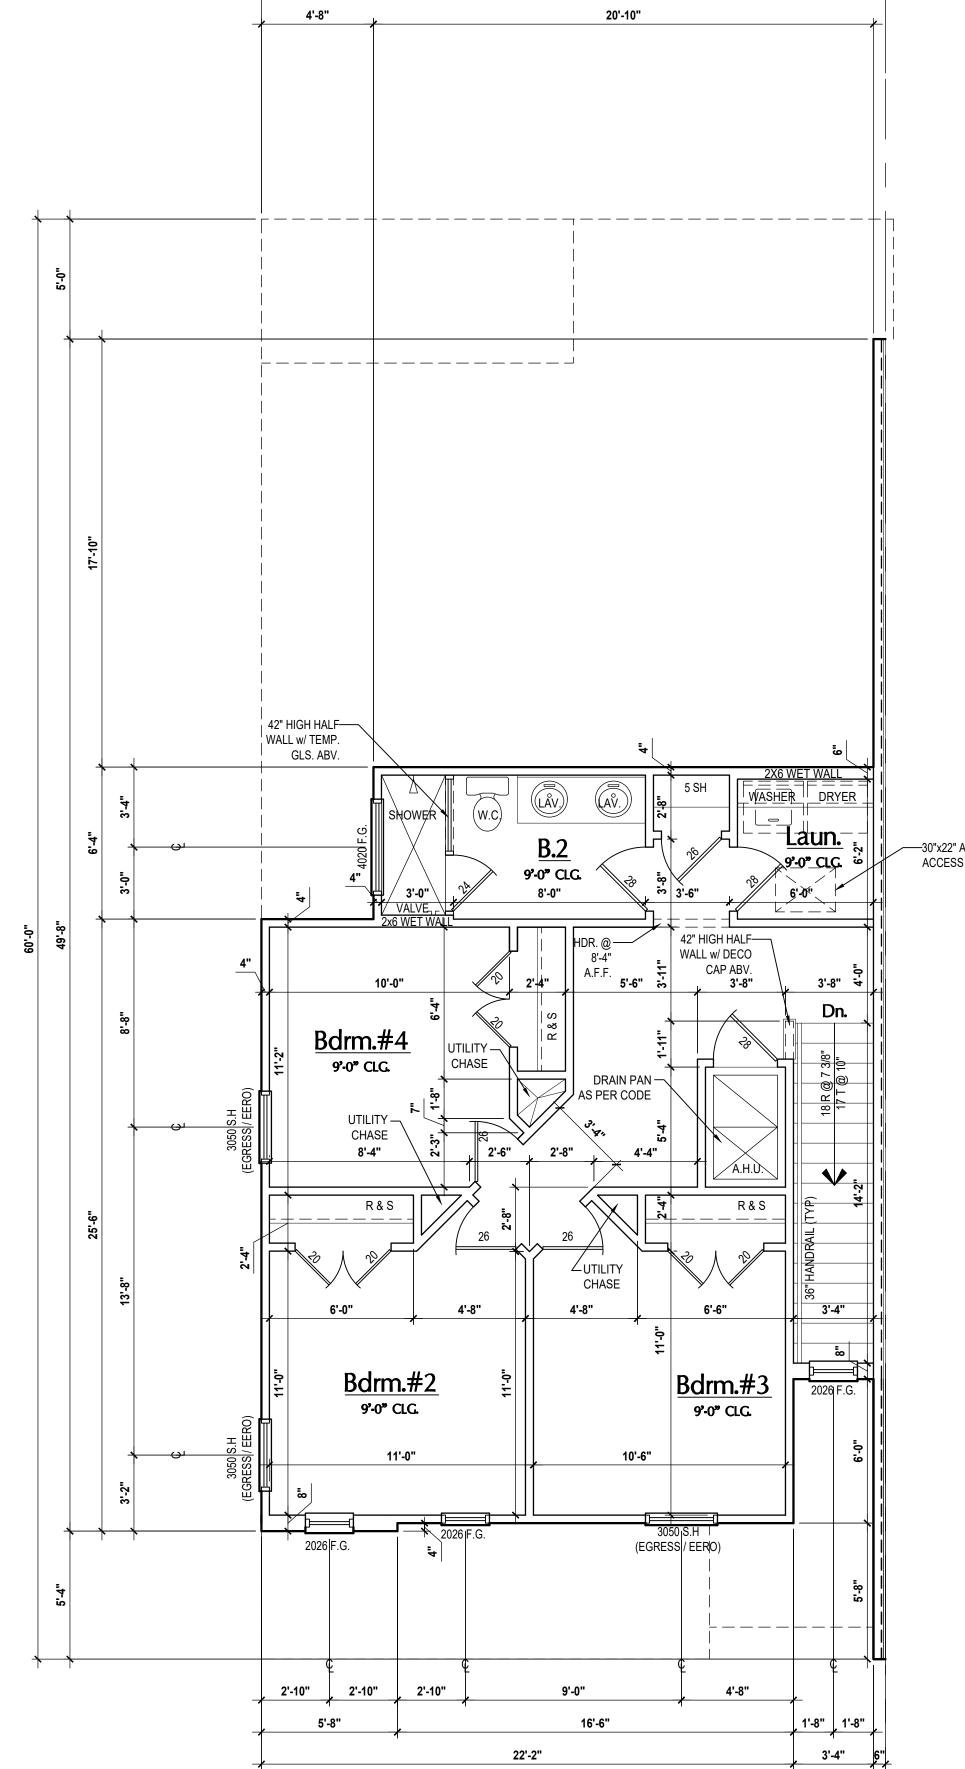

Truman- Second Floor Plan (Opt. Bdrm.#4) SCALE: 1/4" = 1'-0"

OBS - OBSCURED GLASS TEMP - TEMPERED GLASS FR - FRENCH DOORS SH - SINGLE HUNG SL - SIDE LIGHT DH - DOUBLE HUNG FG - FIXED GLASS CSMT- CASEMENT TR - TRANSOM HR - HORIZONTAL ROLLER GB - GLASS BLOCK BP - BYPASS

PKT - POCKET DOOR BF - BIFOLD TYP. - TYPICAL SVC - SERVICE DOOR CONTRACTOR TO VERIFY ALL DIMENSIONS ON JOB SITE.

DO NOT SCALE PRINTS! CONSTRUCTION TO BE FROM CALCULATED DIMENSIONS ONLY. ANY DISCREPANCIES OR ERRORS TO BE REPORTED PROMPTLY TO SUPERVISOR FOR

MECHANICAL EQUIP. LOCATIONS WILL BE DETERMINED BY

COMMUNITY AND COUNTY CODES. A/C CONDENSER UNIT TO BE ANCHORED TO SLAB PER CODE FBC-R M1307.2 & FBC-M 304, AND SHALL BE SUPPORTED ON

CONCRETE SLAB OR OTHER APPROVED MATERIAL NOTE LESS THAN 3" ABOVE ADJOINING GROUND, PER FBC-R M1305.1.4.1 PROVIDE RECESS H&C WATER W/ DRAIN @ WASHER SPACE.

VENT DRYER THRU EXTERIOR WALL U.N.O. PROVIDE COLD WATER LINE FOR ICE MAKER LINE @ REF.

PROVIDE RECESS H&C WATER W/ DRAIN @ WASHER SPACE.

SAG RESISTANT DRYWALL ON ALL CEILINGS.). PULL ALL DIMENSIONS FROM THE REAR OF PLAN.

. REFER TO EXTERIOR ELEVATIONS & TYP. DETAIL SHEETS FO EXTERIOR WALL FINISH SPEC'S. . REFER TO DETAIL SHEETS FOR FLASHING REQUIREMENTS AT ALL WOOD TO MASONRY INTERFACES.

. ALL INTERIOR FRAME WALL DIMENSIONS TO BE 3 ½" U.N.O. . ALL EXTERIOR BLOCK WALL DIMENSIONS TO BE 7 ½" U.N.O.

. C.M.U. & FRAME WALL SYSTEM SEGMENTS WHICH HAVE AN UNINTERRUPTED LENGTH OF 12'-0" OR MORE SHALL BE CONSIDERED SHEAR WALL SWS = SHEAR WALL SEGMENTS.

ENCLOSED SPACE UNDER STAIRS THAT IS ACCESSED BY A DOOR OR ACCESS PANEL SHALL HAVE WALLS, UNDER-STAIR SURFACE AND ANY SOFFITS PROTECTED ON THE ENCLOSED SIDE WITH 1/2-INCH (12.7 MM) GYPSUM BOARD. GARAGE DOOR TO BE CERTIFIED BY MFR. FOR MIN. 150 M.P.H.

ALL TUB & SHOWER UNITS WILL HAVE ANTI-SCALDING DEVICES

INSTALLED. ALL OPERABLE WINDOWS LOCATED MORE THAN 72" ABV. SURFACE BELOW SHALL HAVE THE LOWEST PORTION OF

WINDOW CLEAR OPENING A MIN. OF 24" ABOVE FINISHED FLOOF BEING SERVER PER (FBC-R312.2).

SEE COLOR SHEET FOR INTERIOR DOOR HEIGHT REQUIREMENTS. SPECIALTY WINDOWS/DOORS, FIXED GLASS WINDOWS, AND

TRANSOMS ARE NOTED ON PLANS. ALL DOORS & WINDOWS THAT ARE EGRESS WILL BE LABELED

AS SUCH AND CONFORM TO FBC R310.2 EERO SOIL TESTING IS RECOMMENDED, BUT IS NOT REQUIRED. THE DESIGN TEAM AT MJS & E.O.R STRONGLY RECOMMEND A SOIL TEST TO CONFIRM SOIL BEARING CAPACITY AND SURFACE GEO-TECHNICAL CONDITIONS. FOOTINGS SHALL BEAR ON UNDISTURBED SOIL A/O PROPERLY COMPACTED FILL (2000 PS MIN.). FILL MATERIAL SHALL BE COMPACTED TO 95% DENSITY

OF A STANDARD PROCTOR. TO BE VERIFIED BY GENERAL

24. OPENING BETWEEN GARAGE AND RESIDENCE SHALL BE HONEYCOMB CORE STEEL DOOR NOT LESS THAN 1 3/8" THICKNESS AS PER FBC-R302.5.1.

CONTRACTOR / OWNER.

1/2" GYPSUM BOARD APPLIED TO THE GARAGE SIDE OF WALL UNDERSIDE OF DECKING.

5. 5/8" TYPE X DRYWALL ON GARAGE CEILING BELOW ANY HABITABLE SPACE

THERMAL BARRIER: FOAM PLASTIC SHALL BE SEPARATED FROM THE INTERIOR OF A BUILDING BY NOT LESS THAN 1/2-INCH (12.7 MM) GYPSUM WALLBOARD, 23/32-INCH (18.2 MM) WOOD STRUCTURAL PANEL OR A MATERIAL THAT IS TESTED IN ACCORDANCE WITH AND MEETS THE ACCEPTANCE CRITERIA OF BOTH THE TEMPERATURE TRANSMISSION FIRE TEST AND THE

INTEGRITY FIRE TEST OF NFPA 275. ADDRESS NOTIFICATION SHALL BE IN ACCORDANCE w/ SECTION

ANY EXTERIOR WALL ELECTRICAL, MECHANICAL AND PLUMBING PENETRATIONS SHOULD BE FITTED WITH QUICKFLASH PANELS

ATTIC ACCESS OPENING SHOULD BE WEATHERSTRIPPED AND INSULATED TO LEVEL EQUIVALENT TO INSULATION ON THE SURROUNDING AREAS PER FBCEC R402.2.4.

FILL VOIDS OF UNDERSIDE OF TUBS & SHOWERS WITH INSULATION FOR ACOUSTIC DAMPENING. ADD ACOUSTIC OR VIBRATION ISOLATION DEVICES AT GARAGE

DOOR OPENERS THAT ARE ADJACENT TO HABITABLE SPACES

BACKER UNITS (ASTM C1325) SHALL BE USED PER FBCR R702.4.

GLASS MAT GYPSUM BACKING PANELS (ASTM C1178), OR NON-ASBESTOS FIBER MAT REINFORCED CEMENTITIOUS

PAPER-FACED GYPSUM BOARD SHALL NOT BE USED. WINDOW / DOOR NOTE KEY

050 = 2'-0" x 5'-0" 060 = 2'-0" x 6'-0" ALL WINDOW CALLOUTS ARE MEASURED IN FEET & INCHES AS PER THE EXAMPLE TABLE ABOVE.

24 = 2'-4" 50 B.F. = 5'-0" BI-FOLD 26 = 2'-6" 60 B.F. = 6'-0" BI-FOLD

ALL INTERIOR DOOR HEIGHTS ARE TO BE DETERMINED BY

ROM FOUNDATION SLAB TO BOND BEAM. PROVIDE A MM OF 5" LAP ON ALL STEEL REINFORCING BARS. FOUNDATION:

2-STORY BRG. FOOTING INDICATES 1-HR. FIREWAL INDICATES 2-AR. PEREWA

Area Tabulations

Living: 1st floor: 723 sf 2nd floor: Total Living: 1,788 sf


Total Area: Floor Plan


SCALE: 1/4" = 1'-0"

FLOOR PLANS

DRAWN BY: C.C.



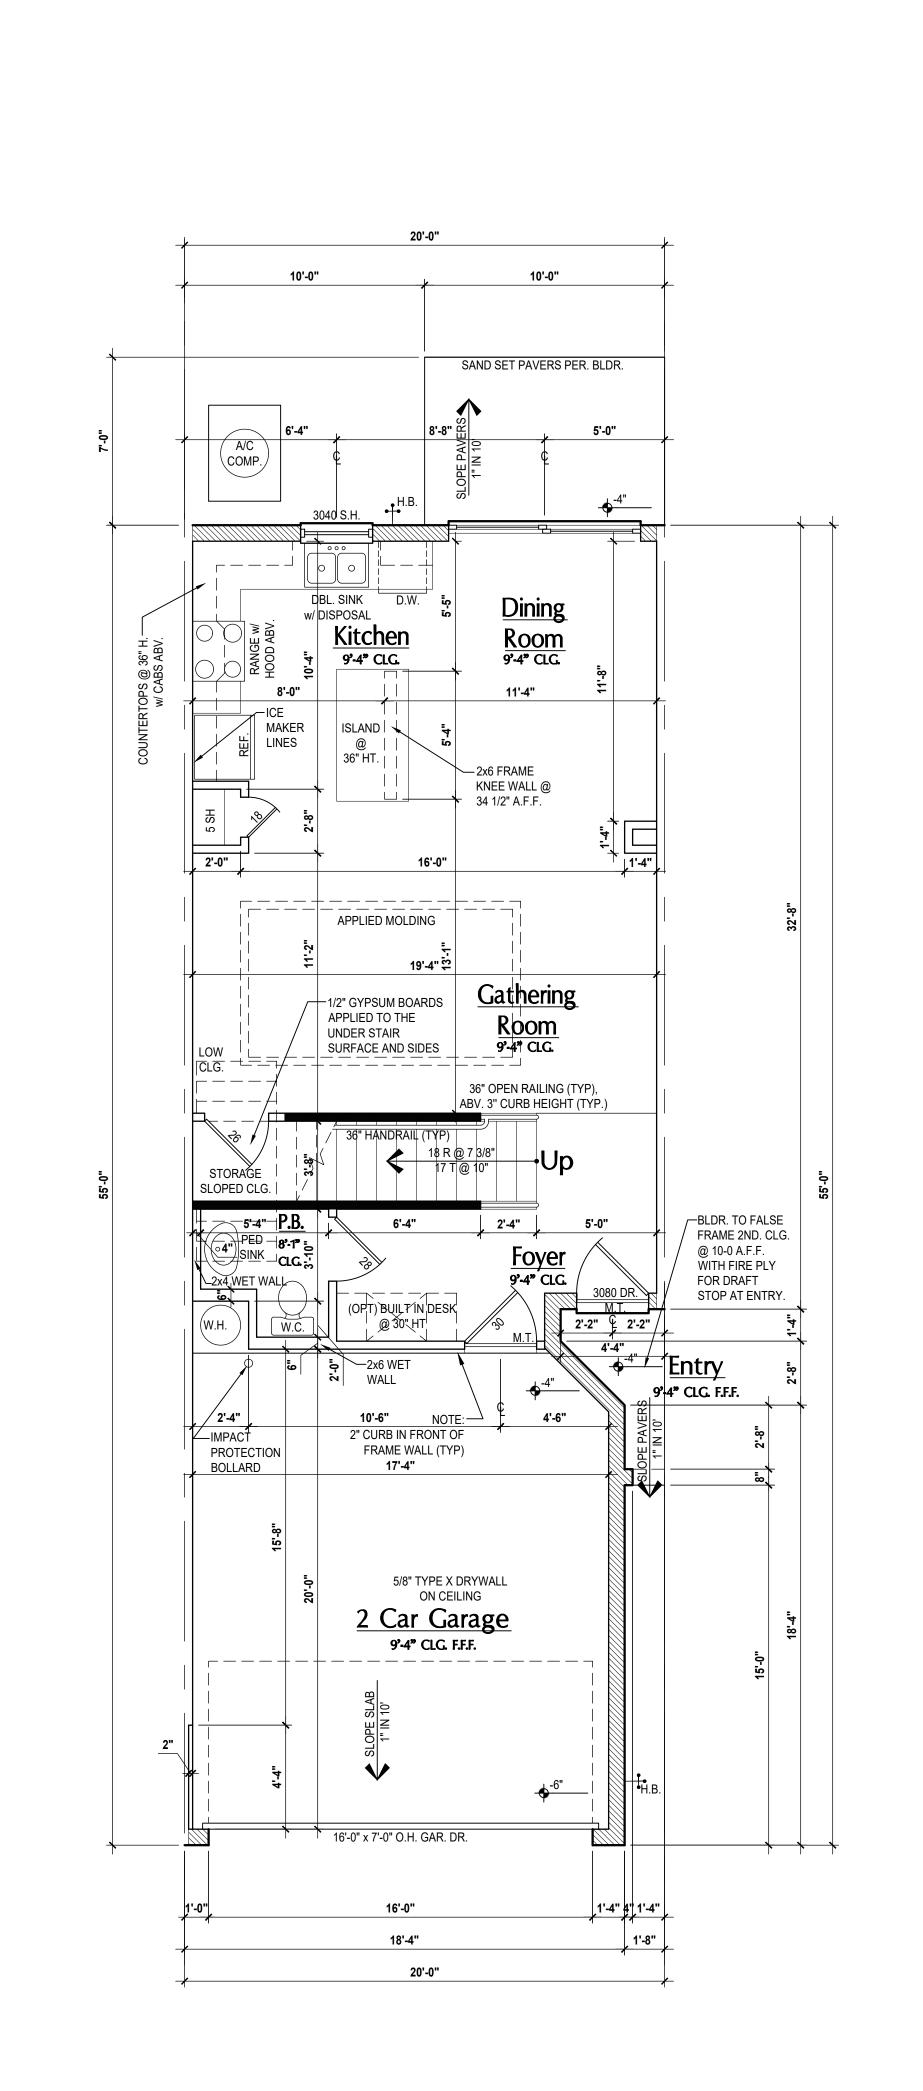

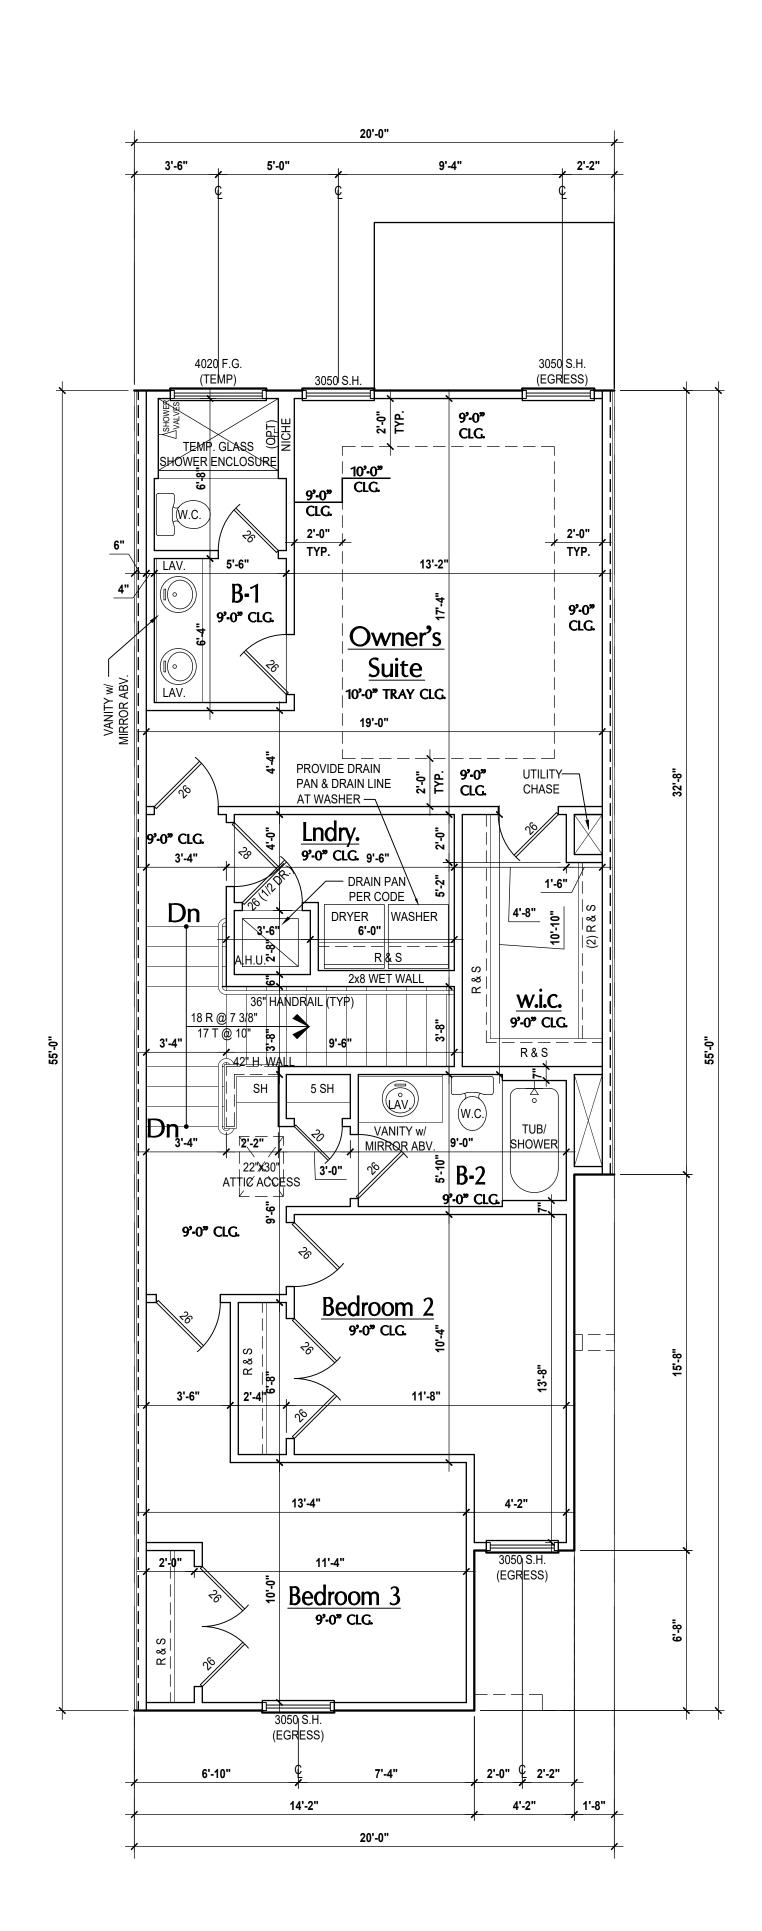

Washington- First Floor Plan (Standard)
SCALE: 1/4" = 1'-0"

Washington- Second Floor Plan (Standard)
SCALE: 1/4" = 1'-0"

GENERAL NOTES KEY: TEMP - TEMPERED GLASS FR - FRENCH DOORS SH - SINGLE HUNG SL - SIDE LIGHT DH - DOUBLE HUNG G - FIXED GLASS CSMT- CASEMENT R - TRANSOM HR - HORIZONTAL ROLLER GB - GLASS BLOCK PKT - POCKET DOOR SVC - SERVICE DOOR

CONTRACTOR TO VERIFY ALL DIMENSIONS ON JOB SITE. <u>DO NOT SCALE PRINTS!</u> CONSTRUCTION TO BE FROM CALCULATED DIMENSIONS ONLY. ANY DISCREPANCIES OR ERRORS TO BE REPORTED PROMPTLY TO SUPERVISOR FOR

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A/C CONDENSER UNIT TO BE ANCHORED TO SLAB PER CODE FBC-R M1307.2 & FBC-M 304, AND SHALL BE SUPPORTED ON CONCRETE SLAB OR OTHER APPROVED MATERIAL NOTE LESS THAN 3" ABOVE ADJOINING GROUND, PER FBC-R M1305.1.4.1

VENT DRYER THRU EXTERIOR WALL U.N.O. PROVIDE COLD WATER LINE FOR ICE MAKER LINE @ REF.

PROVIDE RECESS H&C WATER W/ DRAIN @ WASHER SPACE.

PROVIDE RECESS H&C WATER W/ DRAIN @ WASHER SPACE. SAG RESISTANT DRYWALL ON ALL CEILINGS.

). PULL ALL DIMENSIONS FROM THE REAR OF PLAN.

. REFER TO EXTERIOR ELEVATIONS & TYP. DETAIL SHEETS FOR EXTERIOR WALL FINISH SPEC'S.

REFER TO DETAIL SHEETS FOR FLASHING REQUIREMENTS AT ALL WOOD TO MASONRY INTERFACES.

3. ALL INTERIOR FRAME WALL DIMENSIONS TO BE 3 $\frac{1}{2}$ " U.N.O. I. ALL EXTERIOR BLOCK WALL DIMENSIONS TO BE 7 $\frac{1}{2}$ " U.N.O. 5. C.M.U. & FRAME WALL SYSTEM SEGMENTS WHICH HAVE AN

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SIDE WITH 1/2-INCH (12.7 MM) GYPSUM BOARD.

GARAGE DOOR TO BE CERTIFIED BY MFR. FOR MIN. 150 M.P.H. 3. ALL TUB & SHOWER UNITS WILL HAVE ANTI-SCALDING DEVICES

O. ALL OPERABLE WINDOWS LOCATED MORE THAN 72" ABV. SURFACE BELOW SHALL HAVE THE LOWEST PORTION OF

WINDOW CLEAR OPENING A MIN. OF 24" ABOVE FINISHED FLOO BEING SERVER PER (FBC-R312.2).

). SEE COLOR SHEET FOR INTERIOR DOOR HEIGHT REQUIREMENTS.

. SPECIALTY WINDOWS/DOORS, FIXED GLASS WINDOWS, AND TRANSOMS ARE NOTED ON PLANS. ALL DOORS & WINDOWS THAT ARE EGRESS WILL BE LABELED

AS SUCH AND CONFORM TO FBC R310.2 EERO SOIL TESTING IS RECOMMENDED, BUT IS NOT REQUIRED. THE DESIGN TEAM AT MJS & E.O.R STRONGLY RECOMMEND A SOIL TEST TO CONFIRM SOIL BEARING CAPACITY AND SURFACE GEO-TECHNICAL CONDITIONS. FOOTINGS SHALL BEAR ON UNDISTURBED SOIL A/O PROPERLY COMPACTED FILL (2000 PS

MIN.). FILL MATERIAL SHALL BE COMPACTED TO 95% DENSITY OF A STANDARD PROCTOR. TO BE VERIFIED BY GENERAL

4. OPENING BETWEEN GARAGE AND RESIDENCE SHALL BE EQUIPPED WITH A 20 MIN. FIRE RATED SOLID WOOD OR HONEYCOMB CORE STEEL DOOR NOT LESS THAN 1 3/8"

THICKNESS AS PER FBC-R302.5.1. . 1/2" GYPSUM BOARD APPLIED TO THE GARAGE SIDE OF WAL UNDERSIDE OF DECKING. 3. 5/8" TYPE X DRYWALL ON GARAGE CEILING BELOW ANY

CONTRACTOR / OWNER.

HABITABLE SPACE THERMAL BARRIER: FOAM PLASTIC SHALL BE SEPARATED FRO THE INTERIOR OF A BUILDING BY NOT LESS THAN 1/2-INCH (12.7 MM) GYPSUM WALLBOARD, 23/32-INCH (18.2 MM) WOOD STRUCTURAL PANEL OR A MATERIAL THAT IS TESTED IN ACCORDANCE WITH AND MEETS THE ACCEPTANCE CRITERIA O BOTH THE TEMPERATURE TRANSMISSION FIRE TEST AND THE

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ATTIC ACCESS OPENING SHOULD BE WEATHERSTRIPPED AND INSULATED TO LEVEL EQUIVALENT TO INSULATION ON THE SURROUNDING AREAS PER FBCEC R402.2.4.

FILL VOIDS OF UNDERSIDE OF TUBS & SHOWERS WITH

INSULATION FOR ACOUSTIC DAMPENING. ADD ACOUSTIC OR VIBRATION ISOLATION DEVICES AT GARAGE DOOR OPENERS THAT ARE ADJACENT TO HABITABLE SPACES

WHERE WALL TILE IS INSTALLED IN TUB AND SHOWER AREAS, GLASS MAT GYPSUM BACKING PANELS (ASTM C1178), FIBER-REINFORCED GYPSUM PANELS (ASTM C1278), NON-ASBESTOS FIBER-CEMENT BACKER BOARD (ASTM C1288 OR NON-ASBESTOS FIBER MAT REINFORCED CEMENTITIOUS BACKER UNITS (ASTM C1325) SHALL BE USED PER FBCR R702.4. PAPER-FACED GYPSUM BOARD SHALL NOT BE USED.


2050 = 2'-0" x 5'-0" 2060 = 2'-0" x 6'-0"

ALL WINDOW CALLOUTS ARE MEASURED IN FEET & INCHES AS PER THE EXAMPLE TABLE ABOVE.

<u>JOOR SIZE CALLOUT:</u> 20 = 2'-0" 40 B.F. = 4'-0" BI-FOLD 24 = 2'-4" 50 B.F. = 5'-0" BI-FOLD 26 = 2'-6" 60 B.F. = 6'-0" BI-FOLD

ALL INTERIOR DOOR HEIGHTS ARE TO BE DETERMINED I

INDICATES A CONCRETE FILLED CELL WITHIN AN 8"
 CMU WALL CONTAINING (1) VERT. #5 REBAR CONT.

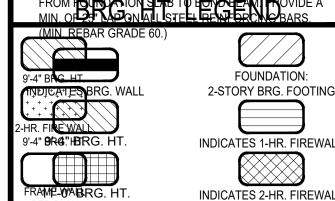



HEIGHTS ARE FROM 0'-0" FIN.

Area Tabulations 1st floor: 679 s 976 sf 2nd floor: 1,655 sf Total Living:

2,067 Total Area: Floor Plan

FLOOR PLANS SCALE: 1/4" = 1'-0"

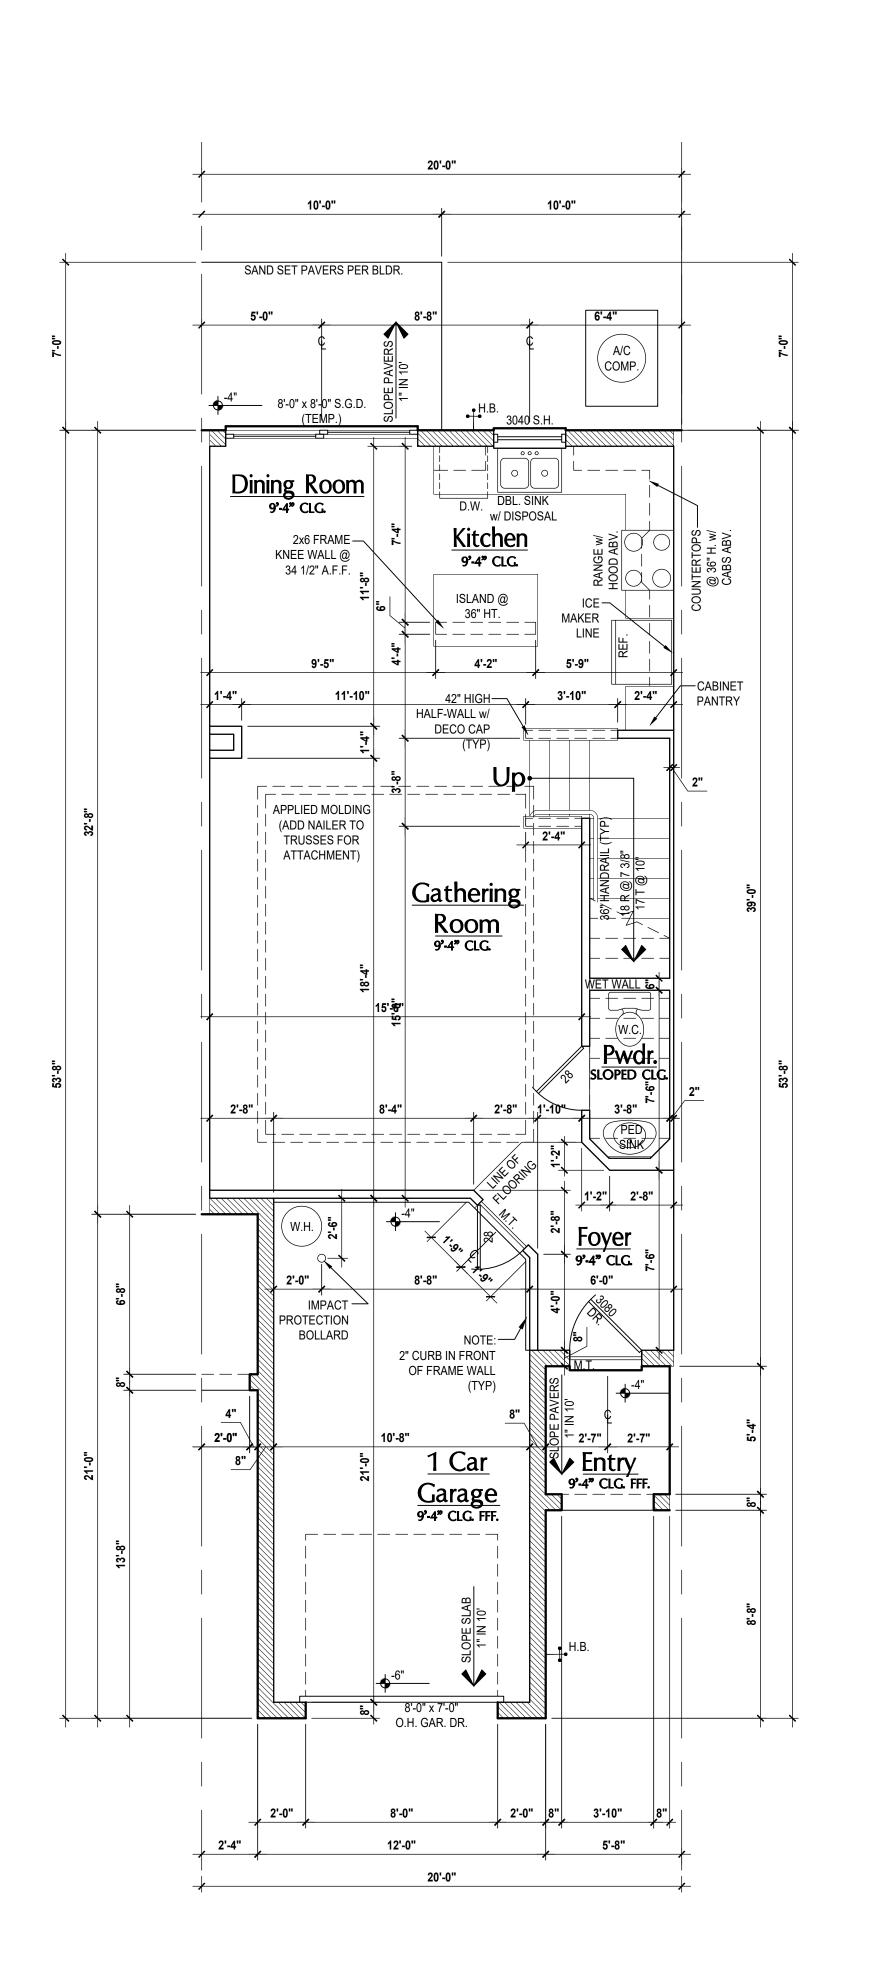

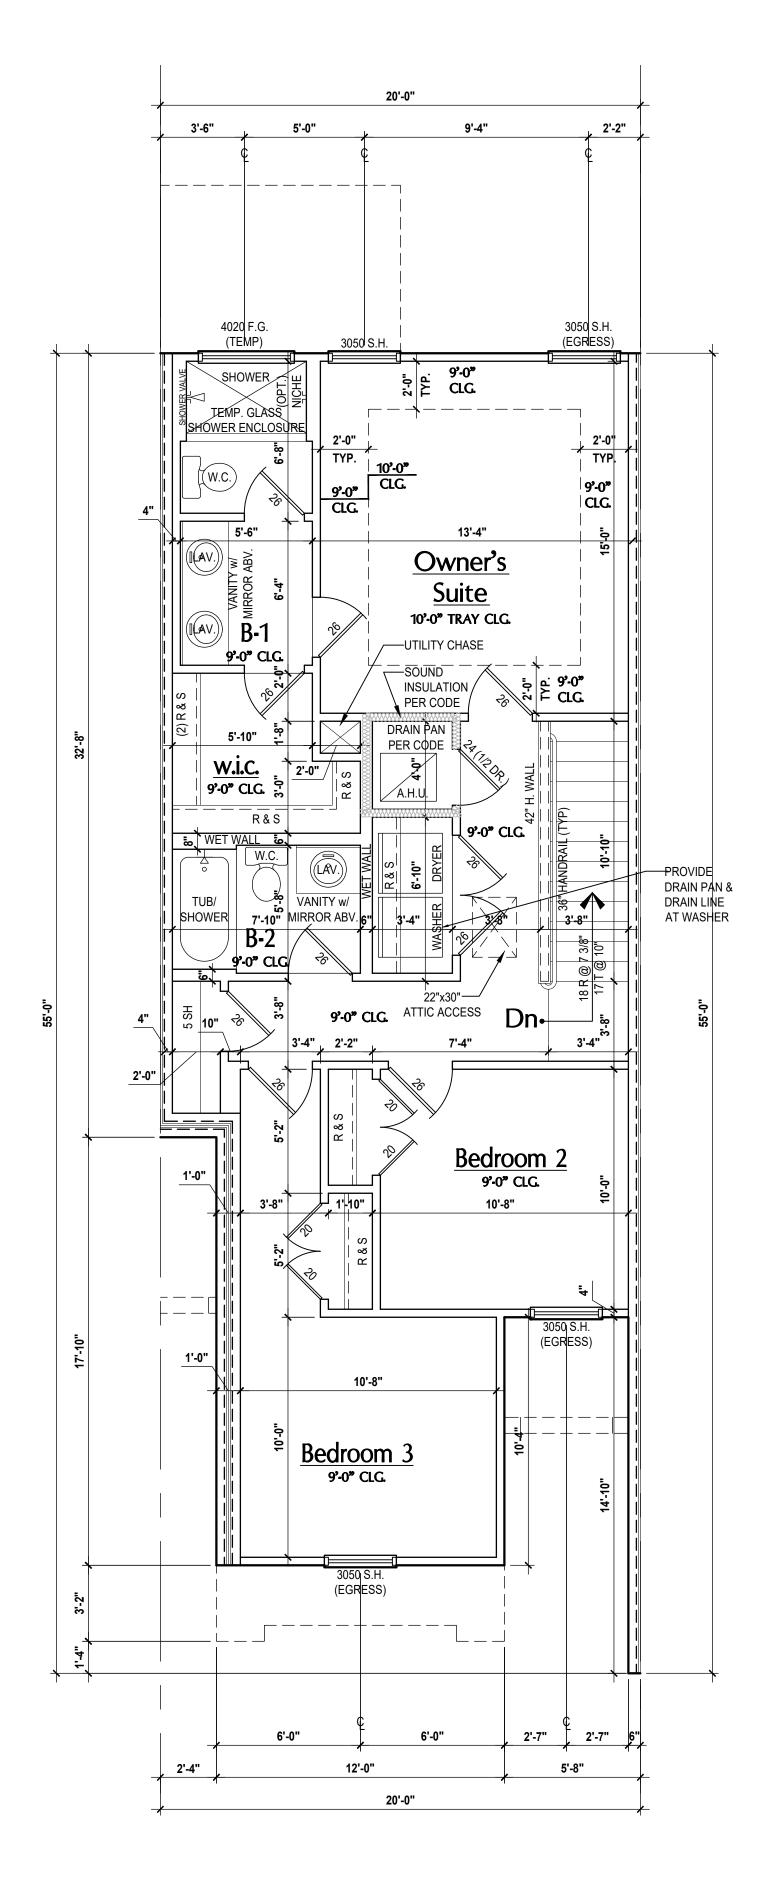

Carter- First Floor Plan

(Standard)
SCALE: 1/4" = 1'-0"

Carter- Second Floor Plan (Standard)
SCALE: 1/4" = 1'-0"

TEMP - TEMPERED GLASS FR - FRENCH DOORS SH - SINGLE HUNG SL - SIDE LIGHT DH - DOUBLE HUNG FG - FIXED GLASS CSMT- CASEMENT TR - TRANSOM

HR - HORIZONTAL ROLLER GB - GLASS BLOCK BP - BYPASS PKT - POCKET DOOR BF - BIFOLD SVC - SERVICE DOOR CONTRACTOR TO VERIFY ALL DIMENSIONS ON JOB SITE.

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PROVIDE RECESS H&C WATER W/ DRAIN @ WASHER SPACE. SAG RESISTANT DRYWALL ON ALL CEILINGS.

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. REFER TO DETAIL SHEETS FOR FLASHING REQUIREMENTS AT ALL WOOD TO MASONRY INTERFACES.

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4. ALL EXTERIOR BLOCK WALL DIMENSIONS TO BE 7 $\frac{1}{2}$ " U.N.O. 5. C.M.U. & FRAME WALL SYSTEM SEGMENTS WHICH HAVE AN UNINTERRUPTED LENGTH OF 12'-0" OR MORE SHALL BE

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. GARAGE DOOR TO BE CERTIFIED BY MFR. FOR MIN. 150 M.P.H. . ALL TUB & SHOWER UNITS WILL HAVE ANTI-SCALDING DEVICES

9. ALL OPERABLE WINDOWS LOCATED MORE THAN 72" ABV. SURFACE BELOW SHALL HAVE THE LOWEST PORTION OF WINDOW CLEAR OPENING A MIN. OF 24" ABOVE FINISHED FLOOI

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EQUIPPED WITH A 20 MIN. FIRE RATED SOLID WOOD OR HONEYCOMB CORE STEEL DOOR NOT LESS THAN 1 3/8" THICKNESS AS PER FBC-R302.5.1. 1/2" GYPSUM BOARD APPLIED TO THE GARAGE SIDE OF WA

UNDERSIDE OF DECKING. 6. 5/8" TYPE X DRYWALL ON GARAGE CEILING BELOW ANY HABITABLE SPACE

THERMAL BARRIER: FOAM PLASTIC SHALL BE SEPARATED FRO THE INTERIOR OF A BUILDING BY NOT LESS THAN 1/2-INCH (12.7 MM) GYPSUM WALLBOARD, 23/32-INCH (18.2 MM) WOOD STRUCTURAL PANEL OR A MATERIAL THAT IS TESTED IN ACCORDANCE WITH AND MEETS THE ACCEPTANCE CRITERIA OF BOTH THE TEMPERATURE TRANSMISSION FIRE TEST AND THE INTEGRITY FIRE TEST OF NFPA 275.

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FILL VOIDS OF UNDERSIDE OF TUBS & SHOWERS WITH INSULATION FOR ACOUSTIC DAMPENING.

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050 = 2'-0" x 5'-0"

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ALL INTERIOR DOOR HEIGHTS ARE TO BE DETERMINED BY

MIN. OF 5" LAP ON ALL STEEL REINFORCING BARS. FOUNDATION: INDICATES 1-HR. FIREWALL INDICATES 2-AR. PIRKEW

Area Tabulations

7 lica Tabalations			
	1st floor:	689	si
	2nd floor:	838	sf
Total Living:		1,527	sf
	entry:	34	sf
	garage:	252	sf
	patio:	60	sf
Total Area:		1,873	sf
	opt. lanai:	60	sf


Floor Plan


SCALE: 1/4" = 1'-0"

DESIGNED BY: MJS


FLOOR PLANS

PROJECT: 00-0000
SCALE: AS NOTE
DRAWN BY: C.C.

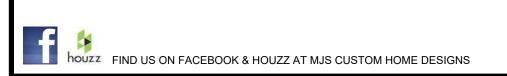

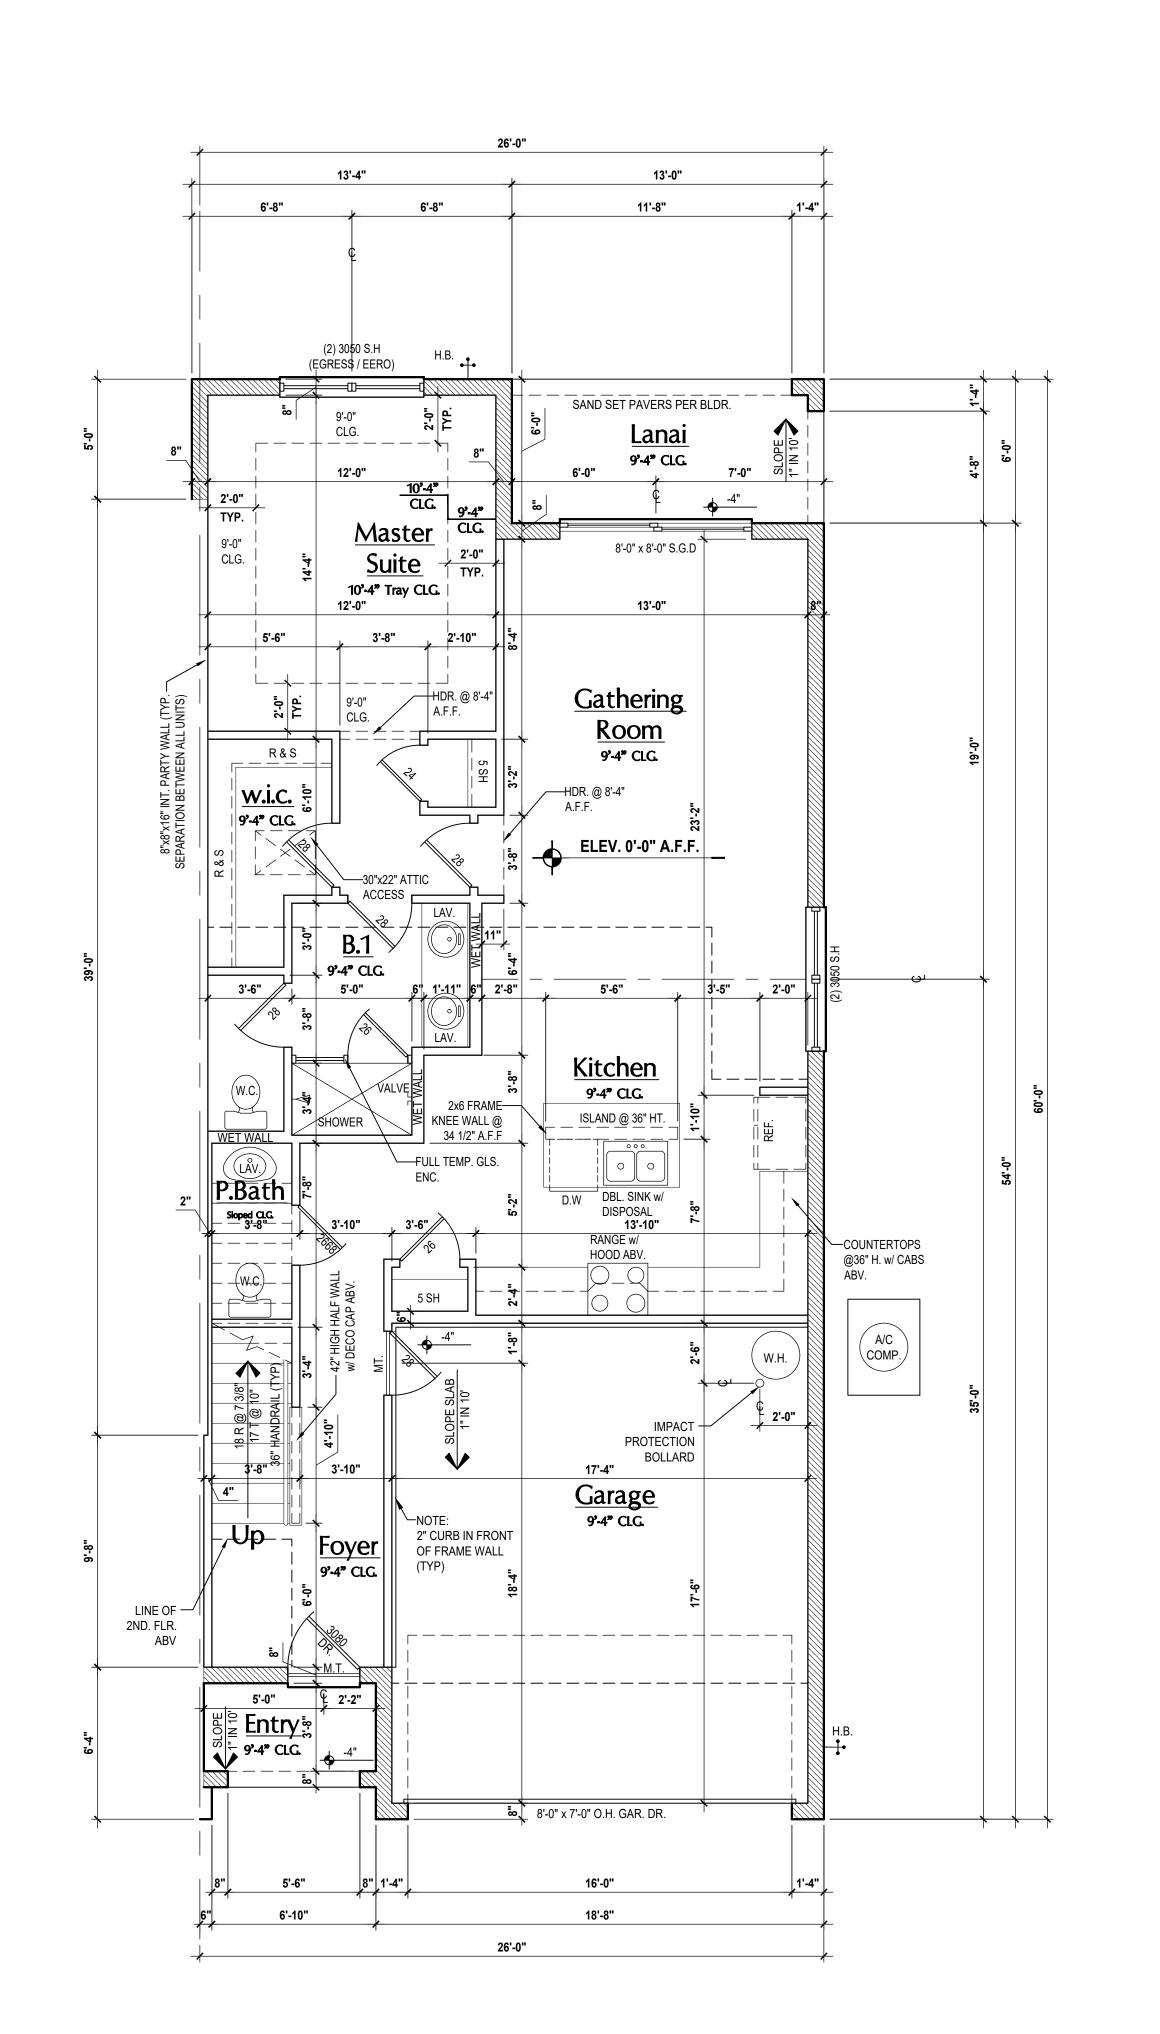


Truman-Rev. First Floor Plan (Standard)
SCALE: 1/4" = 1'-0"

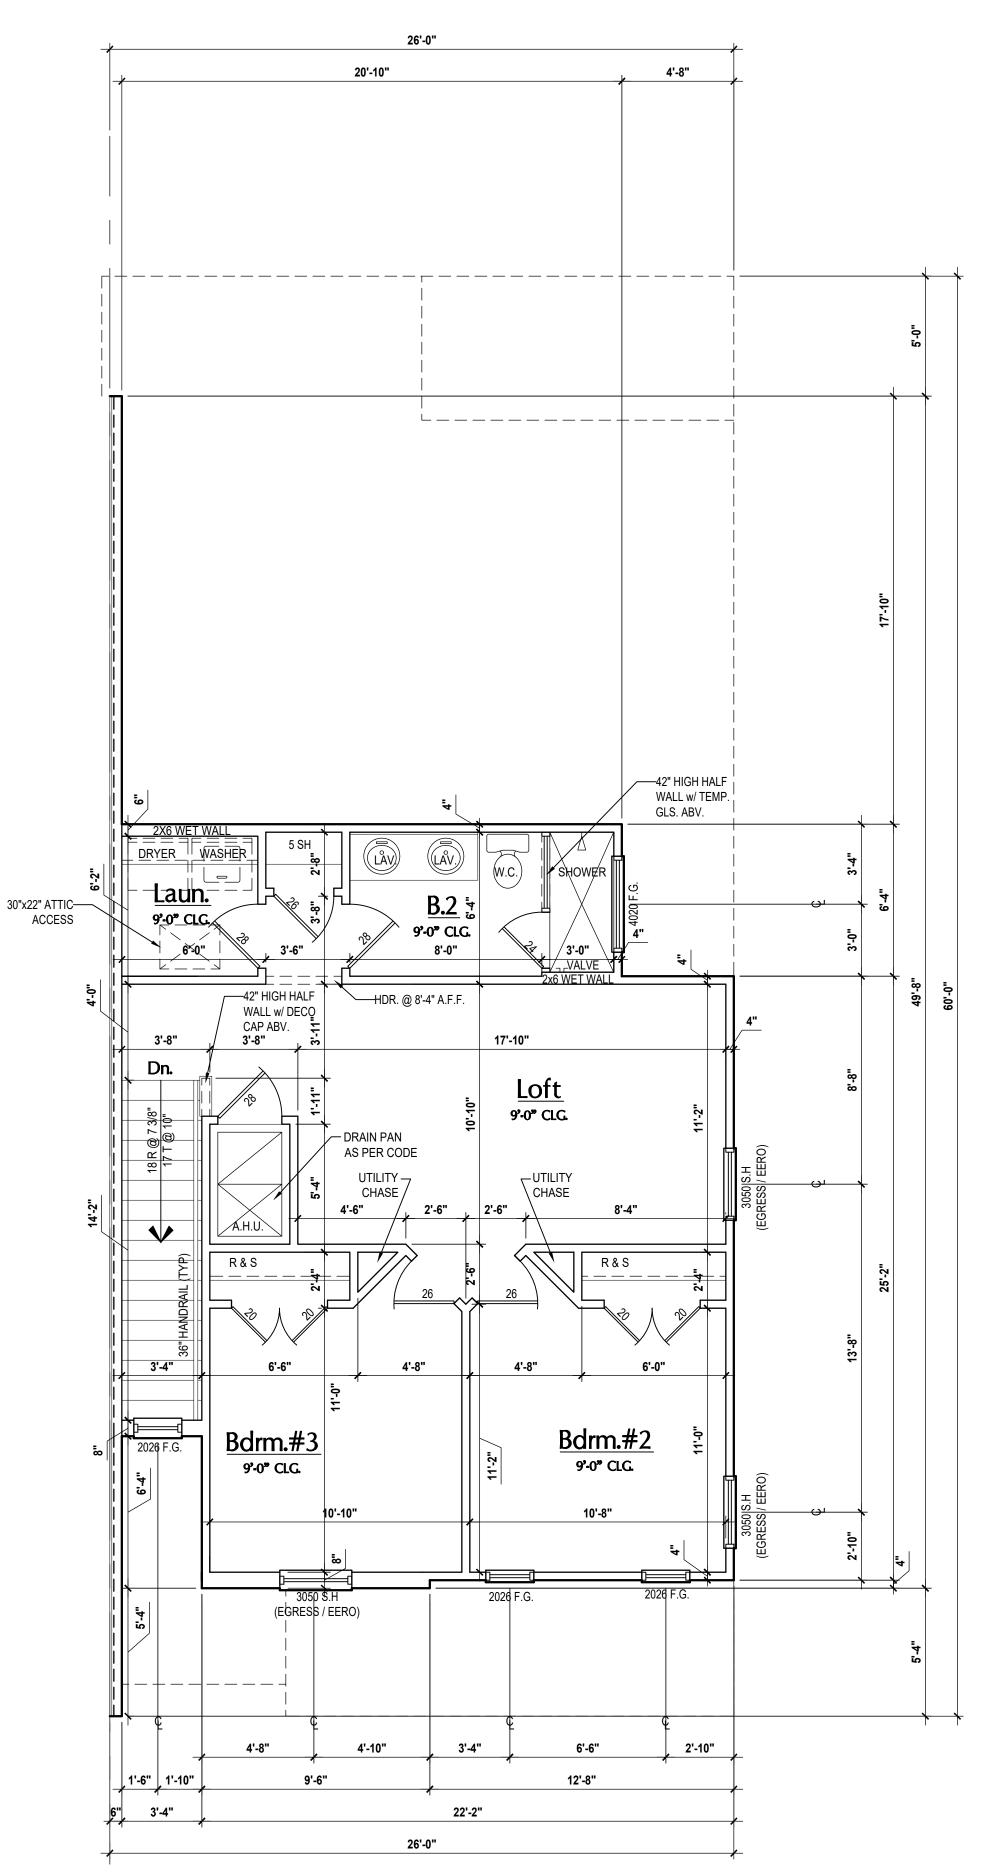

Truman-Rev. Second Floor Plan (Elev.- B)


SCALE: 1/4" = 1'-0"

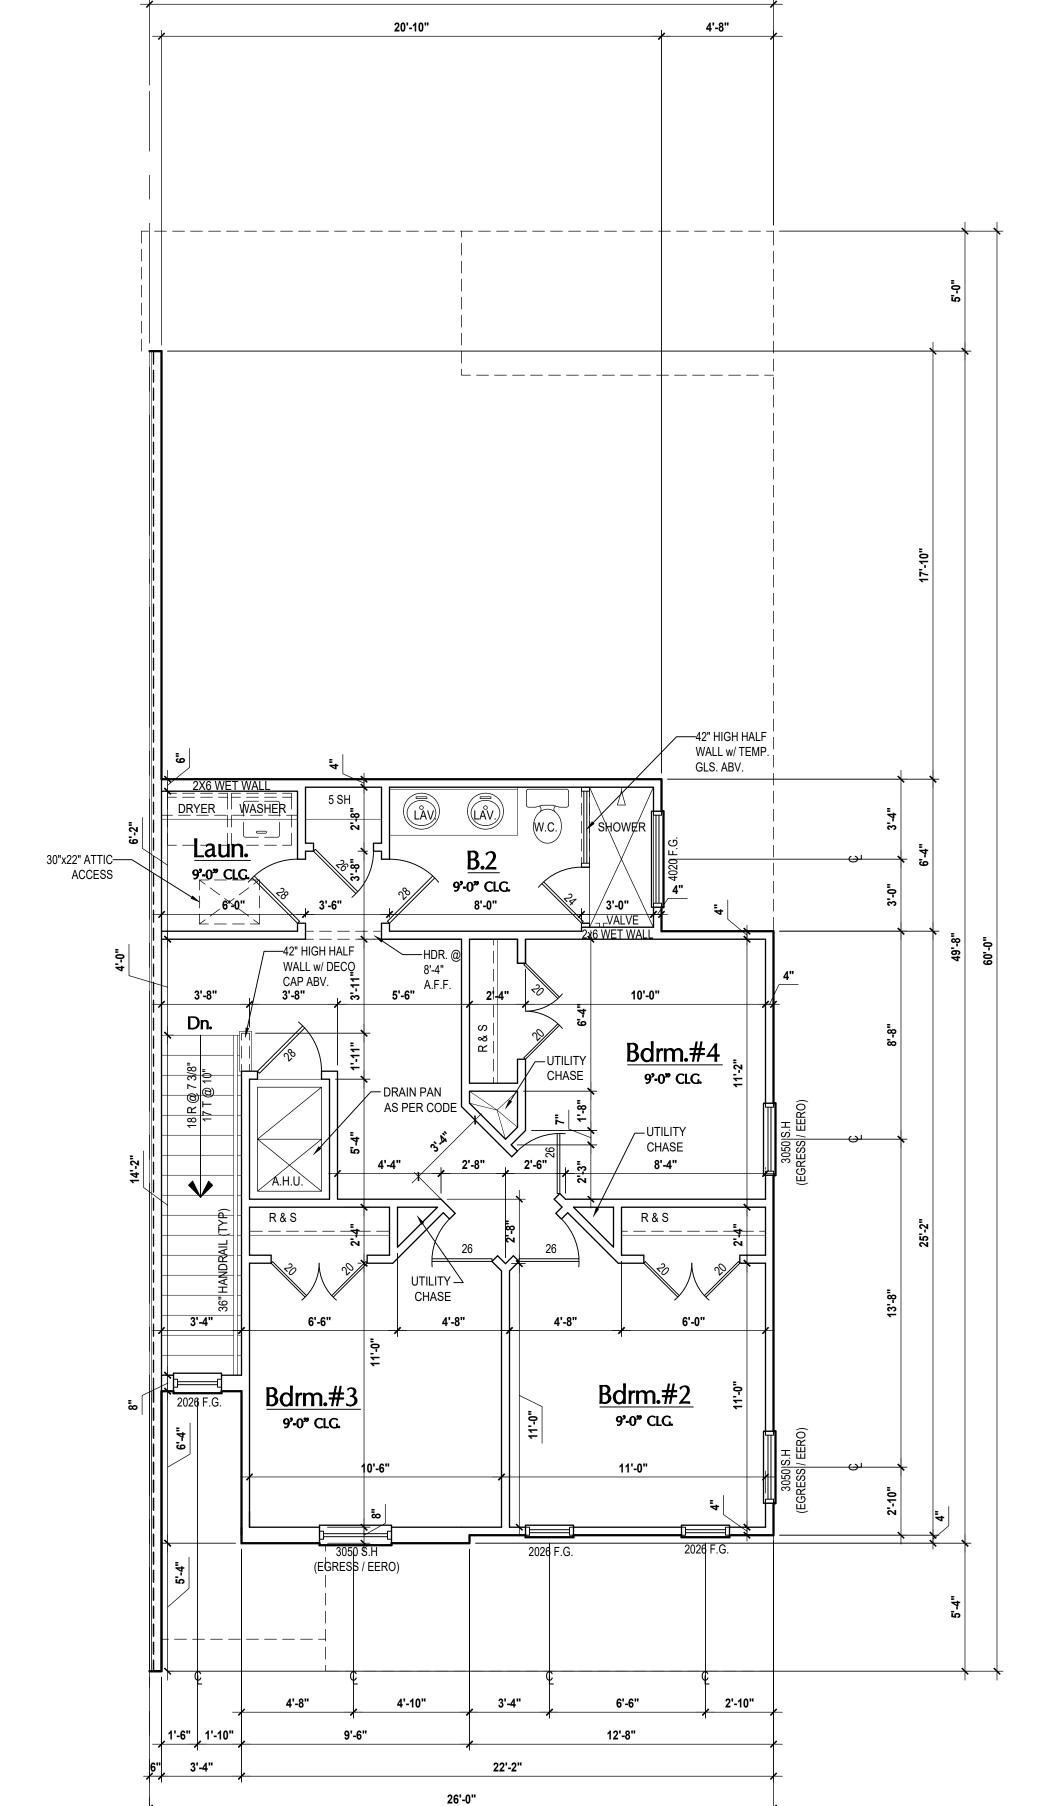

Truman-Rev. Second Floor Plan

(Opt. Bdrm.#4)

SCALE: 1/4" = 1'-0"

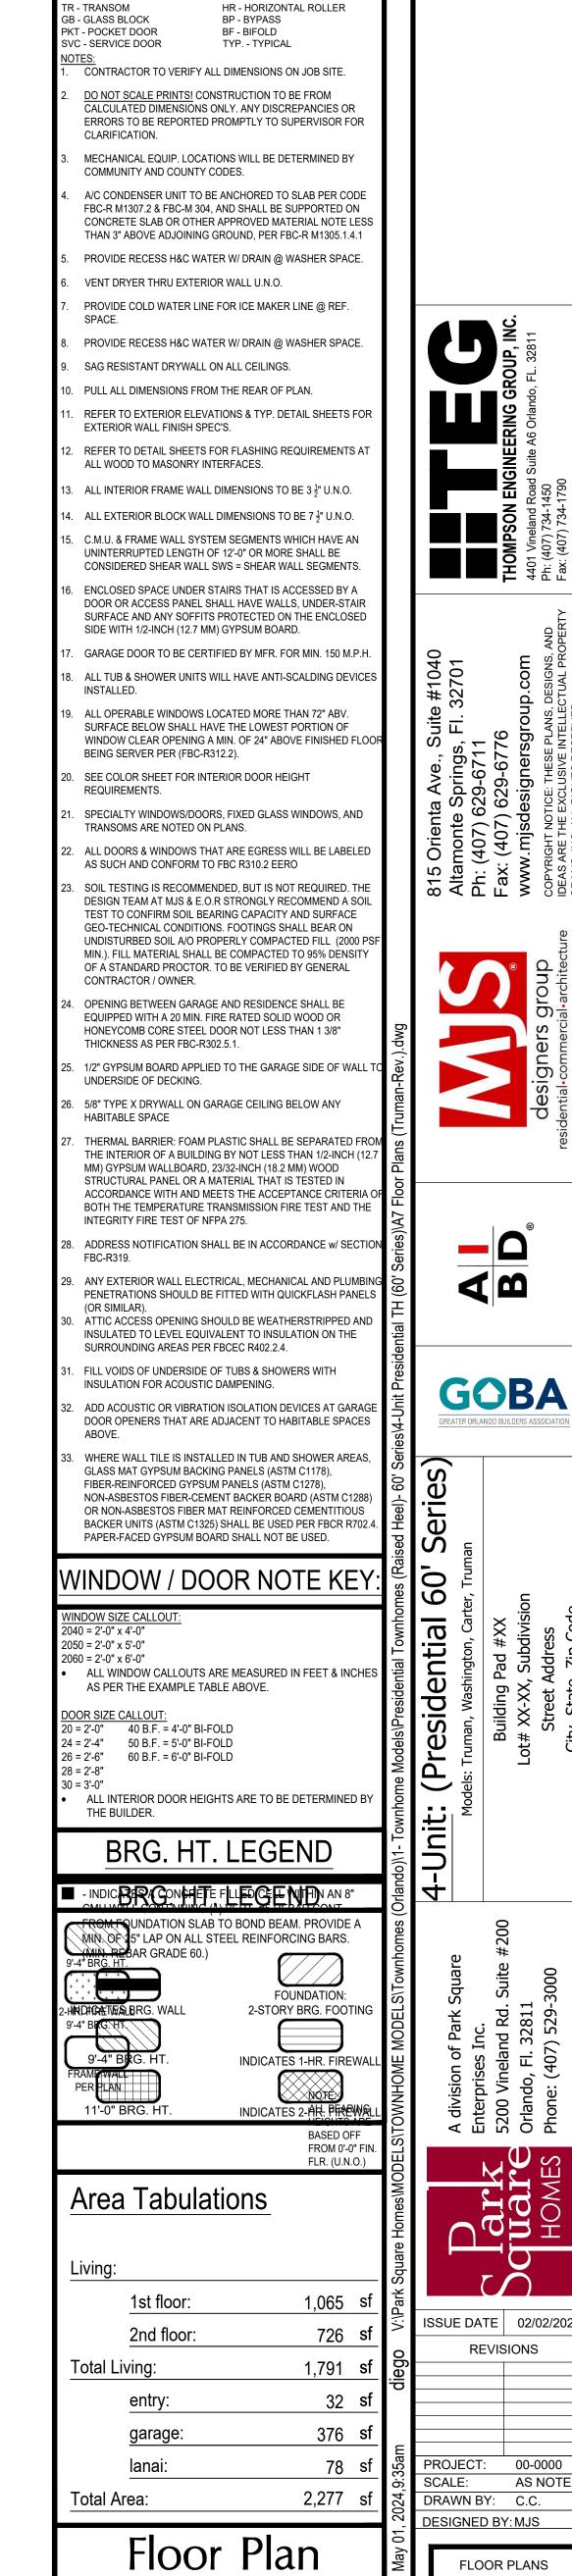

FLOOR PLANS

SCALE: 1/4" = 1'-0"

OBS - OBSCURED GLASS TEMP - TEMPERED GLASS

SH - SINGLE HUNG


DH - DOUBLE HUNG

CSMT- CASEMENT

FR - FRENCH DOORS


SL - SIDE LIGHT


FG - FIXED GLASS

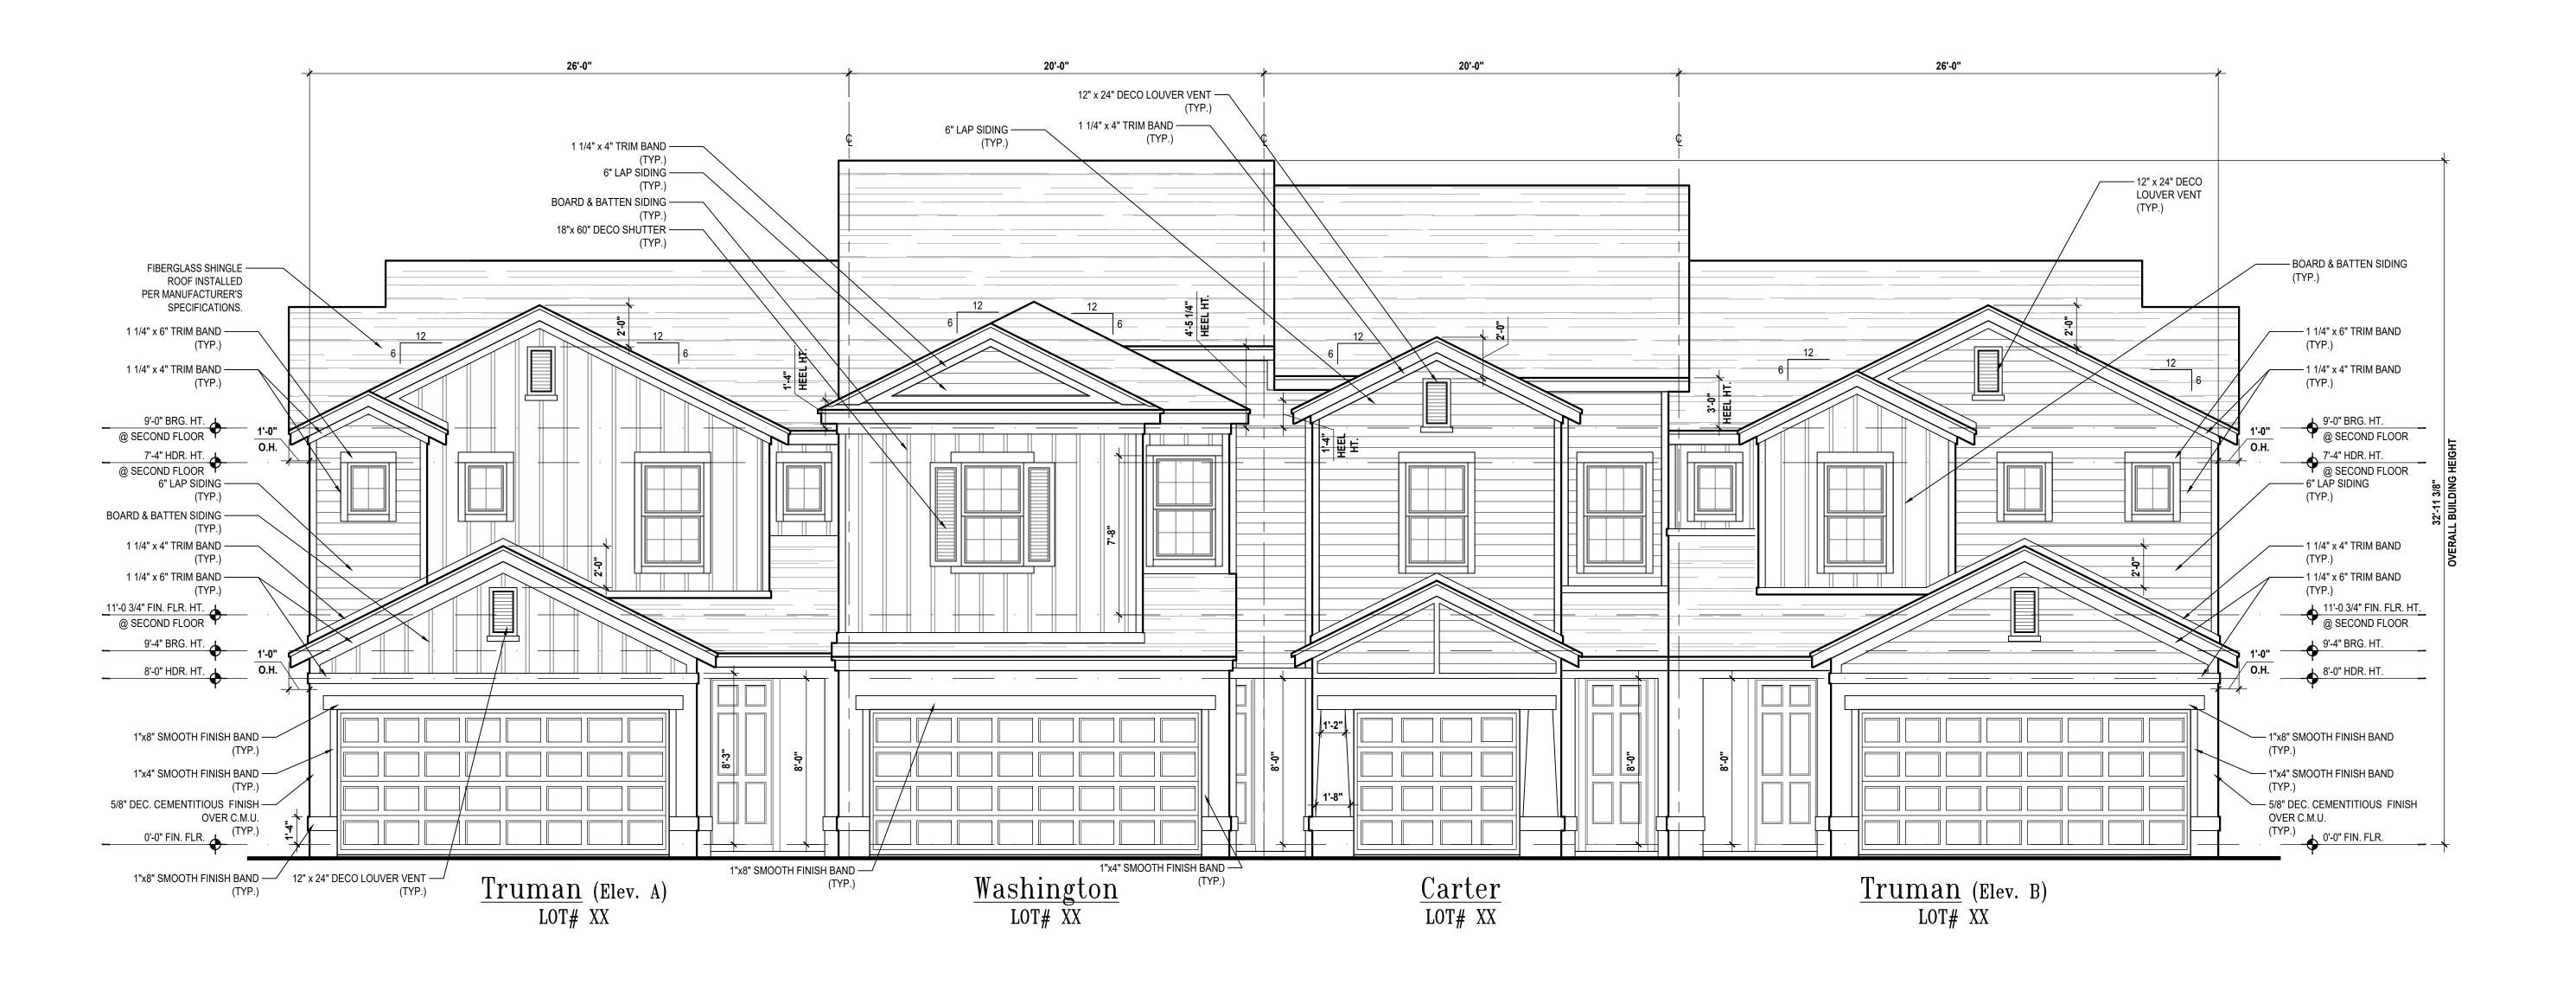

Front Elevation

(Standard) SCALE: 1/4" = 1'-0"

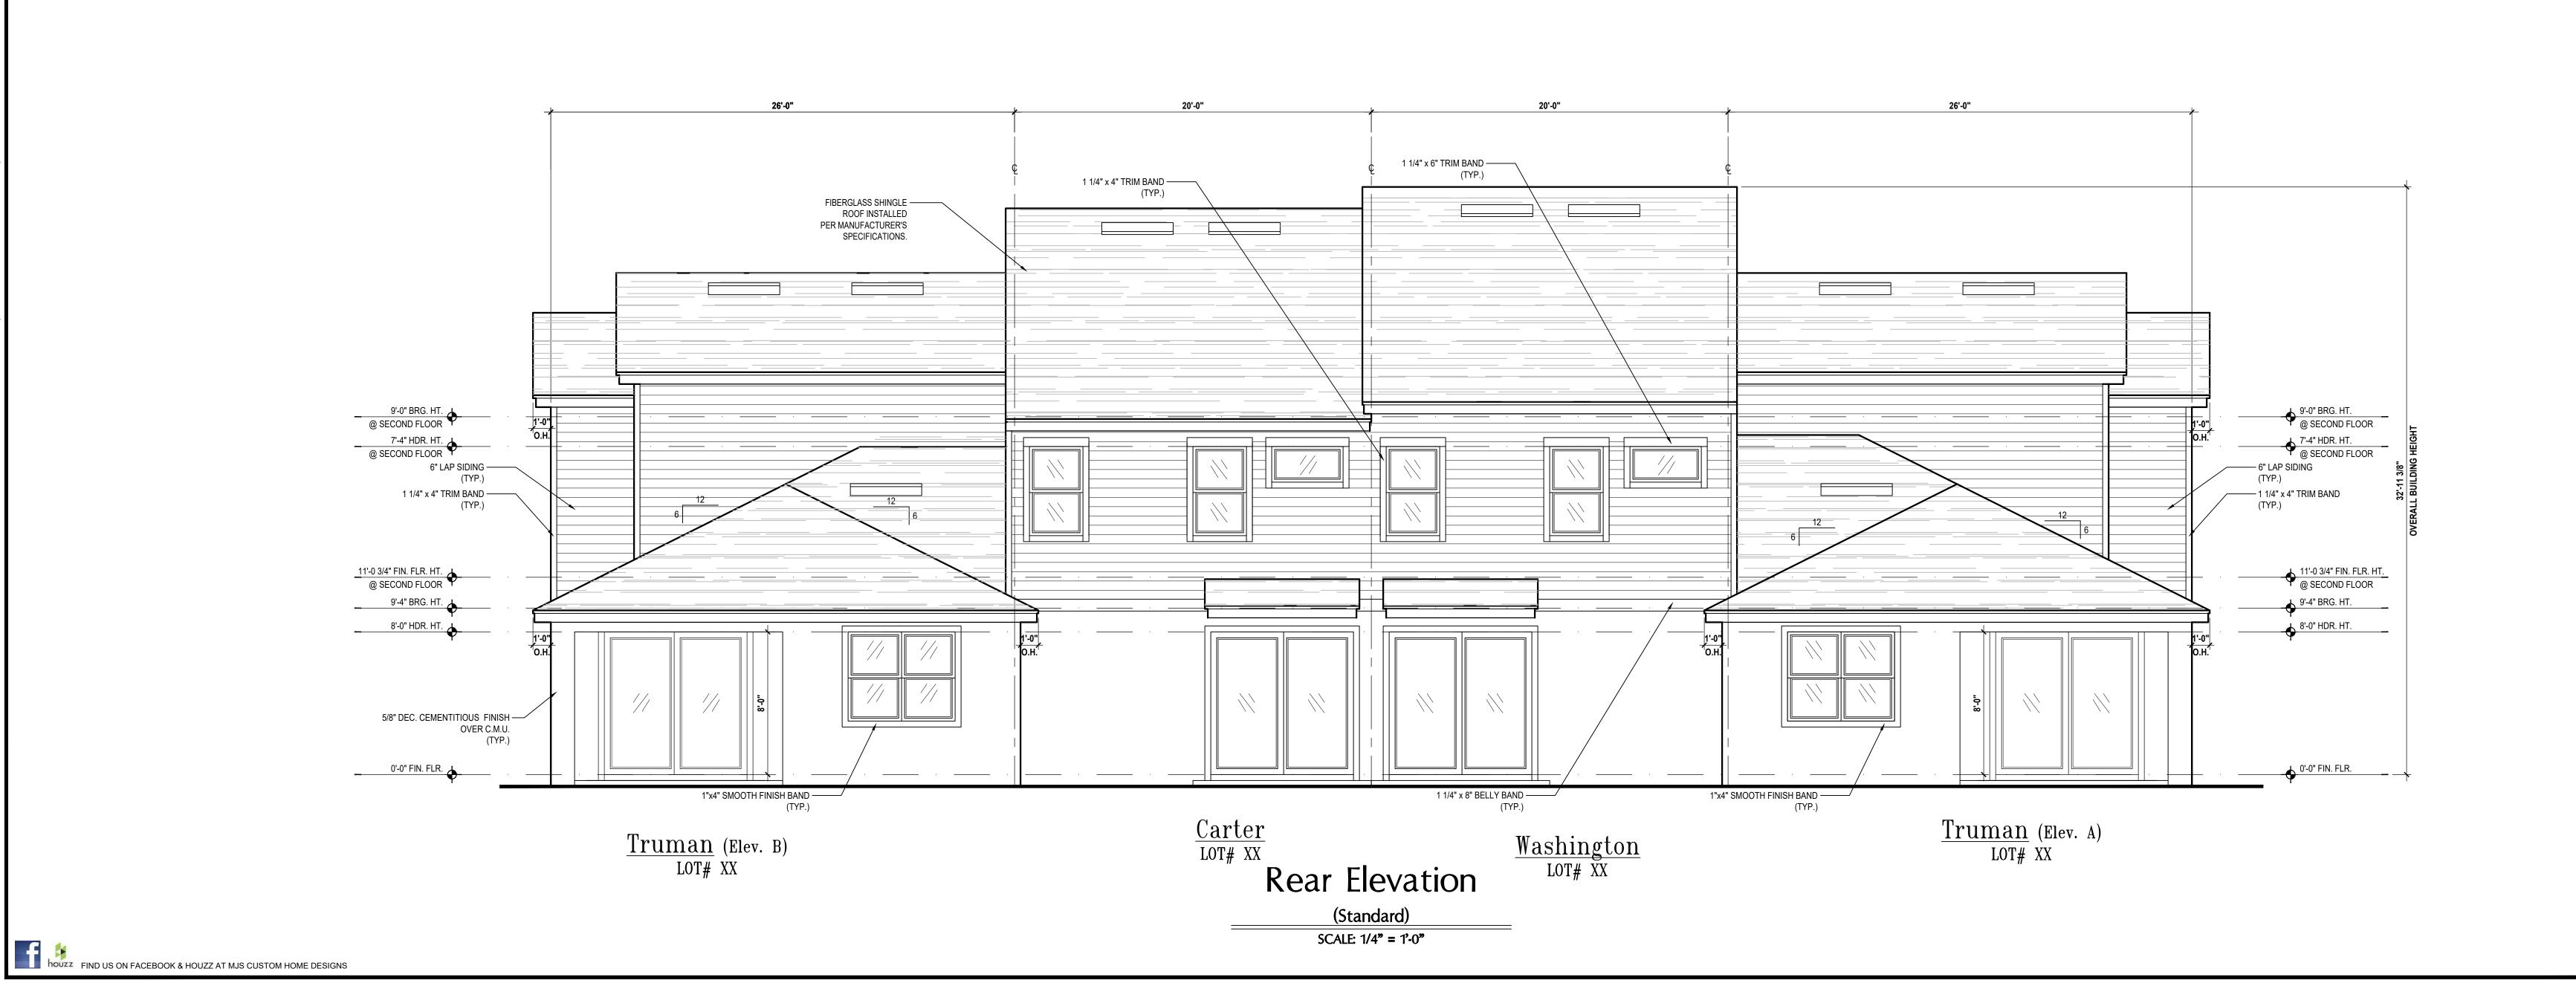

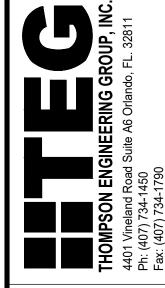








REVISIONS

AS NOTED

PROJECT: 00-0000
SCALE: AS NOTE
DRAWN BY: C.C. DESIGNED BY: MJS

ELEVATIONS

Left Elevation (Standard) SCALE: 1/4" = 1'-0"

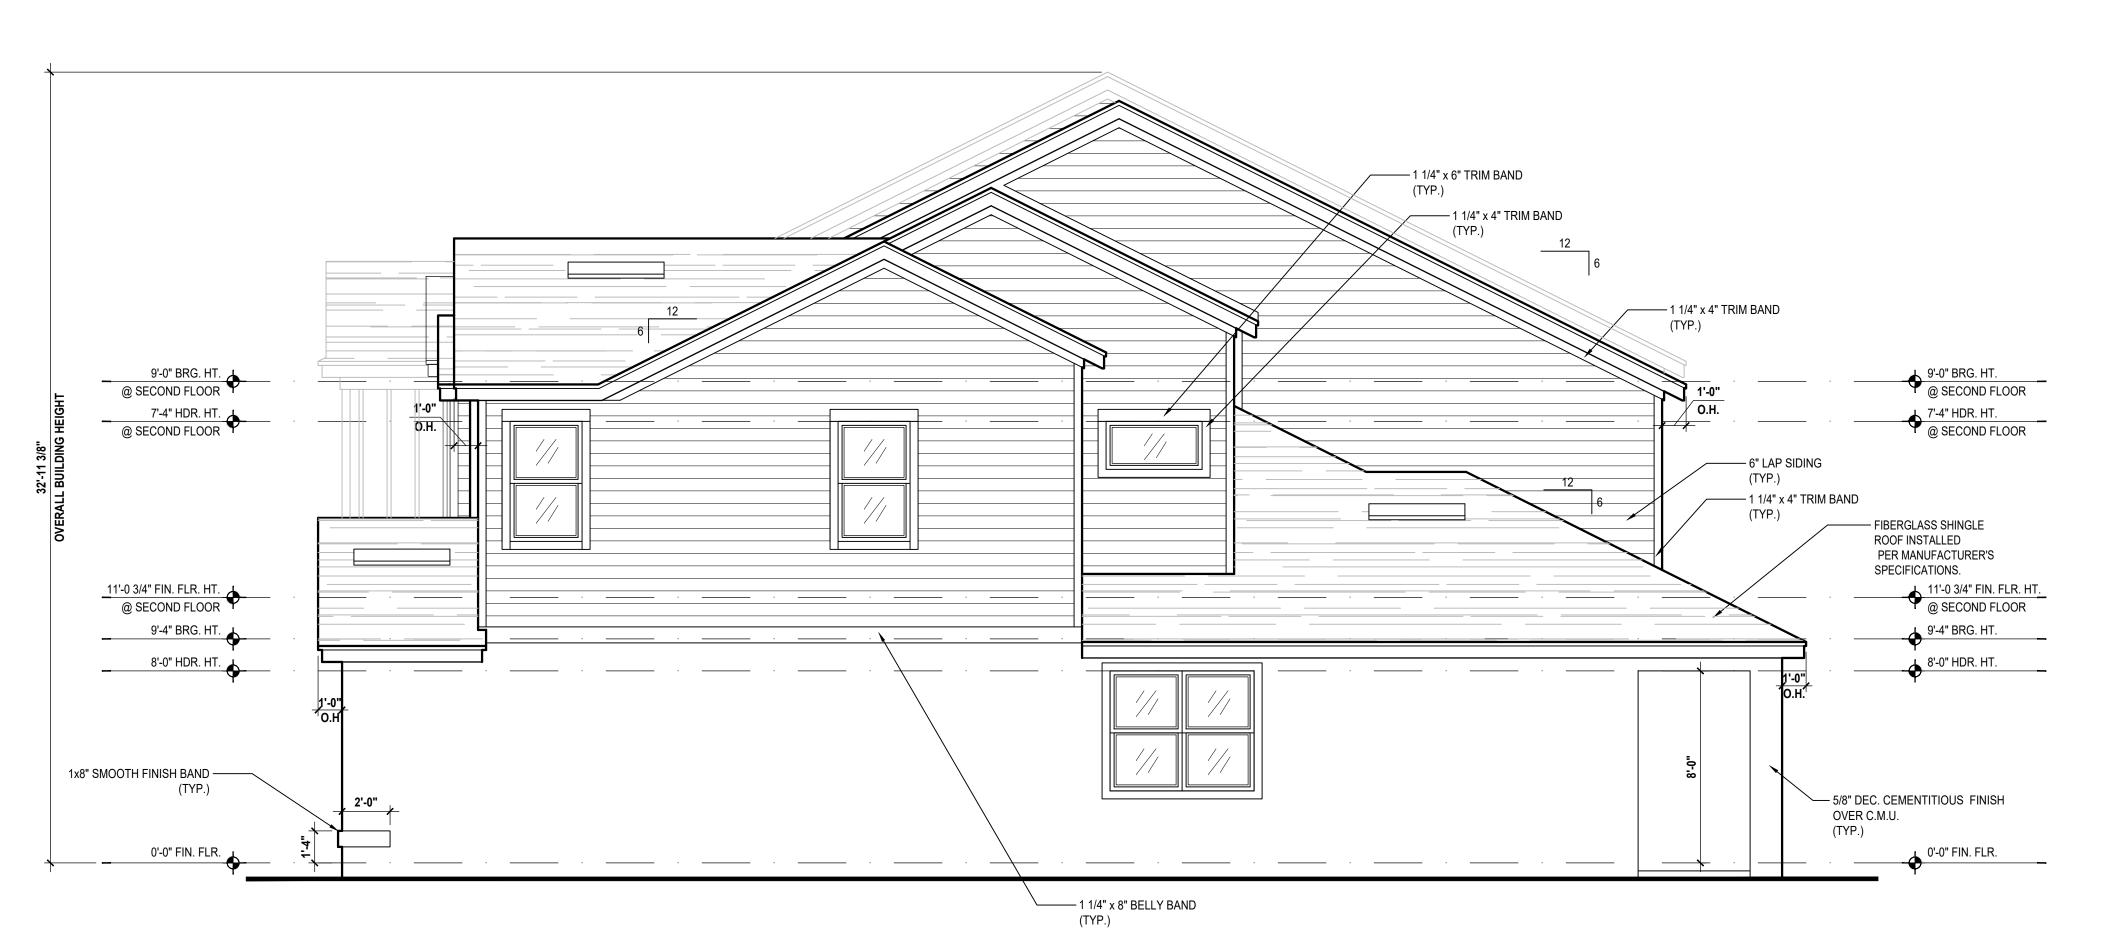

Right Elevation

(Standard)


SCALE: 1/4" = 1'-0"





PROJECT: 00-0000
SCALE: AS NOTED
DRAWN BY: C.C. DESIGNED BY: MJS

ELEVATIONS

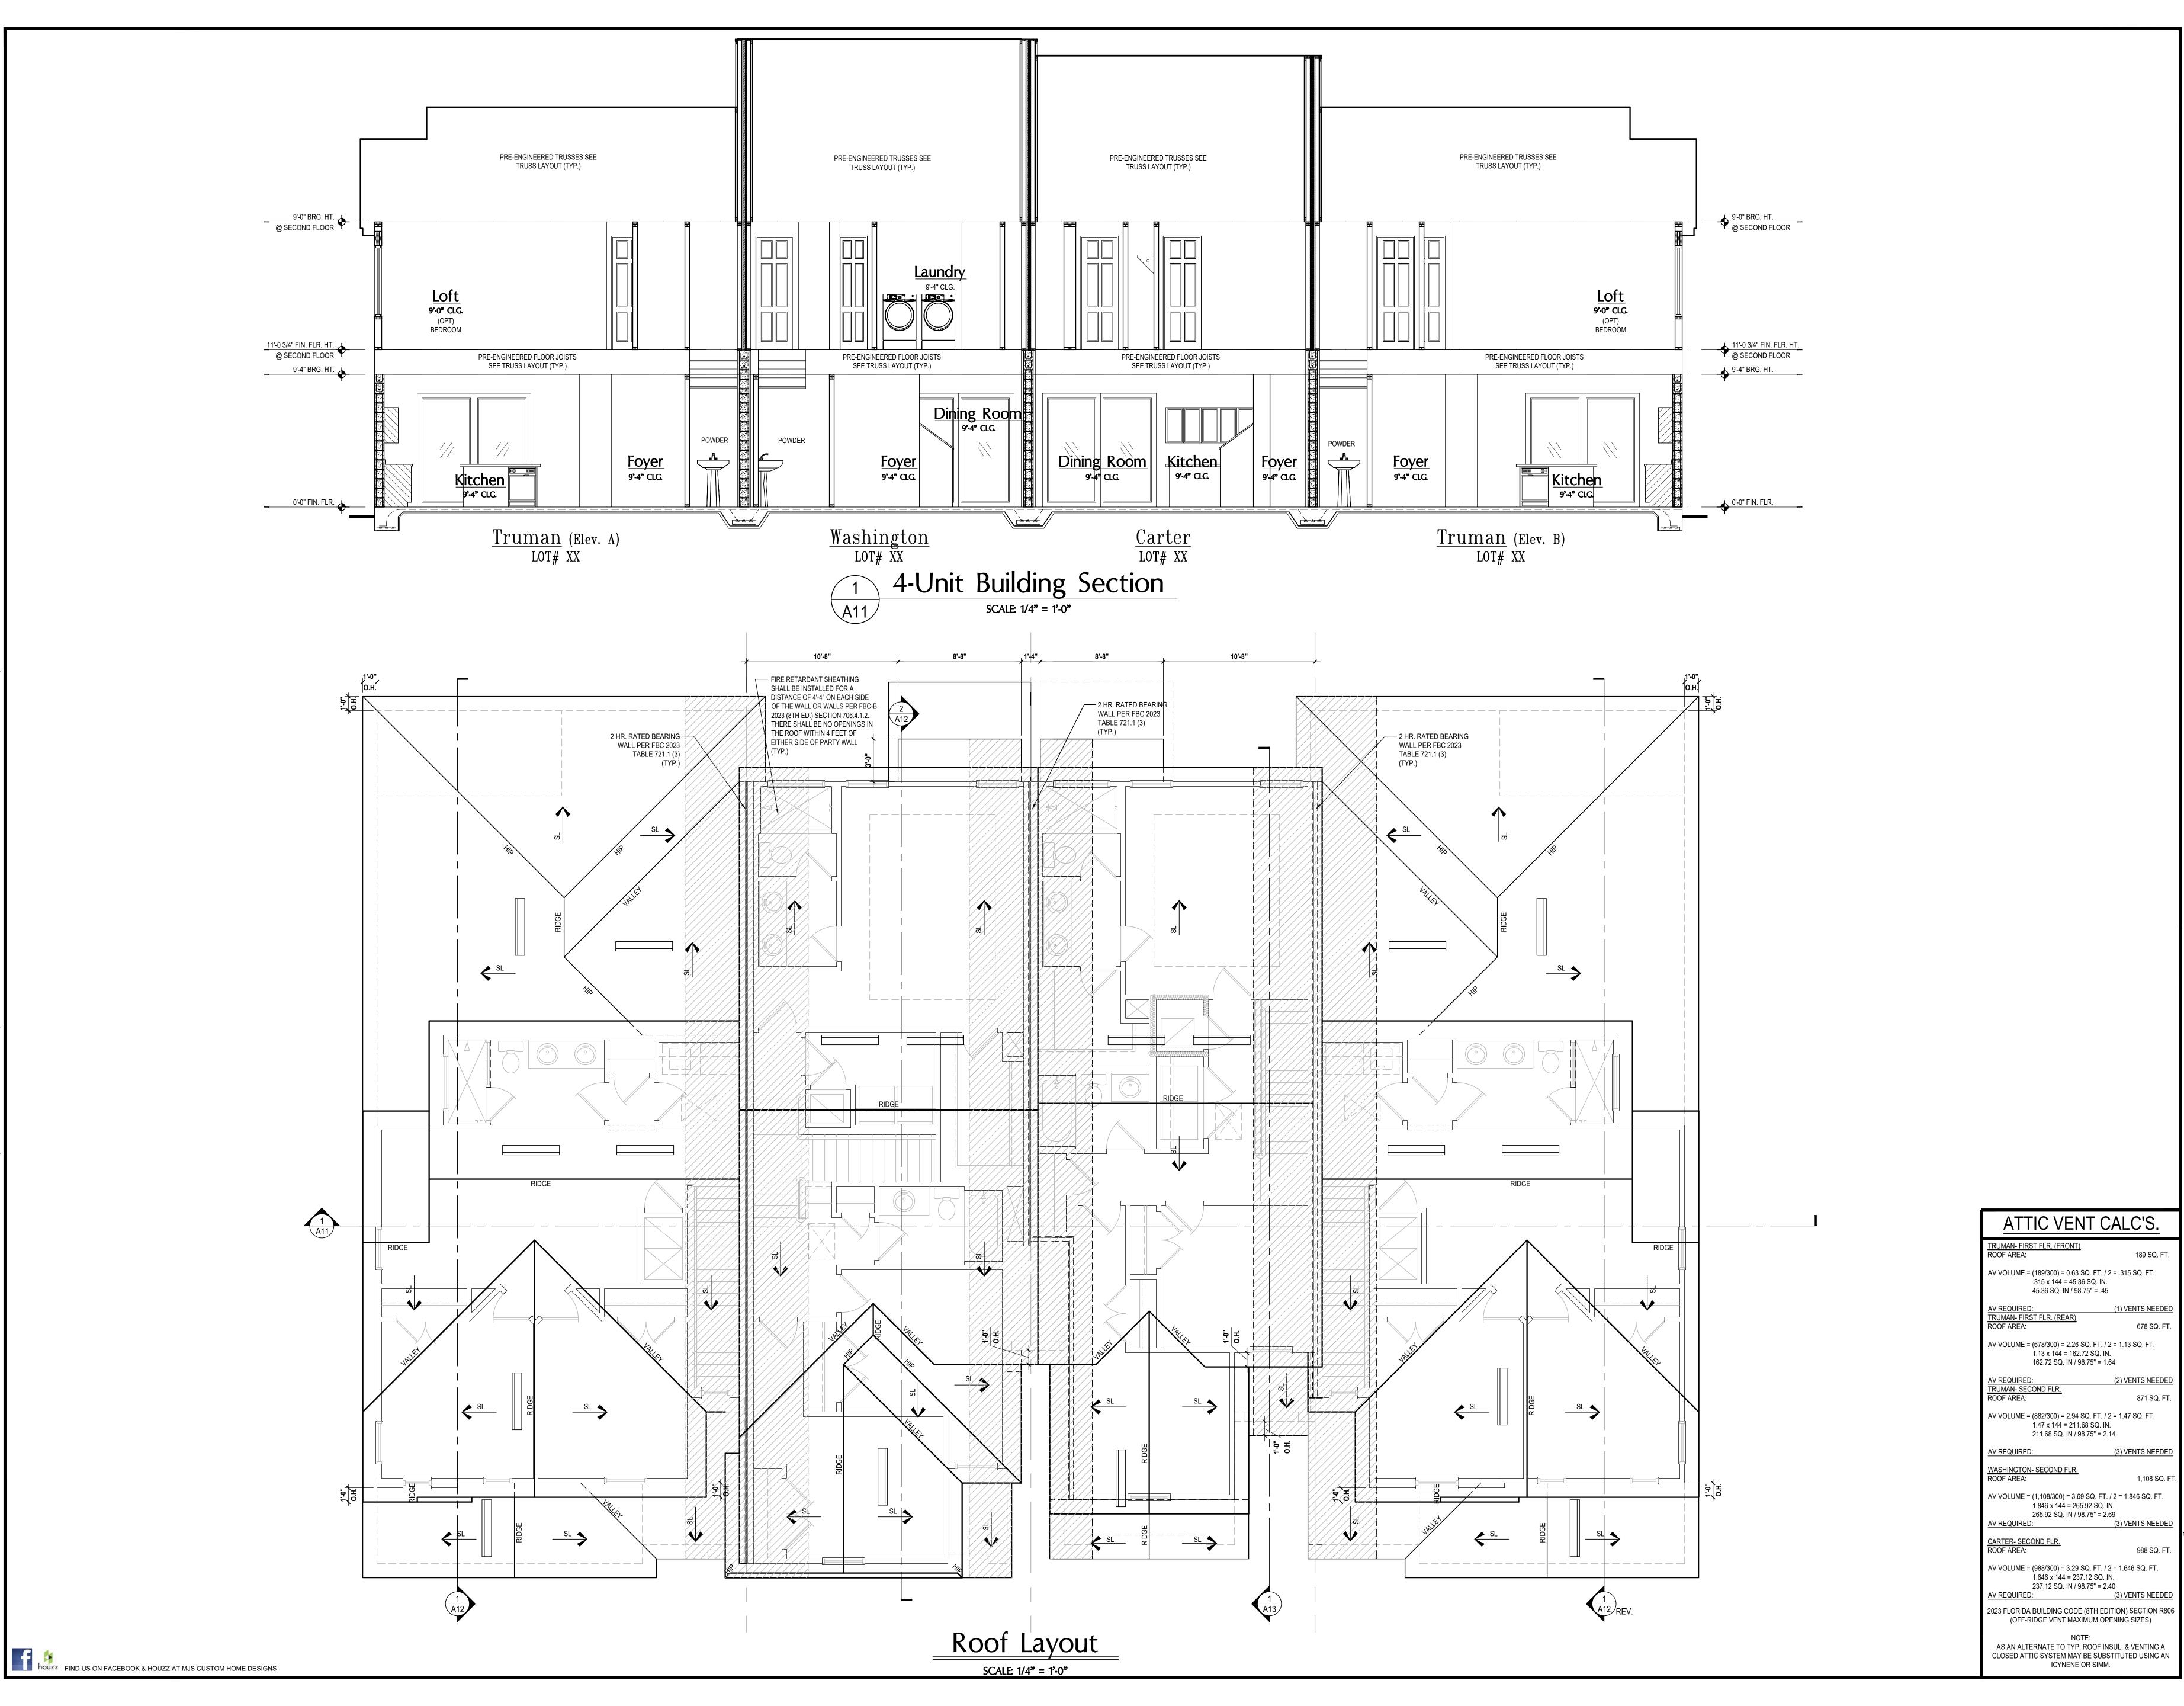








GOBA



ISSUE DATE | 02/02/2024 REVISIONS

PROJECT: 00-0000 SCALE: DRAWN BY: C.C. DESIGNED BY: MJS

AS NOTED SECTIONS A10

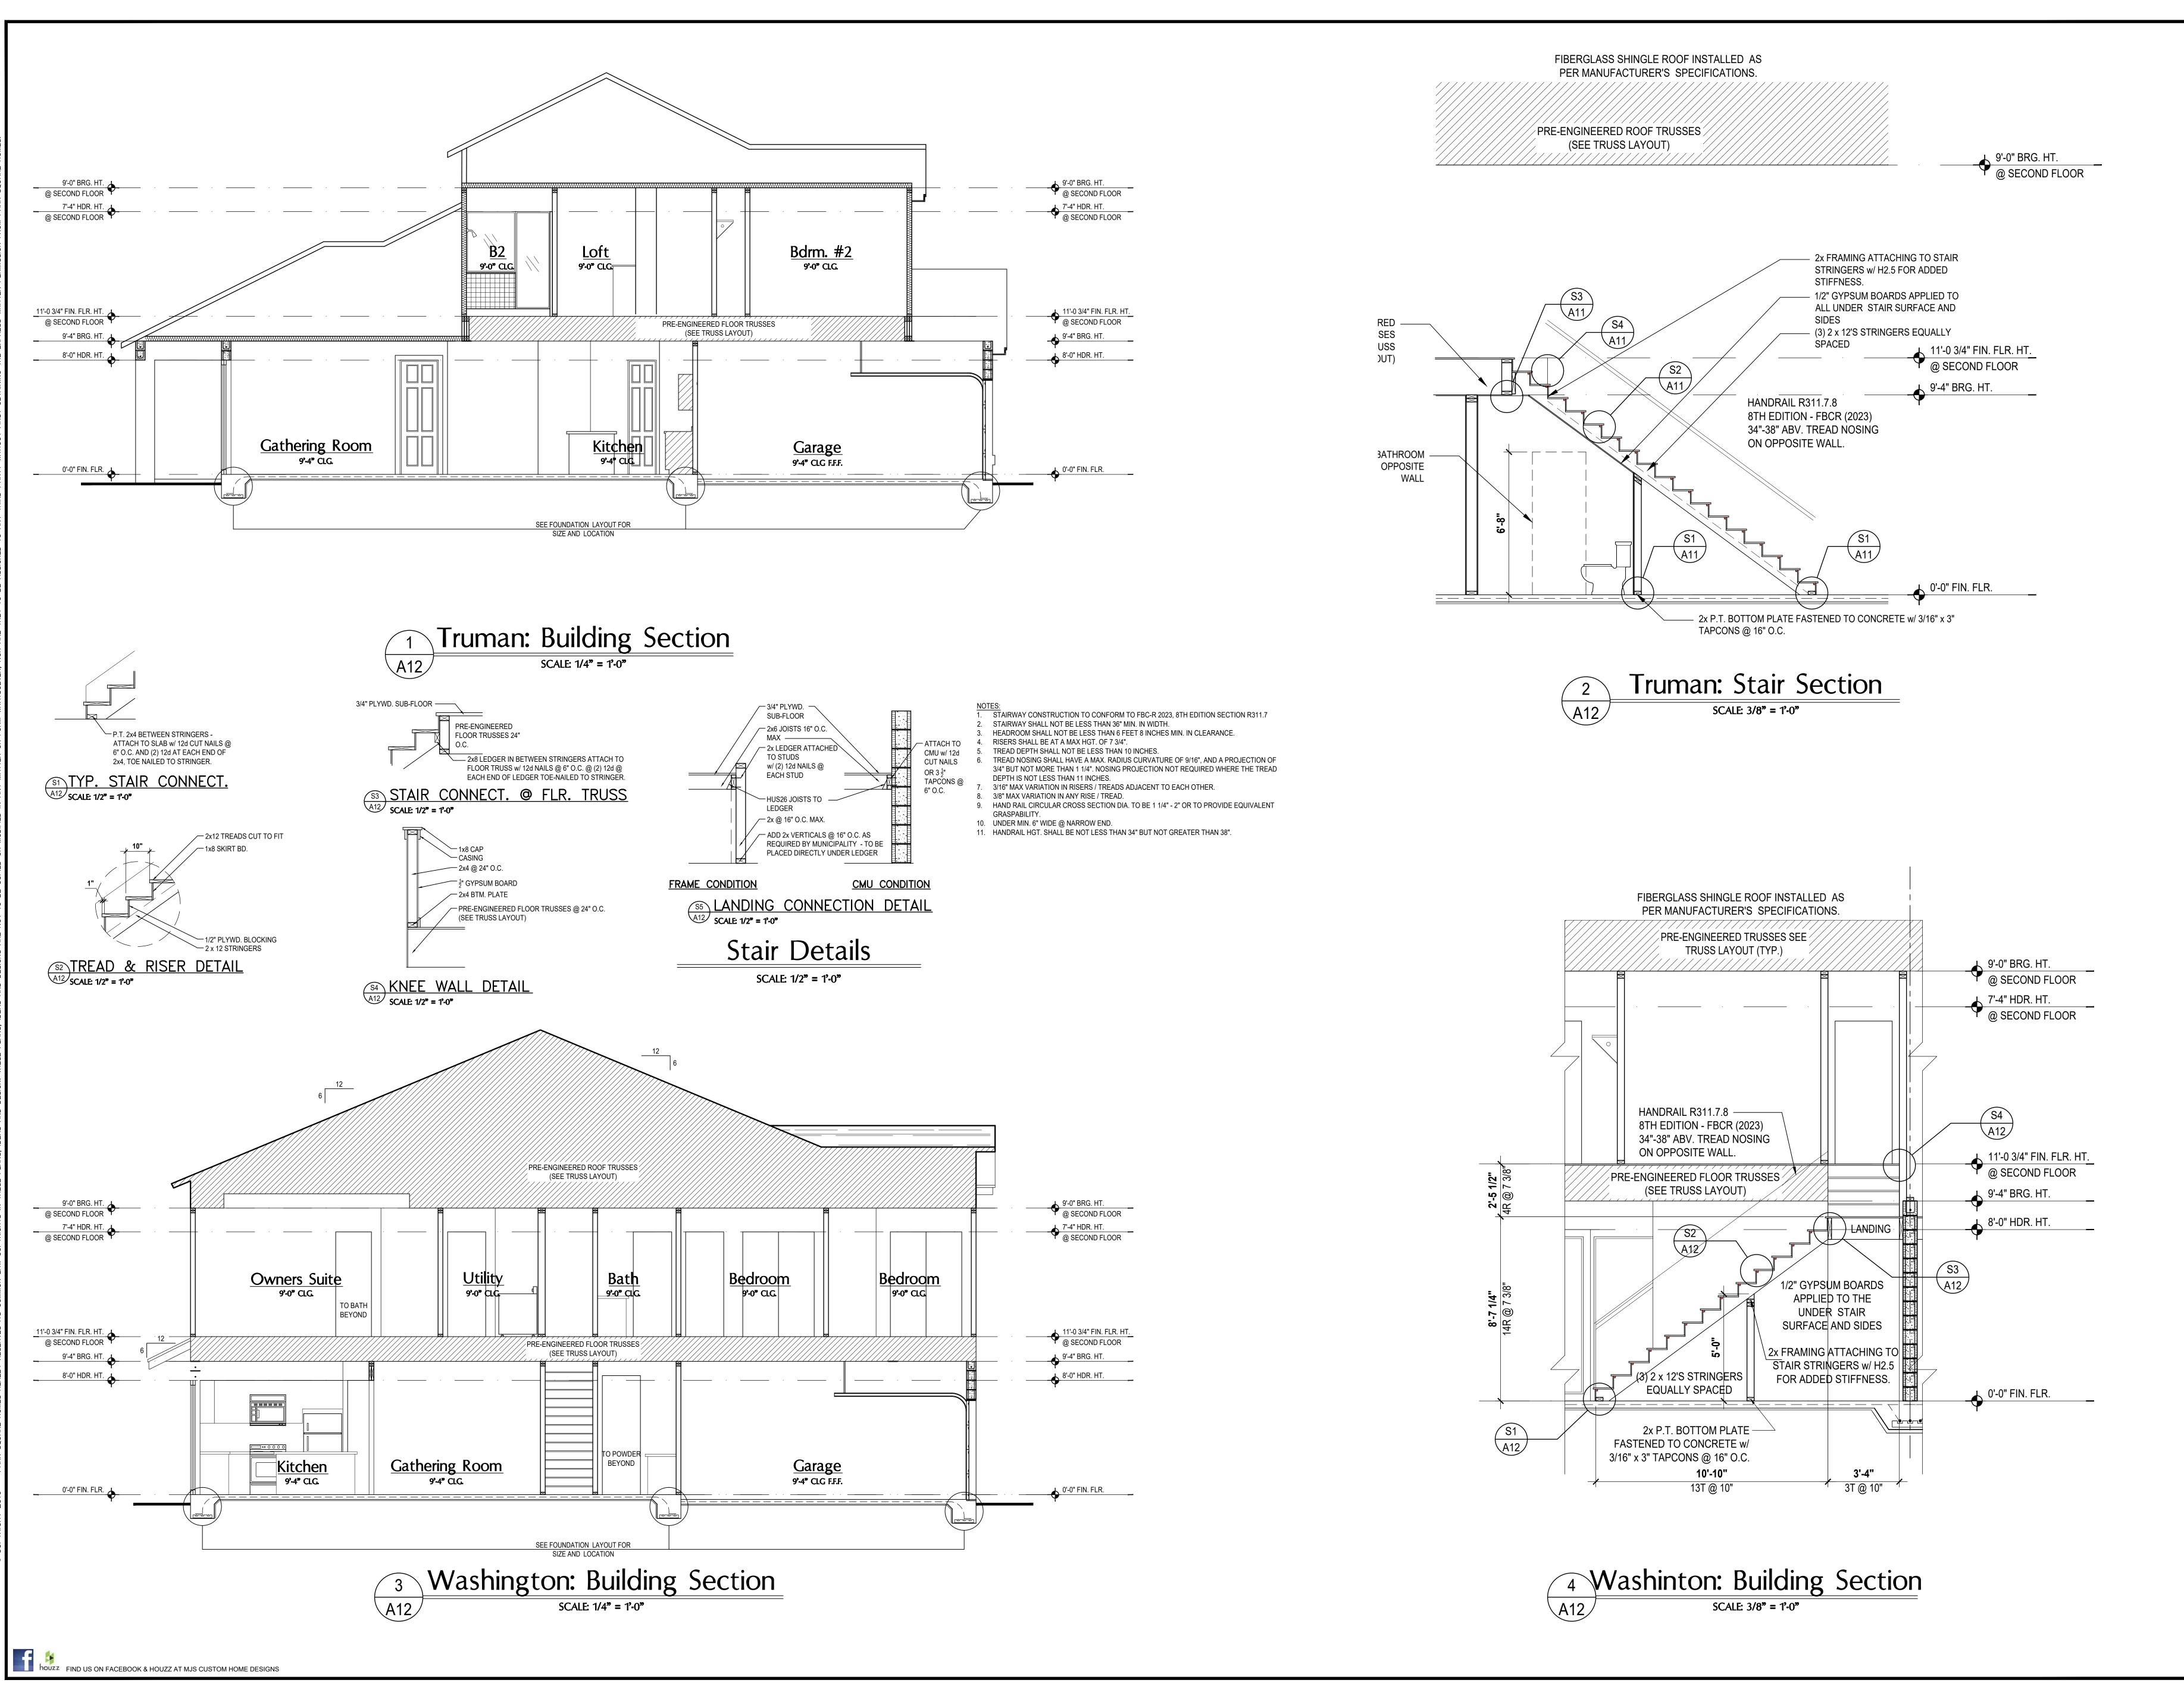


A B **GOBA**

SSUE DATE | 02/02/2024

AS NOTED DRAWN BY: C.C. DESIGNED BY: MJS

SECTIONS A11 Carter: Building Section

SCALE: 1/4" = 1'-0"

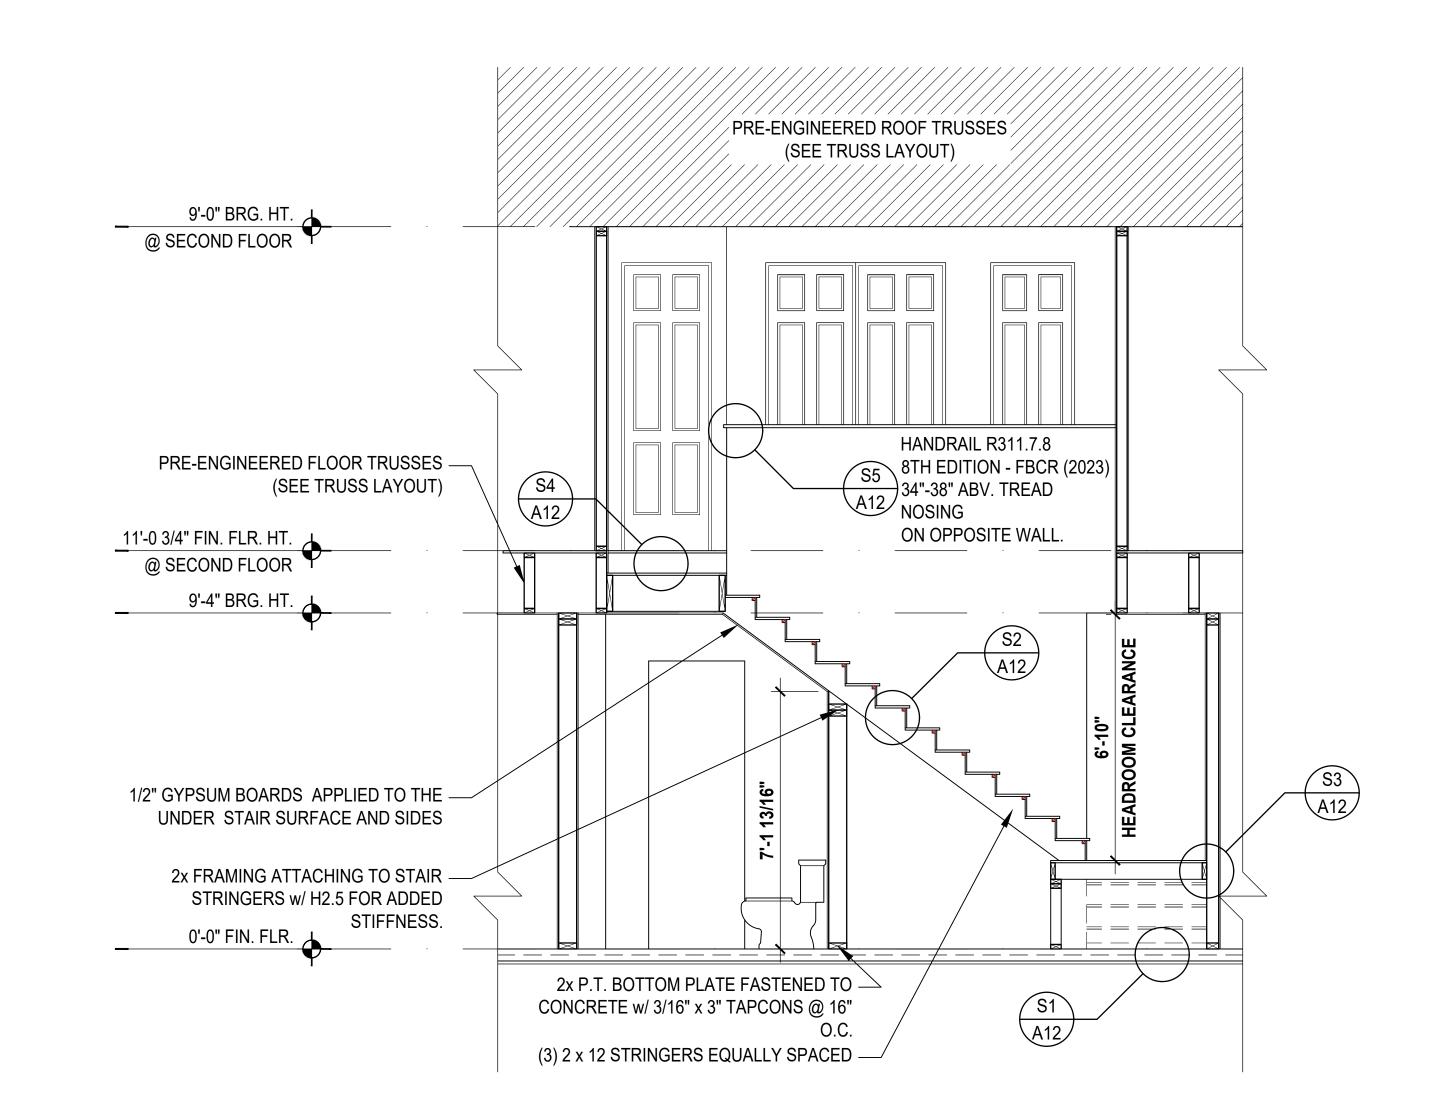


Carter: Stair Section


SCALE: 3/8" = 1'-0"




SECTIONS

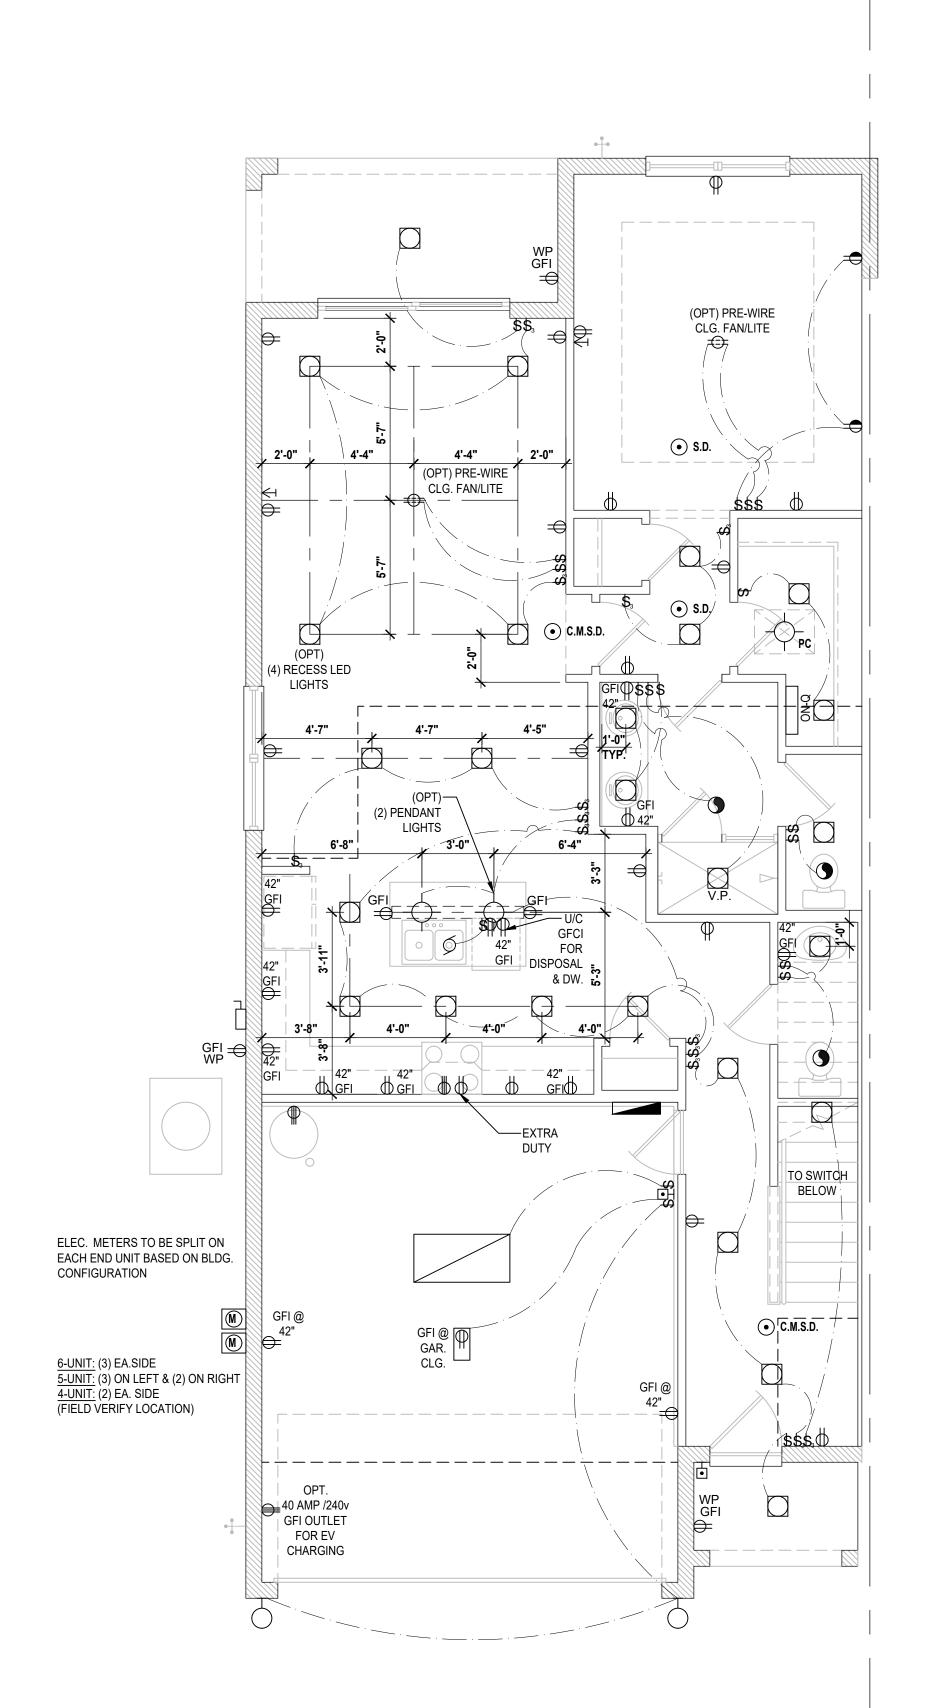

Truman- First Floor (Standard)
SCALE: 1/4" = 1'-0"

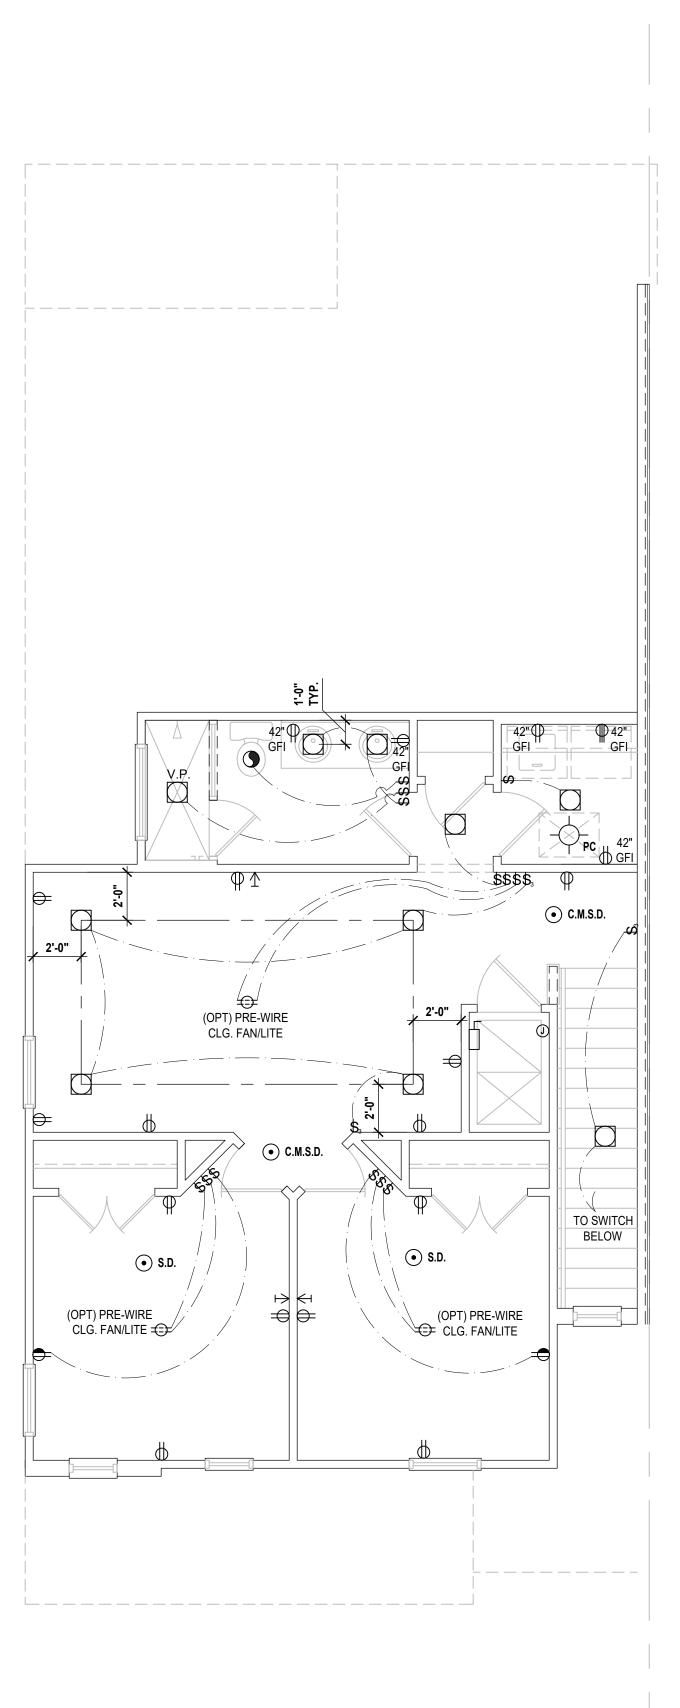

Truman- Second Floor (Elev.- A)
SCALE: 1/4" = 1'-0"

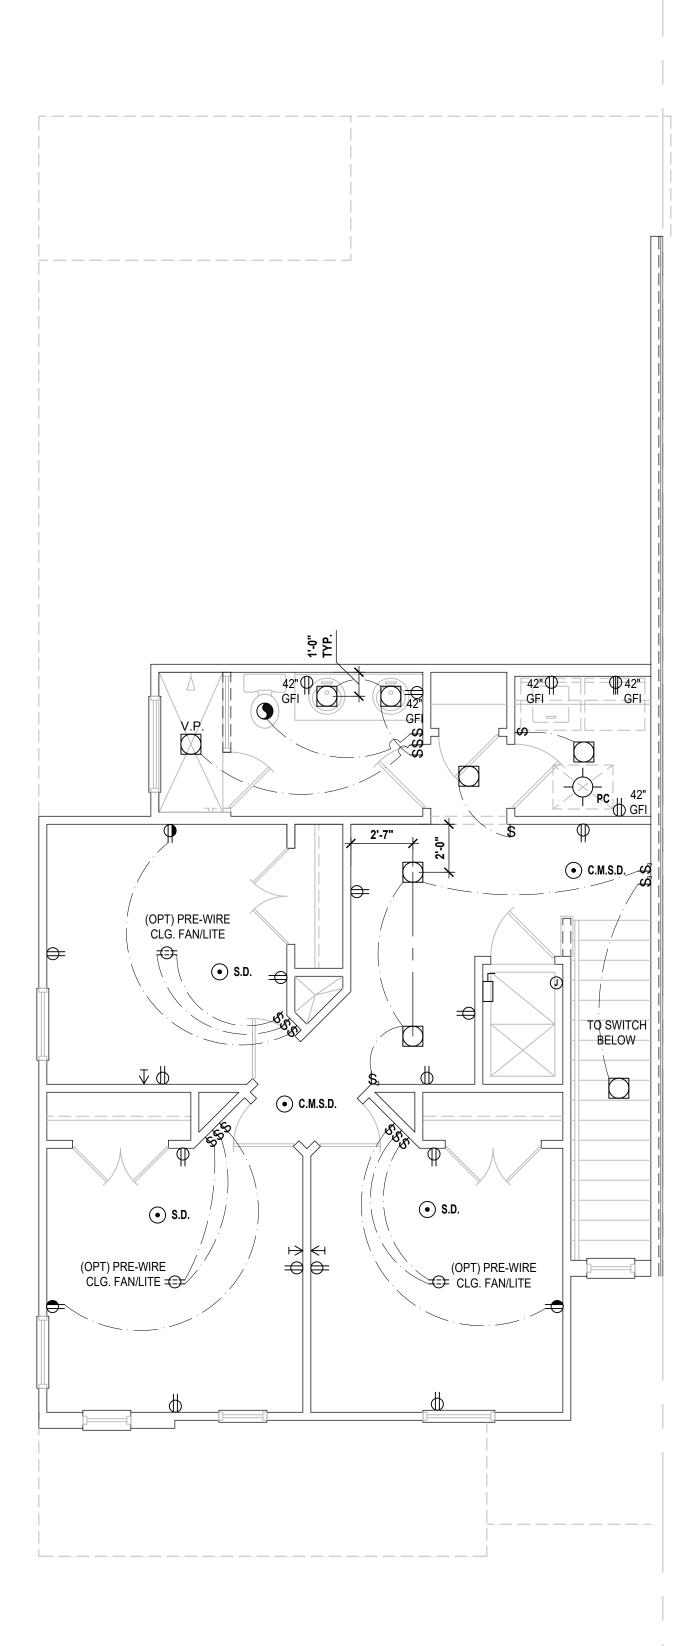

Truman- Second Floor (<u>Opt - 4 Bedroom</u>) SCALE: 1/4" = 1'-0"

GENERAL NOTES KEY

- . BUILDER TO VERIFY EXACT LOCATION OF FLOOR OUTLETS IN FIELD.
- . ALL OUTLETS ARE TO BE AFCI PROTECTED.
 - ALL 15A AND 20A 120V BRANCH CIRCUITS WILL BE AFCI
 - PROTECTED.
- ALL 15A AND 20A 120V BRANCH CIRCUITS LOCATED IN THE GARAGE AND LAUNDRY WILL BE GFCI PROTECTED.
- ALL GARAGE BAYS WILL HAVE DEDICATED GFCI OUTLET. ALL OUTLETS LOCATED IN THE KITCHEN AND
- BATHROOMS ARE TO BE GFCI PROTECTED.
- . DW. AND GARBAGE DISPOSAL ARE TO BE GFCI PROTECTED.
- 8. EXCEPTIONS TO THE GFCI STIPULATION WILL BE ALLOWED ONLY IF ALLOWED PER CURRENT NFPA / NEC.
- OUTLETS LOCATED IN THE LAUNDRY ARE TO BE GFCI AND AFCI PROTECTED.

0. OUTLETS LOCATED WITHIN 6'-0" OF A WET AREA ARE TO

- BE GFCI PROTECTED.
- 11. ALL OUTLETS OVER COUNTERTOPS TO BE 42" A.F.F.
- 2. ALL SMOKE/CARBON MONOXIDE DETECTORS ARE TO BE
- 13. 8'-0" HEIGHT VANITY LIGHTS IN MASTER BATHROOM AND 7'-0" IN ALL OTHER BATHROOMS.

HARD WIRED, INTERCONNECTED AND AFCI PROTECTED.

- 14. ANY EXTERIOR WALL ELECTRICAL, MECHANICAL AND
- PLUMBING PENETRATIONS SHOULD BE FITTED WITH QUICKFLASH PANELS (OR SIMILAR).
- 5. RECESSED LUMINAIRES INSTALLED IN THE BUILDING THERMAL ENVELOPE ARE SUBJECT TO THE PROVISIONS
- OF FBCEC R402.4.5. FIXTURES SHALL BE IC-RATED (FOR ZERO CLEARANCE INSULATION CONTACT) AND SEALED AIR TIGHT. ALSO SEE FBCE 410.116.

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SMOKE DETECTOR REQUIREMENTS: ALL SMOKE/CARBON DETECTOR LOCATIONS MUST BE A MINNIMUM OF 3' FROM ANY BATHROOM PER FBC-R314.3 (4). THEY MUST ALSO BE LOCATED NO MORE THAN 10' FROM NY BEDROOM DOOR OPENING PER FBC-R315.1.

ELECTRICAL KEY:

CEILING MOUNTED LIGHT

PULL CHAIN LIGHT

FLUSH-MOUNT LED

WALL MOUNTED LIGHT

WALL WASH RECESSED DUPLEX RECEPTACLE 220 V RECEPTACLE

FLOOR RECEPTACLE

WALL SWITCH 3-WAY SWITCH

DIMMER SWITCH

FLUORESCENT LIGHT

ELECTRICAL PANEL

• S.D. | SMOKE DETECTOR

WALL SCONCE

JUNCTION BOX

A.F. ARC FAULT PROTECTION

• L.V. LOW VOLTAGE V.P. VAPOR PROOF

☐ INTERCOM

CEILING FAN

▼ TELEPHONE JACK CABLE JACK

WATER PROOF RECEPTACLE

GROUND FAULT INTERRUPT

PRE-WIRE GARAGE DOOR OPENER

Ho DOOR BELL / GARAGE DOOR SWITCH

C.M.S.D. CARBON MONOXIDE / SMOKE DETEC


FLUSH MOUNT FLUORESCENT LIGHT

FAN / LIGHT COMBINATION GARBAGE DISPOSAL MOTOR

SCALE: 1/4" = 1'-0"

DISCONNECT SWITCH ELECTRICAL METER



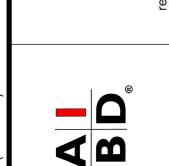






REVISIONS

PROJECT: 00-0000
SCALE: AS NOTED
DRAWN BY: C.C.
DESIGNED BY: MJS

Electrical Layout


ELECTRICAL LAYOUT

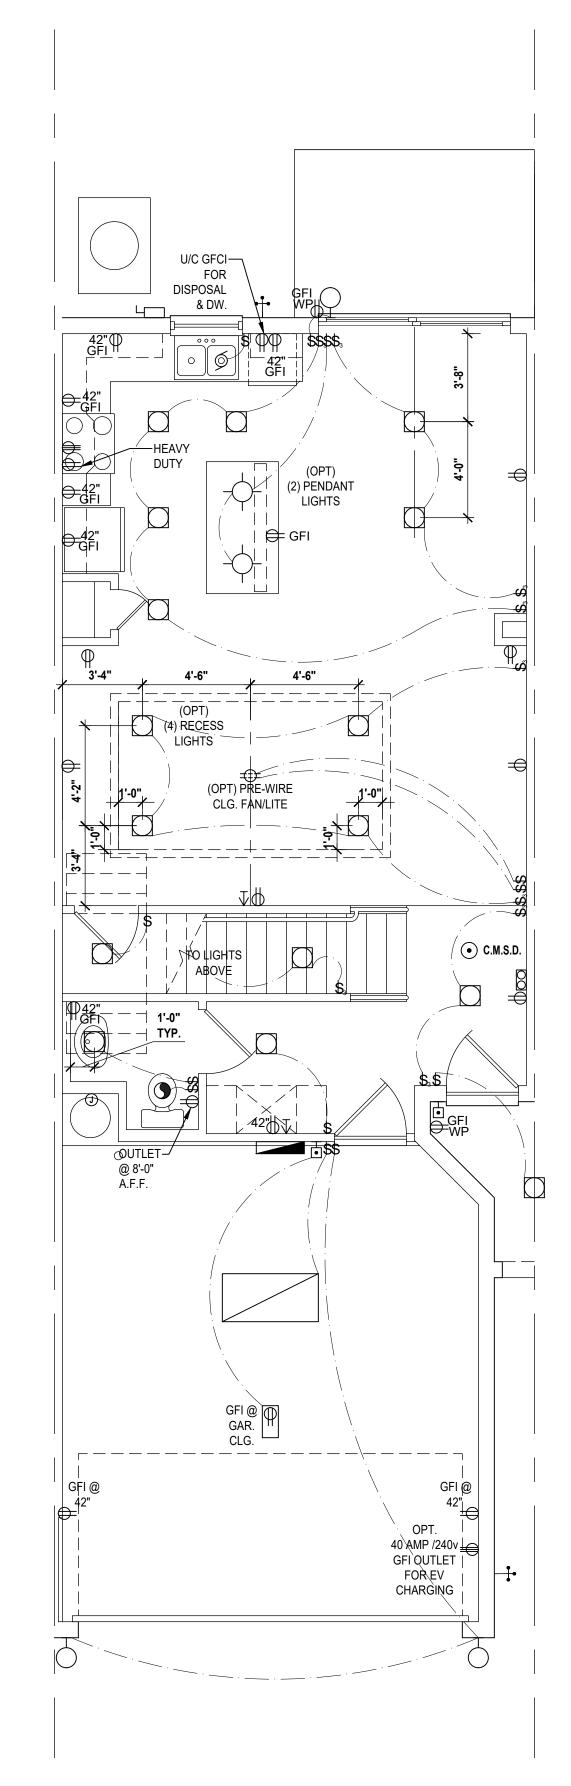

Washington- First Floor

(Standard)

SCALE: 1/4" = 1'-0"

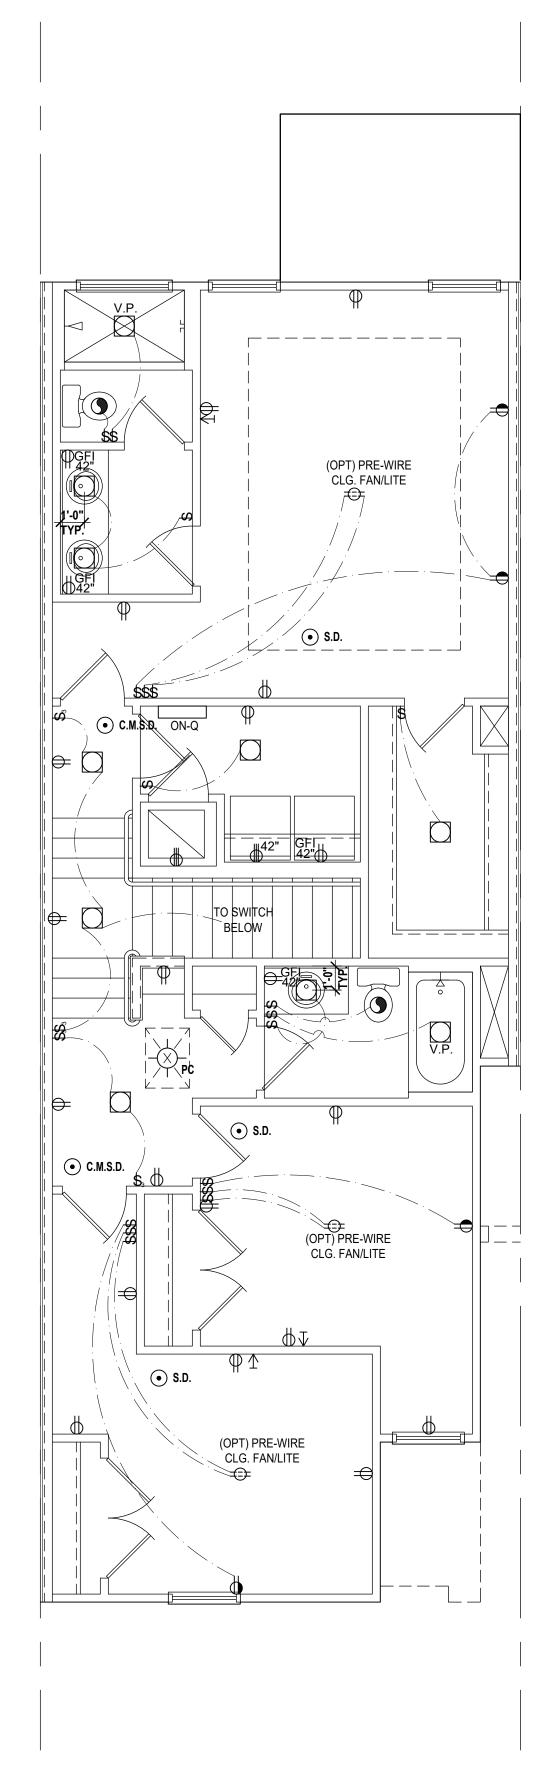

Washington- Second Floor

(Standard)

SCALE: 1/4" = 1'-0"

GENERAL NOTES KEY

- 1. BUILDER TO VERIFY EXACT LOCATION OF FLOOR
- OUTLETS IN FIELD.

 2. ALL OUTLETS ARE TO BE AFCI PROTECTED.
- ALL 15A AND 20A 120V BRANCH CIRCUITS WILL BE AFCI
- PROTECTED.
- 4. ALL 15A AND 20A 120V BRANCH CIRCUITS LOCATED IN
- THE GARAGE AND LAUNDRY WILL BE GFCI PROTECTED.

 5. ALL GARAGE BAYS WILL HAVE DEDICATED GFCI OUTLET.
- ALL OUTLETS LOCATED IN THE KITCHEN AND BATHROOMS ARE TO BE GFCI PROTECTED.

PROTECTED.

AND AFCI PROTECTED.

- . DW. AND GARBAGE DISPOSAL ARE TO BE GFCI
- 8. EXCEPTIONS TO THE GFCI STIPULATION WILL BE ALLOWED ONLY IF ALLOWED PER CURRENT NFPA / NEC.
- OUTLETS LOCATED IN THE LAUNDRY ARE TO BE GFCI
- 10. OUTLETS LOCATED WITHIN 6'-0" OF A WET AREA ARE TO BE GFCI PROTECTED.
- 11. ALL OUTLETS OVER COUNTERTOPS TO BE 42" A.F.F. (U.N.O.).
- (U.N.O.).

 12. ALL SMOKE/CARBON MONOXIDE DETECTORS ARE TO BE
- 13. 8'-0" HEIGHT VANITY LIGHTS IN MASTER BATHROOM AND 7'-0" IN ALL OTHER BATHROOMS.

HARD WIRED, INTERCONNECTED AND AFCI PROTECTED.


- 14. ANY EXTERIOR WALL ELECTRICAL, MECHANICAL AND PLUMBING PENETRATIONS SHOULD BE FITTED WITH
- QUICKFLASH PANELS (OR SIMILAR).

 5. RECESSED LUMINAIRES INSTALLED IN THE BUILDING
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AIR TIGHT. ALSO SEE FBCE 410.116. NOTES: THIS DIAGRAMMATIC PLAN IS INTENDED TO SHOW

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THEY MUST ALSO BE LOCATED NO MORE THAN 10' FROM
ANY BEDROOM DOOR OPENING PER FBC-R315.1.



designers group

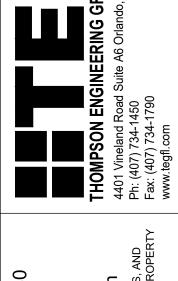ELECTRICAL KEY:

CEILING MOUNTED LIGHT	S (09) I		4	
PULL CHAIN LIGHT	Series∖4-Unit Presidential TH (60' S			
FLUSH-MOUNT LED	side			
WALL MOUNTED LIGHT	t Pre		20	3
WALL WASH RECESSED	-Uni	ODE	J.	NDO DU
DUPLEX RECEPTACLE	3s/4·	GREA	TER ORLA	NDO BO
220 V RECEPTACLE	Serie			
1/2 HOT, 1/2 SWITCHED		S		
WATER PROOF RECEPTACLE	el)-	Series		
FLOOR RECEPTACLE	He	<u>ā</u>		
PRE-WIRE FOR CLG. FAN	aisec		Jan	
GROUND FAULT INTERRUPT	(Re	09	Frun	
WALL SWITCH	mes	9	er, 1	
3-WAY SWITCH	'nho		Cart	×
DIMMER SWITCH	To≪	ential	on,	X #
TELEPHONE JACK	ıtial	בַּוֹ	ingt	Pad
CABLE JACK	sidential Townhomes (Raised Heel)- 60'	14 14	Vashington, Carter, Truman	ng
	= ()		_	

PRE-WIRE GARAGE DOOR OPENER

DOOR BELL / GARAGE DOOR SWITCH

FLUSH MOUNT FLUORESCENT LIGHT

FAN / LIGHT COMBINATION

JUNCTION BOX

A.F. ARC FAULT PROTECTION

L.V. LOW VOLTAGEV.P. VAPOR PROOF

以 IC INTERCOM

GARBAGE DISPOSAL MOTOR

FLUORESCENT LIGHT

ELECTRICAL PANEL

DISCONNECT SWITCH
ELECTRICAL METER

C.M.S.D. CARBON MONOXIDE / SMOKE DETEC

• S.D. SMOKE DETECTOR

CEILING FAN

do)/1- Townhome Models\Presidential To

-Unit: (Presidential To

Models: Truman, Washington

Building Pad #

division of Park Square
nterprises Inc.
200 Vineland Rd. Suite #200
rlando, Fl. 32811




ISSUE DATE 02/02/20


REVISIONS

PROJECT: 00-0000
SCALE: AS NOTED
DRAWN BY: C.C.
DESIGNED BY: MJS

ELECTRICAL LAYOUT

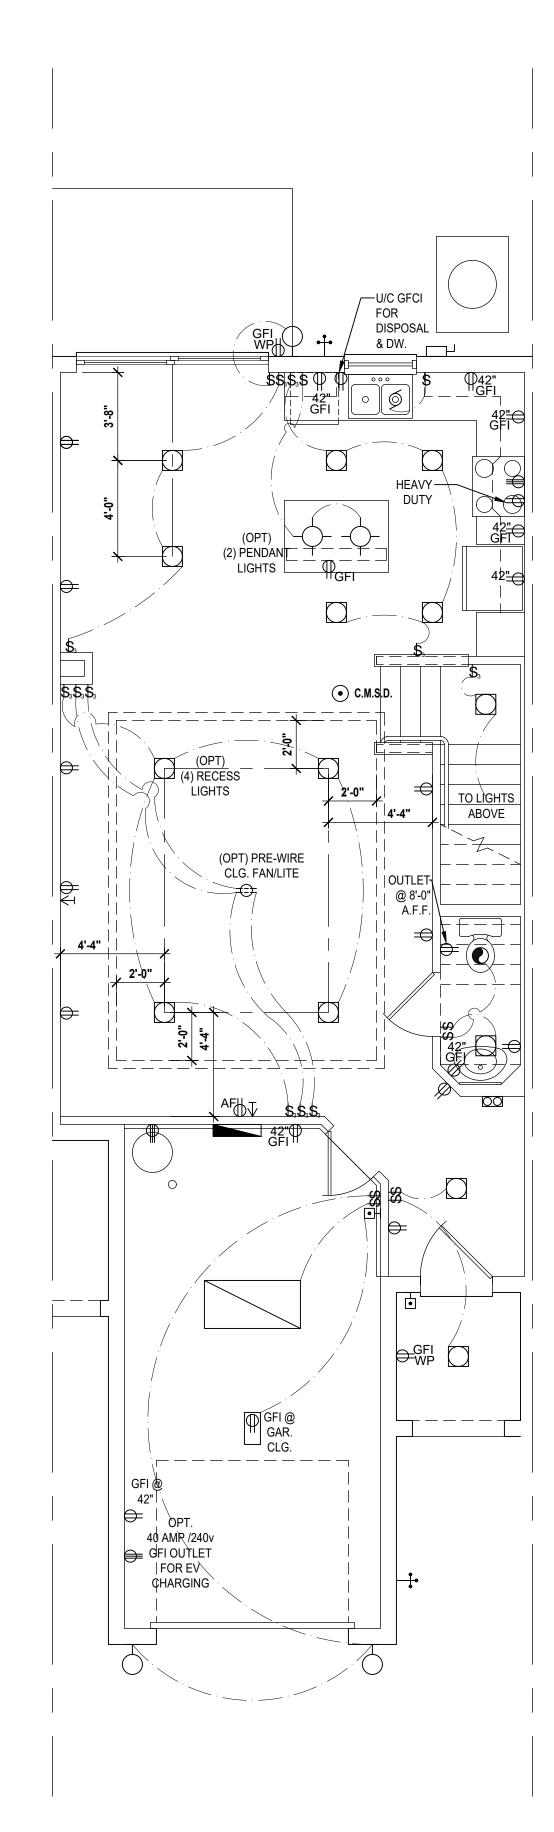

Carter First Floor SCALE: 1/4" = 1'-0"

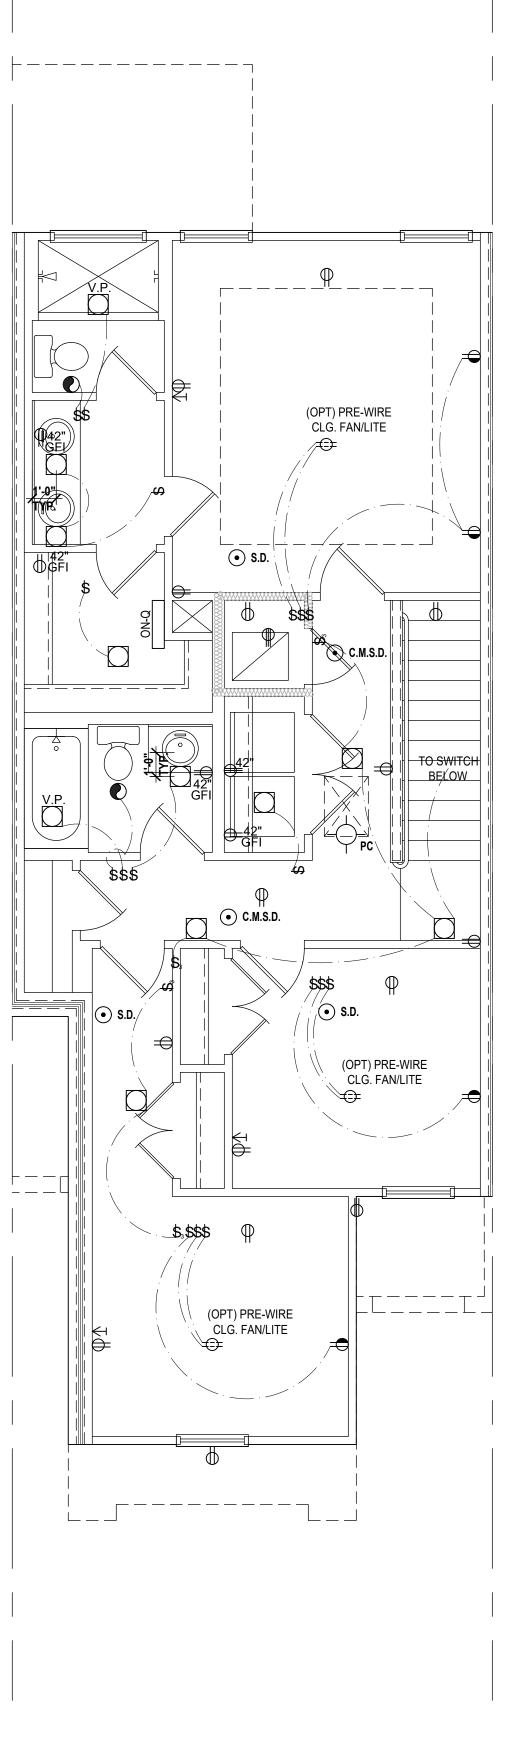

Carter Second Floor SCALE: 1/4" = 1'-0"

GENERAL NOTES KEY:

. BUILDER TO VERIFY EXACT LOCATION OF FLOOR

OUTLETS IN FIELD.

. ALL OUTLETS ARE TO BE AFCI PROTECTED. ALL 15A AND 20A 120V BRANCH CIRCUITS WILL BE AFCI

PROTECTED.

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ALL GARAGE BAYS WILL HAVE DEDICATED GFCI OUTLET.

ALL OUTLETS LOCATED IN THE KITCHEN AND BATHROOMS ARE TO BE GFCI PROTECTED.

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PROTECTED. 8. EXCEPTIONS TO THE GFCI STIPULATION WILL BE

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ELECTRICAL KEY:

CEILING MOUNTED LIGHT

PULL CHAIN LIGHT

FLUSH-MOUNT LED

WALL MOUNTED LIGHT WALL WASH RECESSED

DUPLEX RECEPTACLE 220 V RECEPTACLE 1/2 HOT, 1/2 SWITCHED

FLOOR RECEPTACLE PRE-WIRE FOR CLG. FAN

⇒_{GFI} | GROUND FAULT INTERRUPT

WALL SWITCH 3-WAY SWITCH \$_□ DIMMER SWITCH ▼ TELEPHONE JACK

FLUORESCENT LIGHT

L DISCONNECT SWITCH M ELECTRICAL METER S.D. | SMOKE DETECTOR

WALL SCONCE

CHANDELIER SPOT LIGHT

SPEAKER

• L.V. LOW VOLTAGE

V.P. VAPOR PROOF

以 IC INTERCOM

JUNCTION BOX

A.F. ARC FAULT PROTECTION

FAN / LIGHT COMBINATION

GARBAGE DISPOSAL MOTOR

⇒ CEILING FAN

ELECTRICAL PANEL

← CABLE JACK

WATER PROOF RECEPTACLE

PRE-WIRE GARAGE DOOR OPENER

HOOR BELL / GARAGE DOOR SWITCH

C.M.S.D. CARBON MONOXIDE / SMOKE DETECTOR

FLUSH MOUNT FLUORESCENT LIGHT








REVISIONS

PROJECT: 00-0000
SCALE: AS NOTED
DRAWN BY: C.C.


DESIGNED BY: MJS

ELECTRICAL LAYOUT **E**3


Electrical Plan SCALE: 1/4" = 1'-0"

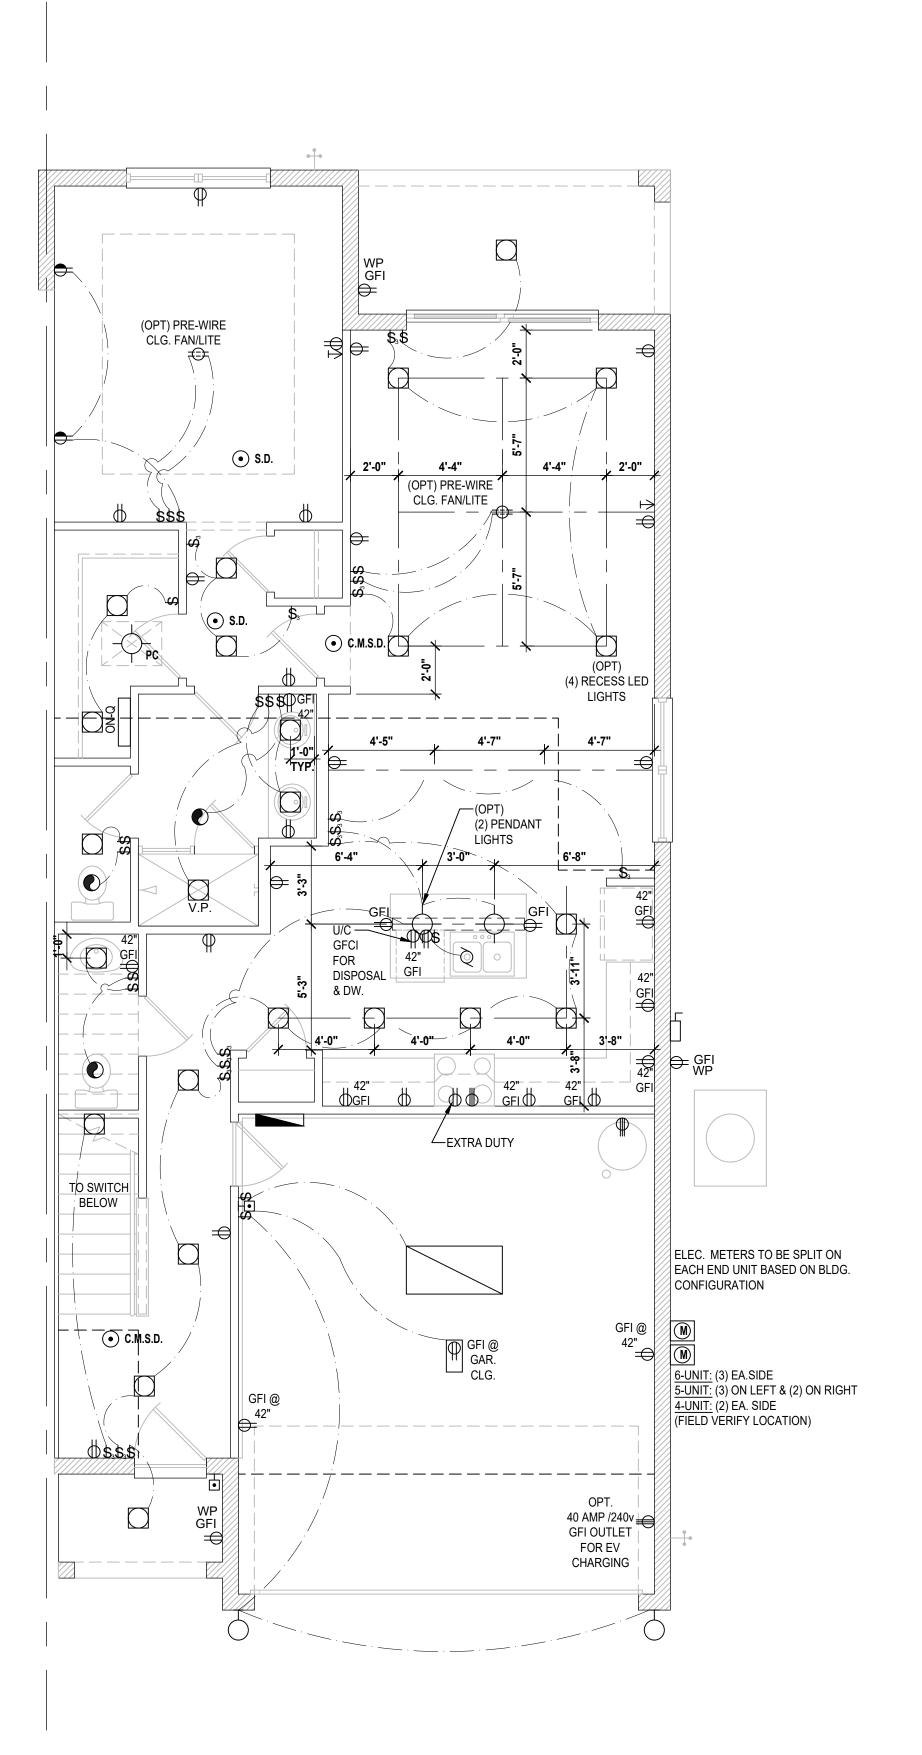

Truman-Rev. First Floor (Standard)
SCALE: 1/4" = 1'-0"

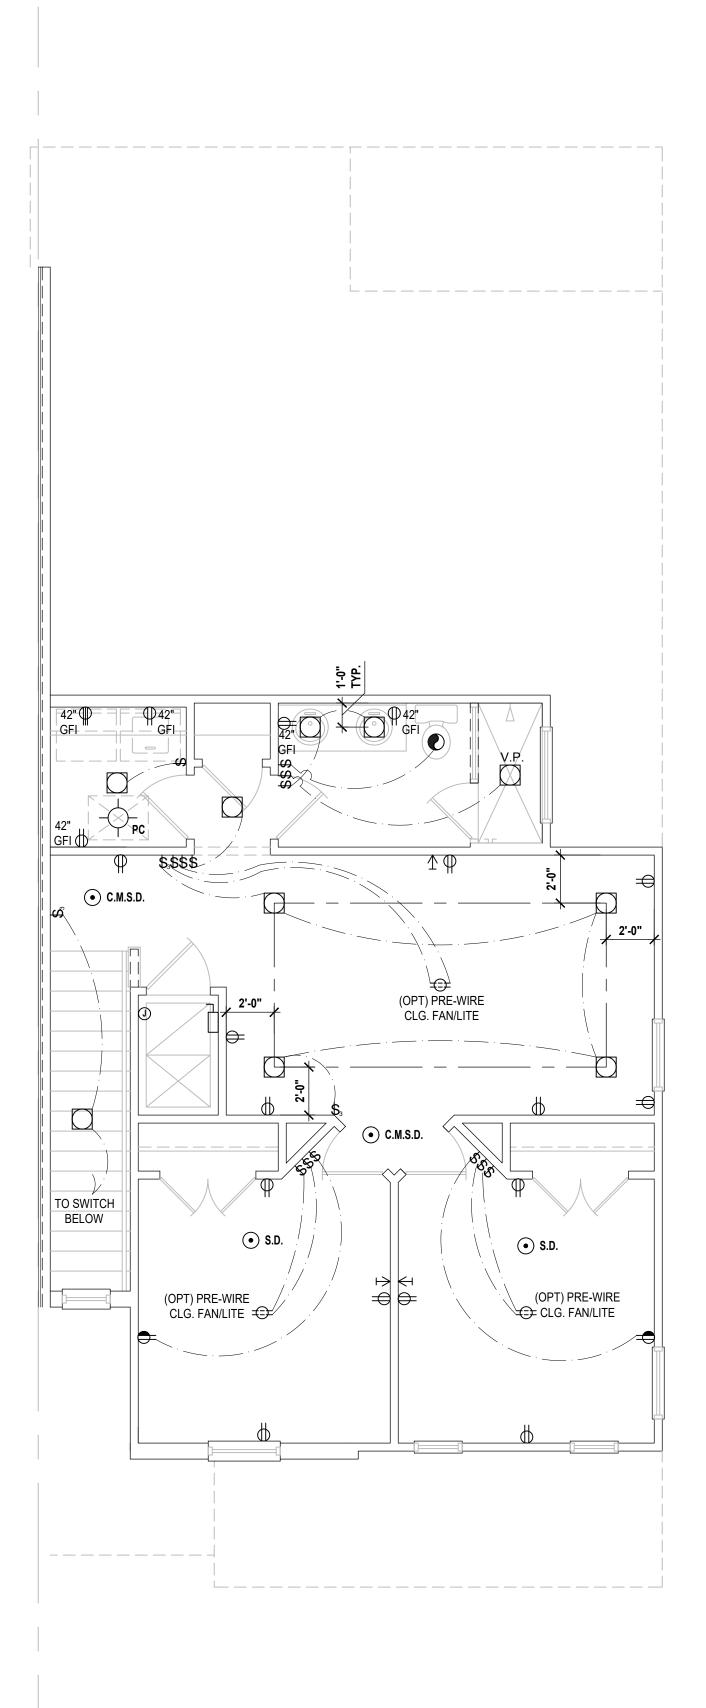

Truman-Rev. Second Floor (Elev.- B) SCALE: 1/4" = 1'-0"

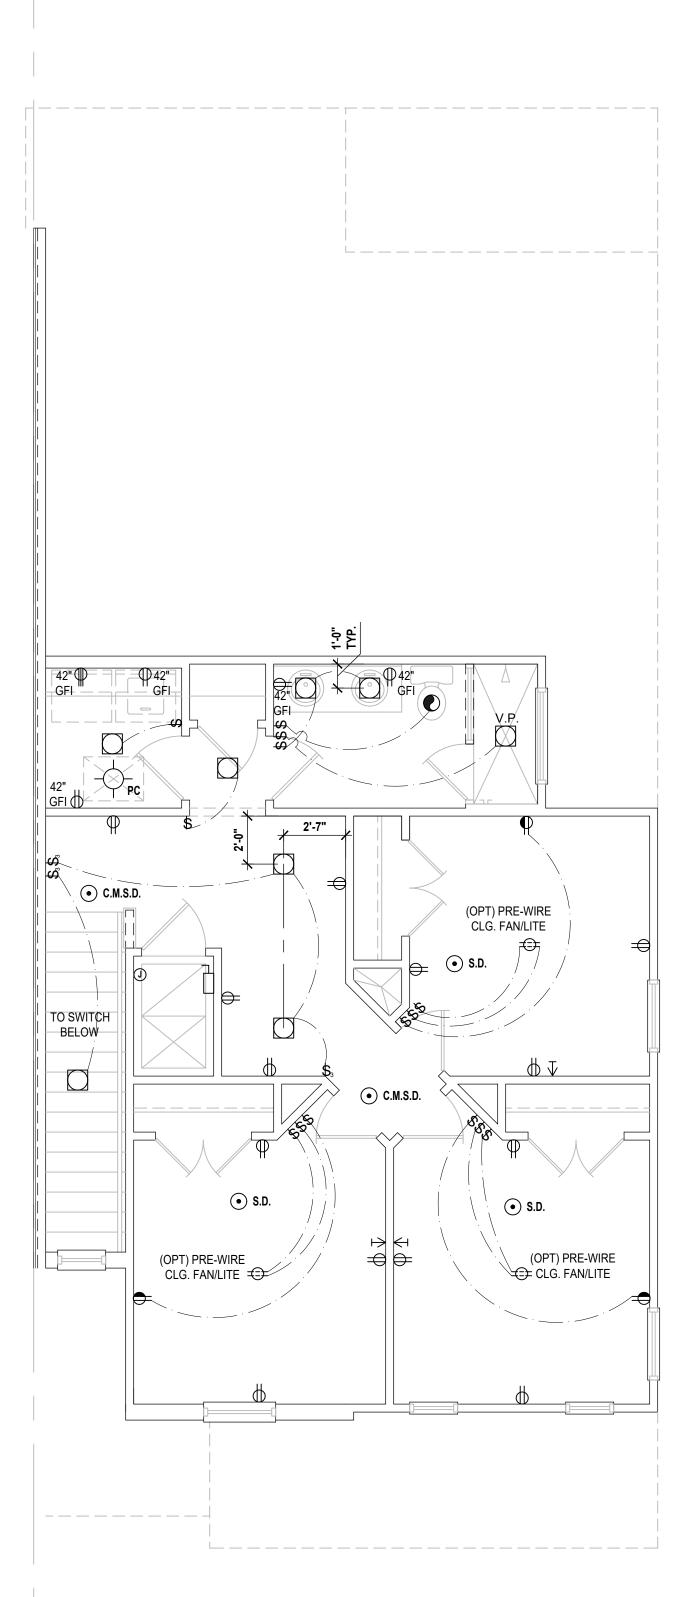

Truman-Rev. Second Floor $\frac{\text{(Opt - 4 Bedroom)}}{\text{SCALE: 1/4" = 1'-0"}}$

GENERAL NOTES KEY

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ELECTRICAL KEY:

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PULL CHAIN LIGHT

FLUSH-MOUNT LED

WALL MOUNTED LIGHT

WALL WASH RECESSED DUPLEX RECEPTACLE

FLOOR RECEPTACLE

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── FLUORESCENT LIGHT

DISCONNECT SWITCH ELECTRICAL METER

C.M.S.D. CARBON MONOXIDE / SMOKE DETEC

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FLUSH MOUNT FLUORESCENT LIGHT

FAN / LIGHT COMBINATION

GARBAGE DISPOSAL MOTOR

SCALE: 1/4" = 1'-0"



A B







REVISIONS

PROJECT: 00-0000
SCALE: AS NOTED
DRAWN BY: C.C.
DESIGNED BY: MJS

Electrical Layout Electrical Layout E4