

3042 SANIBEL (TPA)



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DISTRIBUTED LIVE LOAD

(IN POUNDS PER SQ. FT.)

UNINHABITABLE ATTICS WITHOUT STORAGE
UNINHABITABLE ATTICS WITH LIMITED STORAGE
HABITABLE ATTICS & ATTICS SERVED WITH FIXED STAIRS
BALCONIES (EXTERIOR) AND DECKS

FIRE ESCAPES
GUARDS AND HANDRAILS
GUARD IN-FILL COMPONENTS
PASSENGER VEHICLE GARAGES
ROOMS OTHER THAN SLEEPING ROOMS
SLEEPING ROOMS

ANSI STANDARD FOR MEASURING HOUSES

THE ANSI STANDARD FOR MEASURING HOUSES:
NATIONAL STANDARD Z765-1996 NEW CONSTRUCTION THE ANSI
STANDARDS BASE FLOOR AREA CALCULATIONS ON THE EXTERIOR
DIMENSIONS OF THE BUILDING AT EACH FLOOR LEVEL AND INCLUDE ALI
INTERIOR WALLS AND VOIDS. FOR ATTACHED UNITS, THE OUTSIDE
DIMENSION IS THE CENTER LINE OF THE COMMON WALLS. INTERNAL
ROOM DIMENSIONS AREN'T USED IN THIS SYSTEM OF MEASURING. THE
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DIMENSION IS THE CENTER LINE OF THE COMMON WALLS. INTERNAL
ROOM DIMENSIONS AREN'T USED IN THIS SYSTEM OF MEASURING.

THE ANSI STANDARDS BASE FLOOR AREA CALCULATIONS ON THE EXTERIOR DIMENSIONS OF THE BUILDING AT EACH FLOOR LEVEL AND INCLUDE ALL INTERIOR WALLS AND VOIDS SEPARATED INTO TWO

AIR-CONDITIONED SPACE
 NON-AIR-CONDITIONED SPACE (GARAGES, PATIOS, PORCHES,

THE ANSI STANDARDS DEFINE "FINISHED AREA" AS "AN ENCLOSED AREA IN A HOUSE SUITABLE FOR YEAR-ROUND USE, EMBODYING WALLS, FLOORS, AND CEILINGS THAT ARE LIKE THE REST OF THE MEASUREMENTS MUST BE TAKEN TO THE NEAREST INCH OR TENTH OF A FOOT, AND FLOOR AREA MUST BE REPORTED TO THE NEAREST SQUARE FOOT. THESE WOULD INCLUDE BONUS/ATTIC SPACES AND ARE USUIALLY LISTED SEPARATELY

GENERAL CONTRACTOR:

IT IS THE RESPONSIBILITY OF THE GENERAL CONTRACTOR TO INSTALL ALL MATERIALS MEETING FLORIDA APPROVAL COMPLIANCE TO AVOID WATER INTRUSION AND MOISTURE INTRUSION ON WINDOWS, DOORS, ROOF, AND ANY OTHER AREA AROUND EACH SINGLE FAMILY HOUSE/ APARTMENT/ CONDOMINIUM/ TOWNHOUSE.

SON ENGINEERING GROU reland Road Suite A6 Orlando, FL. 3) 734-1450

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Phone: (407) 529-3000




ISSUE DATE 03/27/2023
REVISIONS

PROJECT: 22-0000
SCALE: AS NOTE
DRAWN BY: M.C.
DESIGNED BY: M.IS

COVER PAGE

REVISION SCHEDULE:

NO:	DATE:	DESCRIPTION:	BY:
1	08/24/21	HEIGHTILO OF 12'-0" BEARING HT.	C.C.
2	12/03/21	CHANGED THE EXTENDED ROOF OVER THE GARAGE ON ELEVATION "C" FROM SHINGLE TO METAL ROOF.	C.C.
3	03/01/22	ADDED ROOF VENT NOTES TO ELEVATIONS	M.C.
4	08/12/22	REVISED PLAN TO REMOVE SCONCE LIGHTS, ADJUST DRAIN FOR TUB, RESIZE MASTER CLOSET DOOR	A.M.
5	08/17/22	REVISE MASTER CLOSET DOOR FROM (2) BARN DOOR TO (2) 4080 DR.	A.M.
6	09/08/22	CREATED ENTRY DETAIL FOR ELEV. C	C.C.
7	03/27/23	REVISED LAUNDRY WET WALL TO 2x6. ADDED HDR. HT. CALLS OUTS TO FLOOR PLAN	C.C.
8	07/27/23	ADDED BANDING AROUND GARAGE DOOR FOR ELEV. B	C.C.
9	12/04/23	THE ELEVATIONS AND ELECTRICAL MARKUPS UPDATED.	G.P.
10		i ————————————————————————————————————	
11			
12			
13			
14			
15			
16			

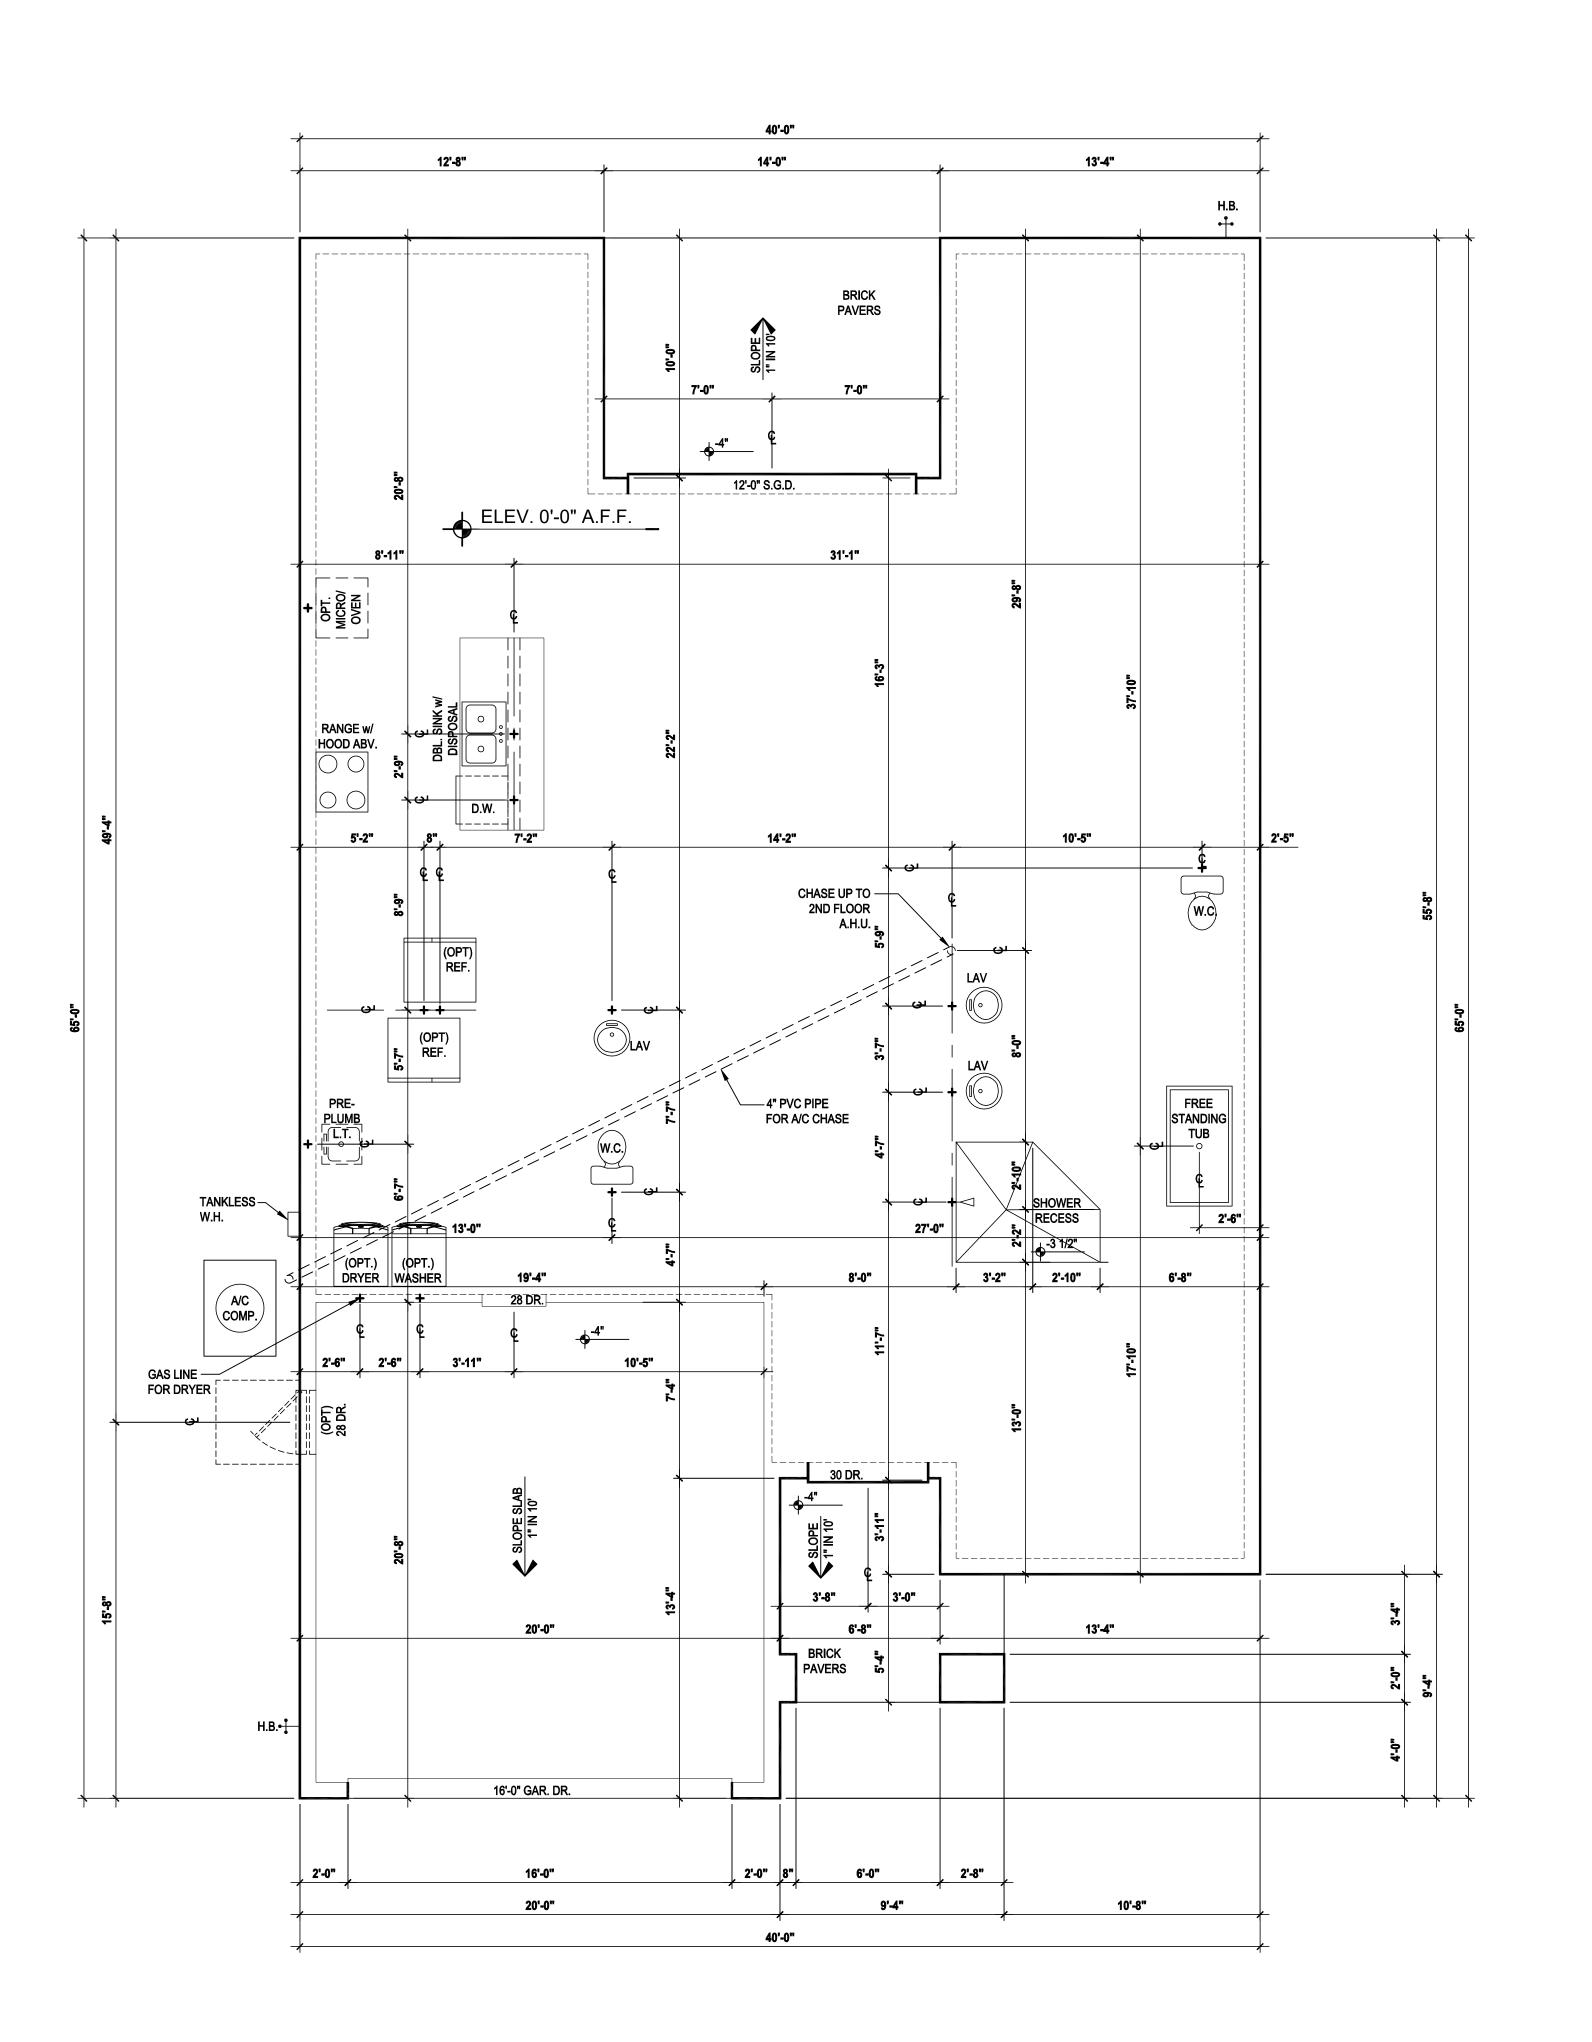

- CONTRACTOR TO VERIFY ALL DIMENSIONS ON JOB SITE.
 - DO NOT SCALE PRINTS. CONSTRUCTION TO BE FROM CALCULATED DIMENSIONS ONLY. ANY DISCREPANCIES OR ERRORS TO BE REPORTED PROMPTLY TO SUPERVISOR FOR CLARIFICATION.
- 3. WATER HEATER T & P RELIEF VALVE SHALL BE FULL SIZE TO EXTERIOR WATER HEATED AT OR ABOVE FLOOR LEVEL SHALL BE IN A PAN WITH DRAIN TO
 - EXTERIOR. WATER HEATER SHALL HAVE AN APPROVED THERMAL EXPANSION DEVICE.

 PAVERS MAY BE USED ILO CONCRETE SLAB AT PATIO.
 - PORCH, DRIVE AND WALKWAY.
 - IN LEIU OF TREATING THE SOIL AN ALTERNATIVE TO TERMITE TREATED SOIL CAN BE TERMICIDE.
- BORA-CARE TO BE APPLIED ON INTERIOR WALLS IAW MANUFACTURERS INSTRUCTIONS AND SPECIFICATIONS. PURSUANT TO CH.482 OF THE FLORIDA BUILDING CODE.

DOOR NOTE KEY:

DOOR SIZE CALLOUT: 20 = 2'-0" 40 B.F. = 4'-0" BIFOLD 24 = 2'-4" 50 B.F. = 5'-0" BIFOLD

24 = 2'-4" 50 B.F. = 5'-0" BIFOLD 26 = 2'-6" 60 B.F. = 6'-0" BIFOLD 28 = 2'-8" 30 = 3'-0"

* ALL INT. DOORS TO BE 6'-8" TALL U.N.O. OR PER BUILDER/CLIENT

Slab Plan "A,B"

(Opt. Master Bath)

SCALE: 1/8" = 1'-0" (11x17) 1/4" = 1'-0" (22x34)



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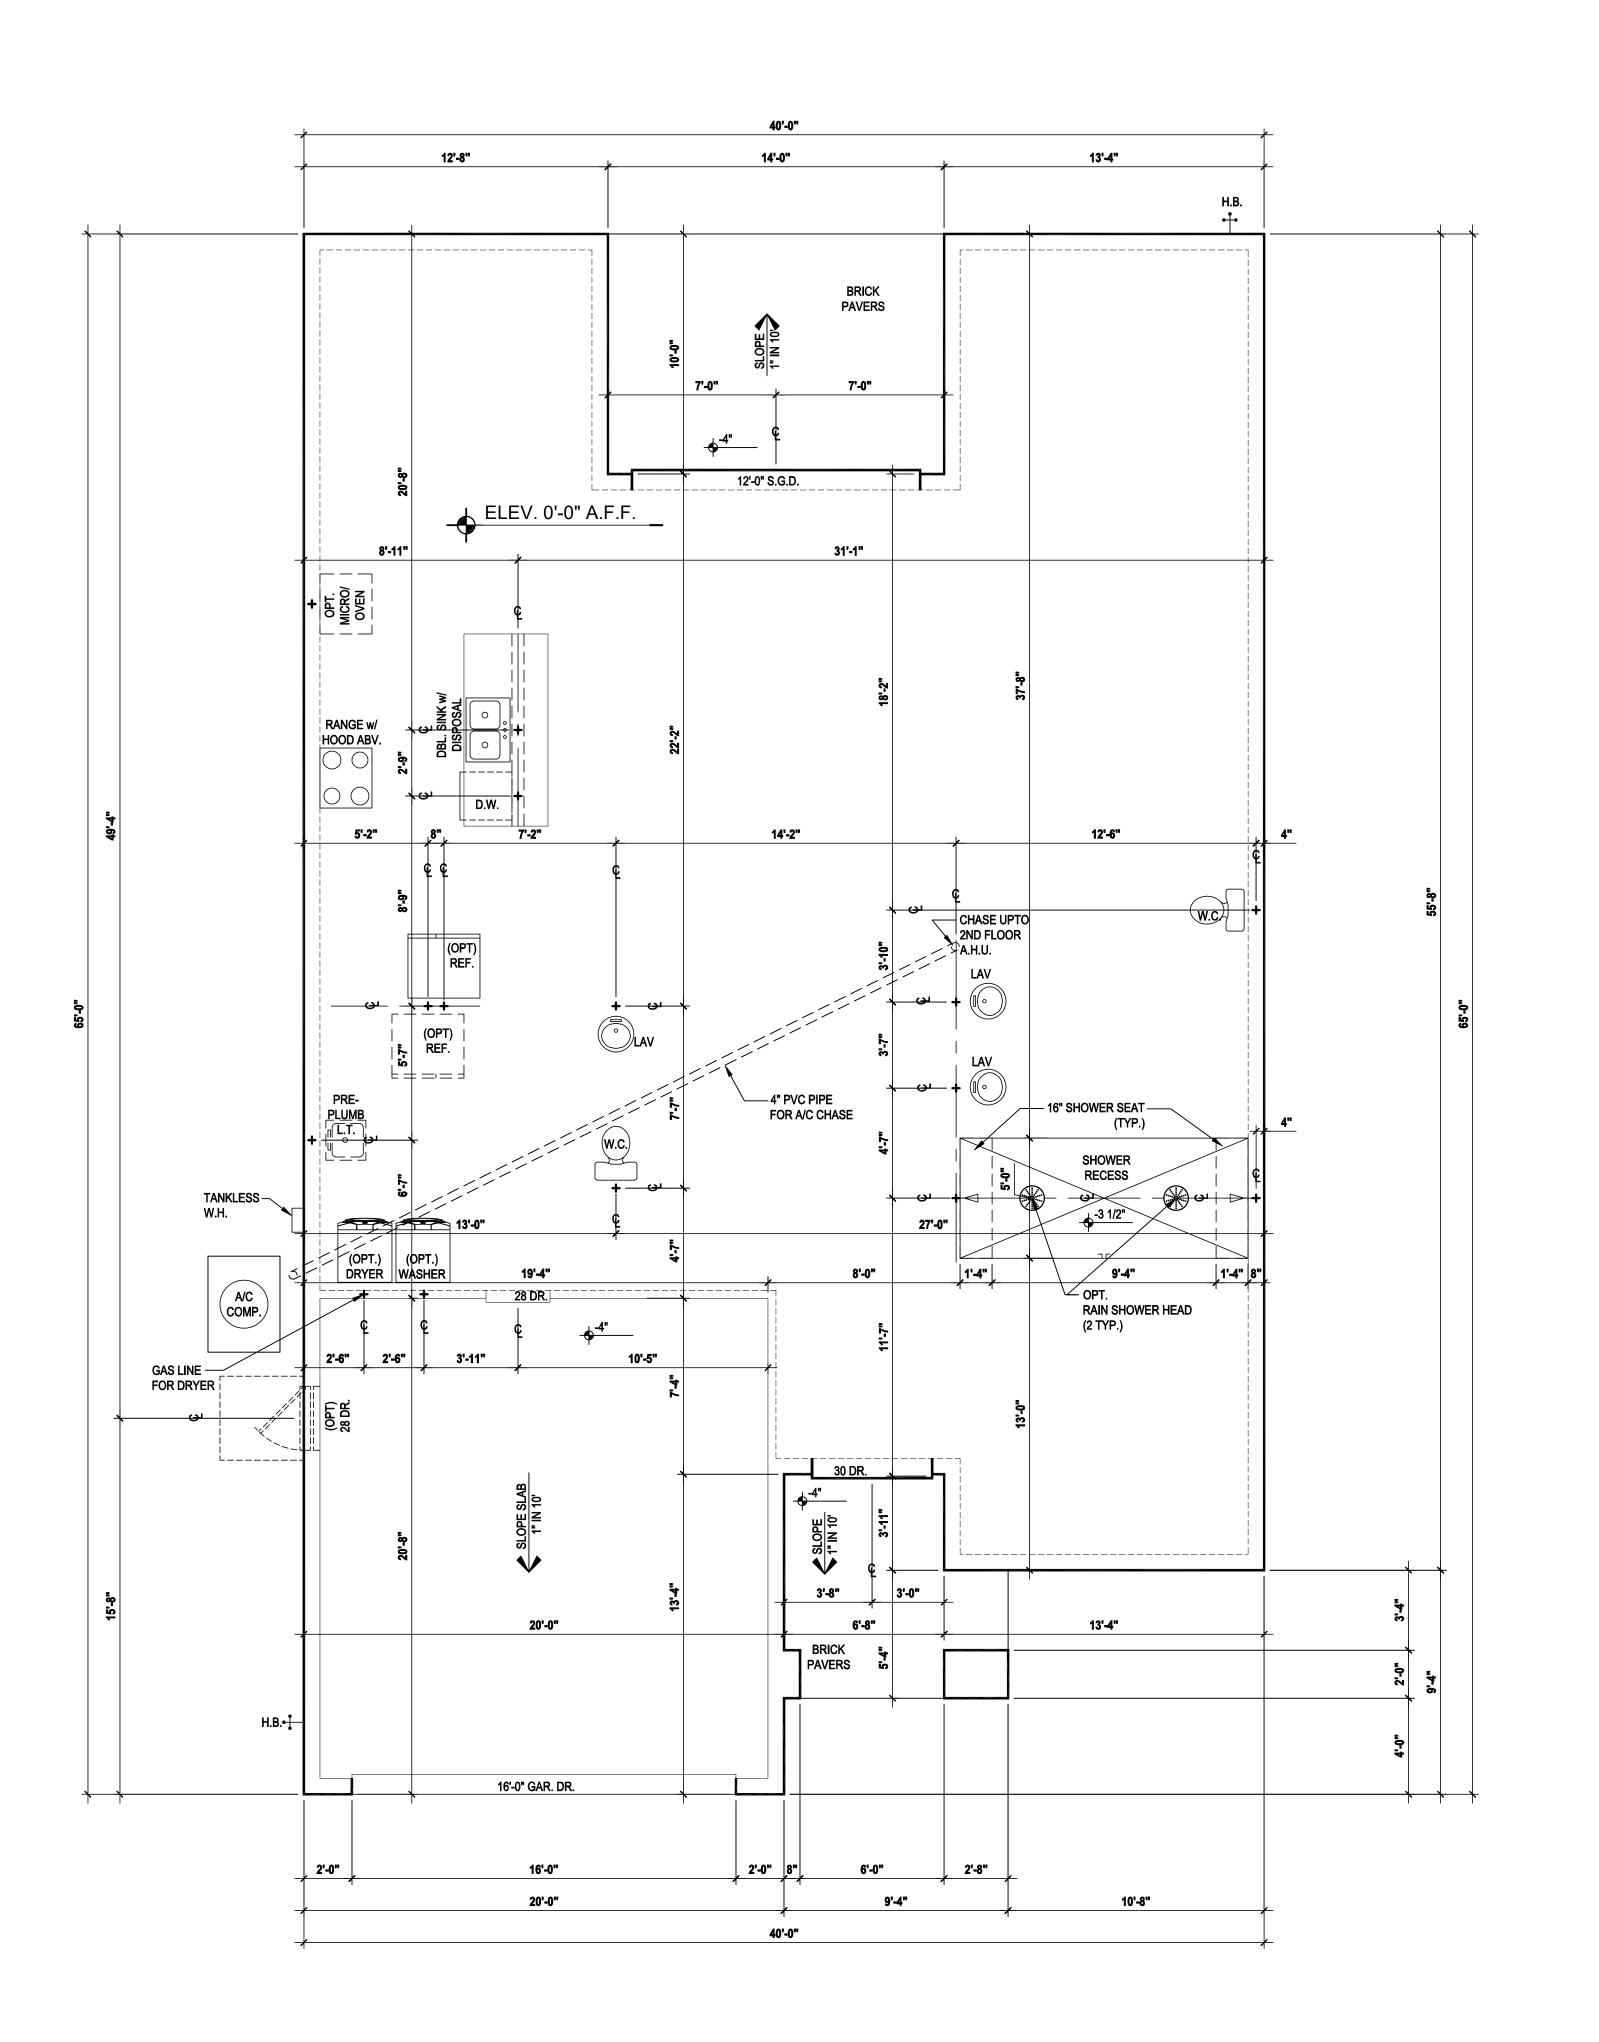
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Orlando, Fl. 32811



ISSUE DATE 03/27/202
REVISIONS

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SCALE: AS NOTED
DRAWN BY: M.C.
DESIGNED BY: MJS

FLOOR PLAN
A1.AB



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* ALL INT. DOORS TO BE 6'-8" TALL U.N.O. OR PER BUILDER/CLIENT







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City, State. Z

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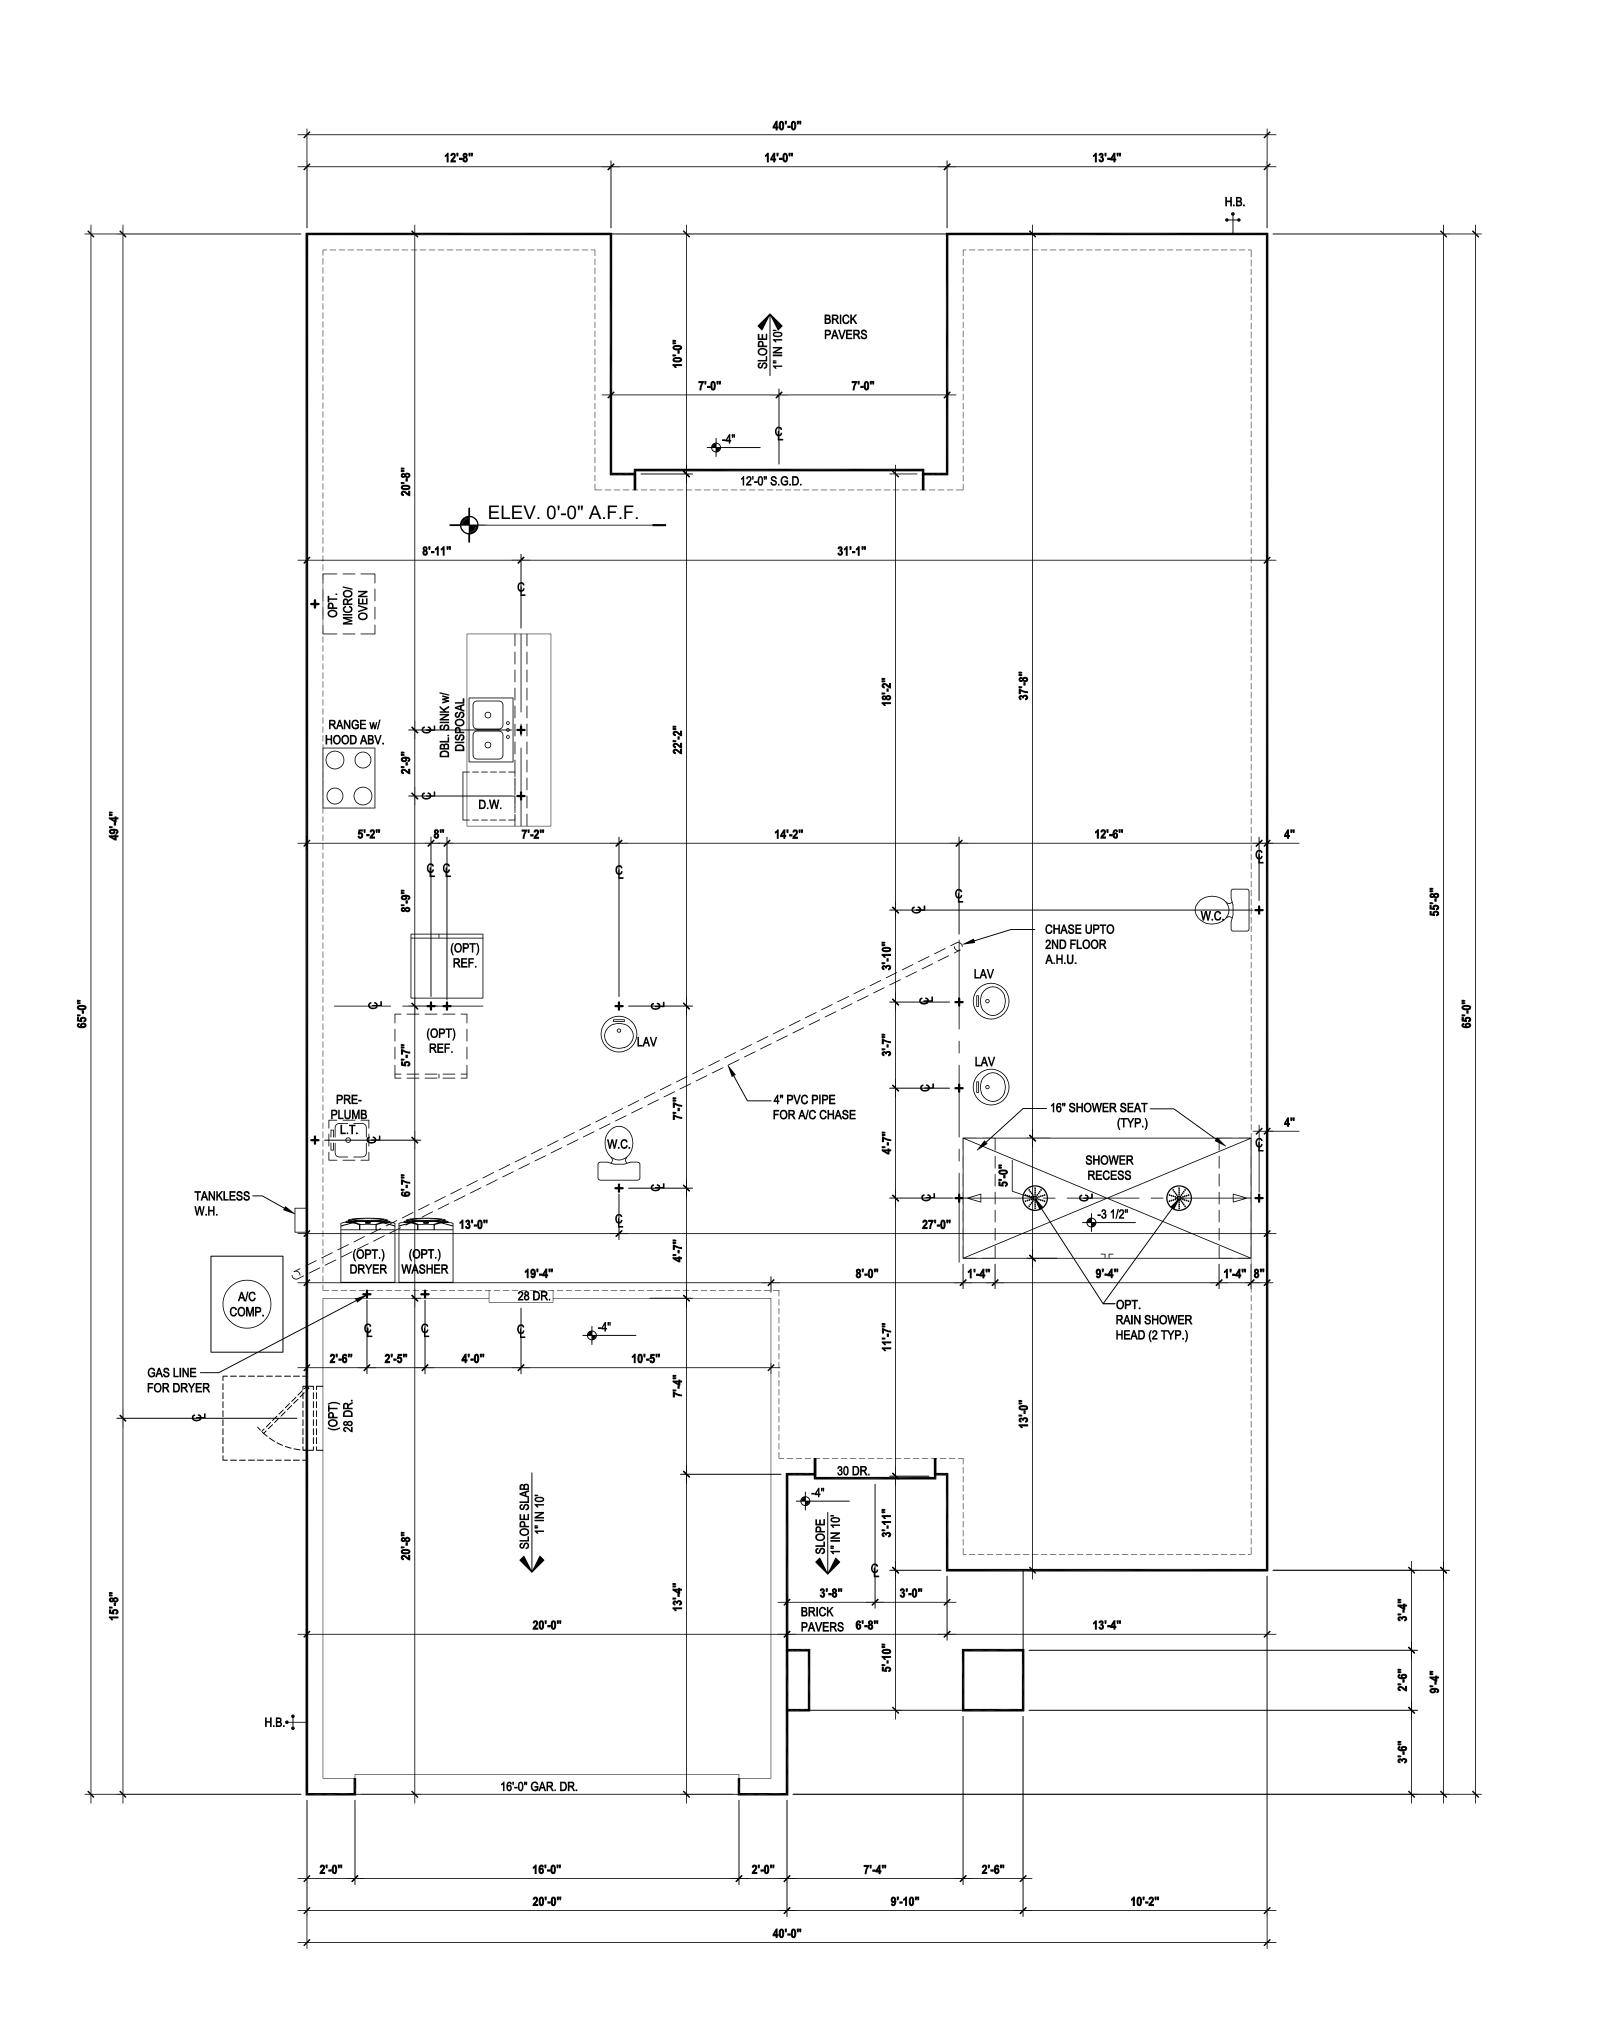
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PROJECT: 22-0000 SCALE: AS NOTED DRAWN BY: M.C. DESIGNED BY: MJS

> FLOOR PLAN A1.AB Le

Slab Plan "A,B"



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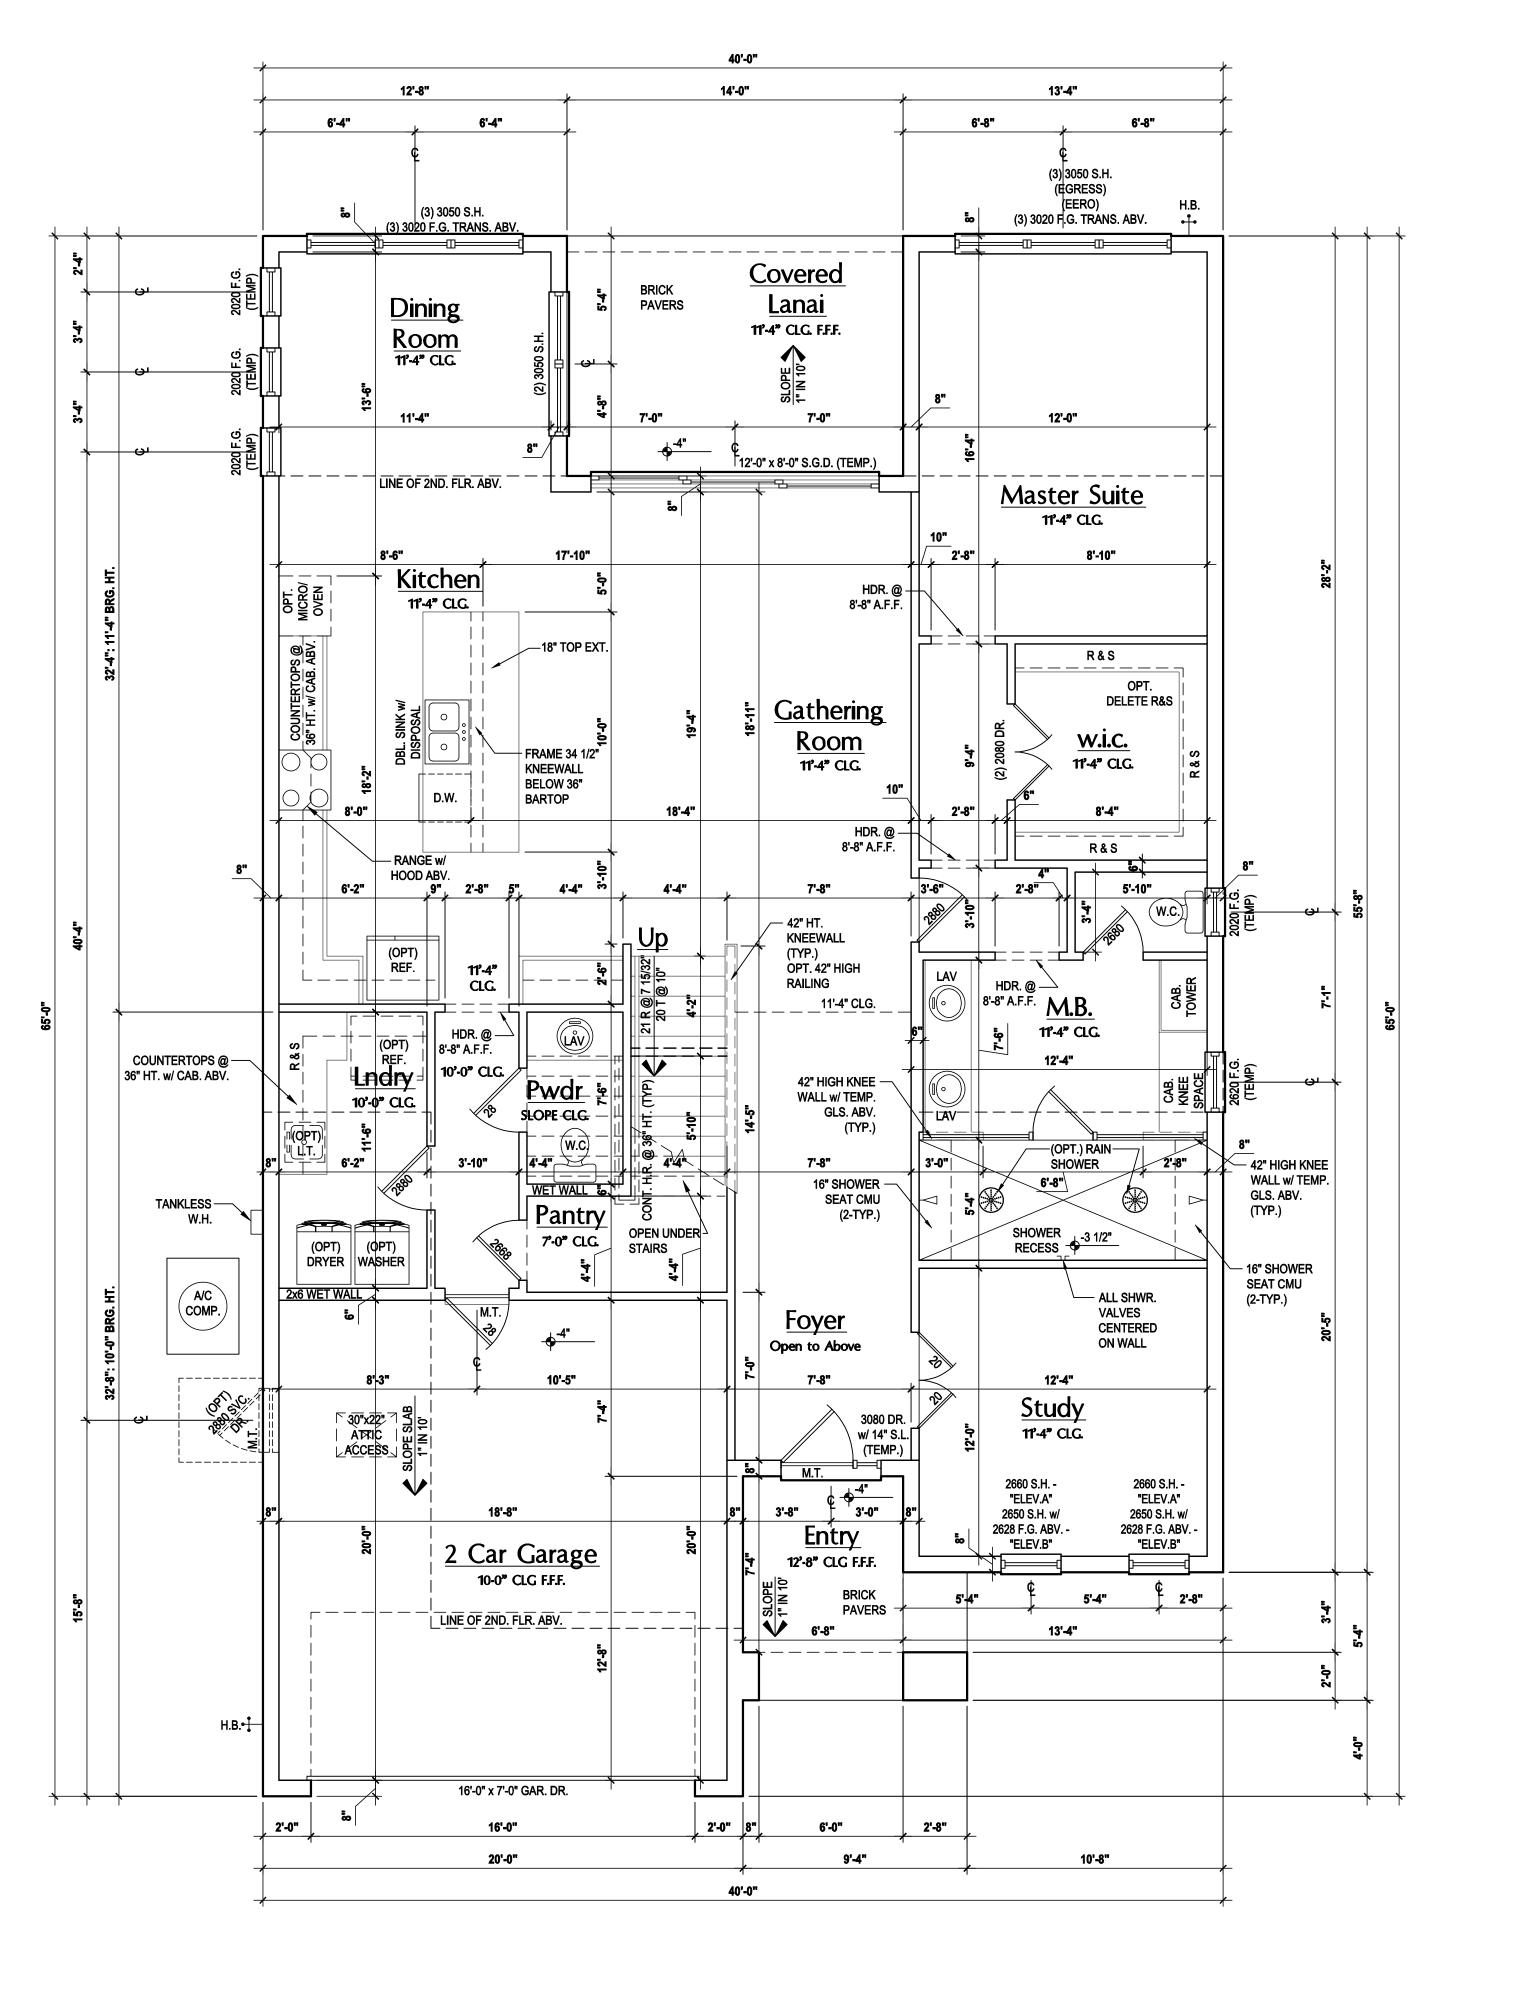



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> FLOOR PLAN A1.C Le


Slab Plan "C" SCALE: 1/8" = 1'-0" (11x17) 1/4" = 1'-0" (22x34)






Opt. Master Bath

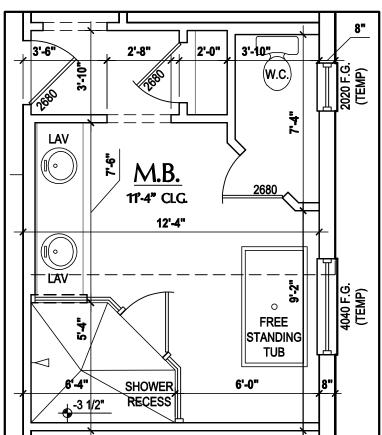SCALE: 1/8" = 1'-0" (11x17) 1/4" = 1'-0" (22x34)

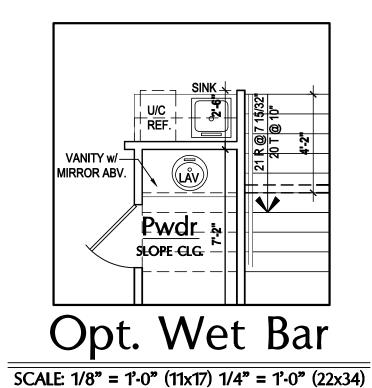

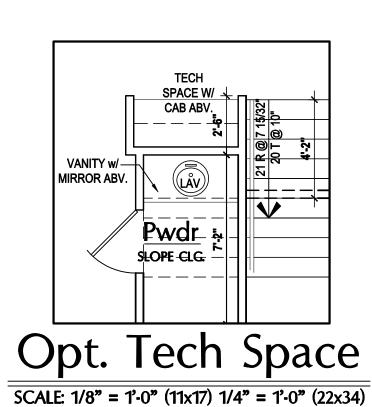

First Floor Plan "A&B"

(Standard)

SCALE: 1/8" = 1'-0" (11x17) 1/4" = 1'-0" (22x34)

GENERAL NOTES KEY:

THIS STRUCTURE HAS BEEN DESIGNED TO MEET OR EXCEE THE (2020) FLORIDA BUILDING CODE (7TH EDITION)

BREVIATIONS:

2- # OF DOORS.

2- # OF WINDOWS.

GLASS

SH - SINGLE HUNG

DH - DOUBLE HUNG

2- # OF WINDOWS.
MT - METAL THRESHOLD
FR - FRENCH DOORS
SL - SIDE LIGHT
FG - FIXED GLASS

OH - DOUBLE HUNG
HR - HORIZONTAL
ROLLER
BP - BYPASS
BF - BIFOLD

SL - SIDE LIGHT

FG - FIXED GLASS

TR - TRANSOM

GB - GLASS BLOCK

• BP - BYPASS

• BF - BIFOLD

• TYP. - TYPICAL

NOTE:

PKT - POCKET DOOR
OBS - OBSCURED GLASS
TEMP - TEMPERED
SPECIALTY WINDOWS/DOORS
FIXED GLASS WINDOWS, AND
TRANSOMS ARE NOTED ON
PLANS

FLOOR PLAN NOTES:

NOTES:

1. CONTRACTOR TO VERIFY ALL DIMENSIONS ON JOB SITE.

DO NOT SCALE PRINTS! CONSTRUCTION TO BE FROM CALCULATE DIMENSIONS ONLY. ANY DISCREPANCIES OR ERRORS TO BE REPORTED PROMPTLY TO SUPERVISOR FOR CLARIFICATION.

MECHANICAL EQUIP. LOCATIONS WILL BE DETERMINED BY

COMMUNITY AND COUNTY CODES.

A/C CONDENSER UNIT TO BE ANCHORED TO SLAB PER CODE M307.

PROVIDE RECESS H&C WATER w/ DRAIN @ WASHER SPACE.

ROVIDE RECESS H&C WATER W/ DRAIN @ WASHER SPACE.

VENT DRYER THRU EXTERIOR WALL U.N.O.

PROVIDE COLD WATER LINE FOR ICE MAKER LINE @ REF. SPACE.

SAG RESISTANT DRYWALL ON ALL CEILINGS.

PULL ALL DIMENSIONS FROM THE REAR OF PLAN.

REFER TO EXTERIOR ELEVATIONS & TYP. DETAIL SHEETS FOR EXTERIOR WALL FINISH SPEC'S.

REFER TO DETAIL SHEETS FOR FLASHING REQUIREMENTS AT ALI WOOD TO MASONRY INTERFACES.

2. ALL INTERIOR FRAME WALL DIMENSIONS TO BE 3 1/2", U.N.O.

ALL EXTERIOR BLOCK WALL DIMENSIONS TO BE 7 1/2", U.N.O.

ALL INT. FIRST FLOOR CEILINGS AT 9'-4" U.N.O.

•• ALL INT. SECOND FLOOR CEILINGS AT 9'-0" U.N.O.

 C.M.U. & FRAME WALL SYSTEM SEGMENTS WHICH HAVE AN UNINTERRUPTED LENGTH OF 12'-0" OR MORE SHALL BE CONSIDER! SHEAR WALL SWS = SHEAR WALL SEGMENTS.

OPENING BETWEEN GARAGE AND RESIDENCE SHALL BE EQUIPPED W/ A 20 MIN. FIRE RATED SOLID WOOD OR HONEYCOMB CORE STEEL DOOR NOT LESS THAN 1 3/8" THICKNESS AS PER FBC-R302.5.1.

INSTALL 5/8" TYPE X DRYWALL ON GARAGE CEILING BENEATH HABITABLE ROOMS (TYP.)

GARAGE DOOR TO BE CERTIFIED BY MFR. FOR 140 M.P.H., U.N.O

. ALL TUB & SHOWER UNITS WILL HAVE ANTI-SCALDING DEVICES INSTALLED.

1/2" GYPSUM BOARDS APPLIED TO THE UNDER STAIR SURFACE AND SIDES.

ALL OPERABLE WINDOWS LOCATED MORE THAN 72" ABV. SURFACE

BELOW SHALL HAVE THE LOWEST PORTION OF WINDOW CLEAR OPENING A MIN. OF 24" ABOVE FINISHED FLOOR BEING SERVER PE (FBC-R312.2).

SEE COLOR SHEET FOR INTERIOR DOOR HEIGHT REQUIREMENTS

 1/2" GYPSUM BOARD APPLIED TO THE GARAGE SIDE OF WALL TO UNDERSIDE OF DECKING.

24. ALL WINDOW AND DOOR ROUGH OPENINGS VARY PER MANUFACTURER'S SPECIFICATIONS, AND ARE NOT REFLECTED ON THE PLANS. DIMENSIONS PROVIDED ON PLANS ARE USED FOR AN APPROXIMATE LOCATION OF WINDOWS & DOORS, AND DO NOT REFLECT THE ROUGH OPENINGS REQUIRED FOR PROPER INSTALLATION. BUILDER WILL BE REQUIRED TO CROSS-REFERENCE ROUGH OPENINGS AND PLAN DIMENSIONS.

SOIL TESTING IS RECOMMENDED. THE DESIGN TEAM AT MJS & E.O.R STRONGLY RECOMMEND A SOIL TEST TO CONFIRM SOIL BEARING CAPACITY AND SURFACE GEO-TECHNICAL CONDITIONS. FOOTINGS SHALL BEAR ON UNDISTURBED SOIL A/O PROPERLY COMPACTED FILL (2000 PSF MIN.). FILL MATERIAL SHALL BE COMPACTED TO 95% DENSITY OF A STANDARD PROCTOR. TO BE VERIFIED BY GENERAL CONTRACTOR / OWNER.

DOOR NOTE KEY:

28 = 2'-8" 30 = 3'-0" 40 B.F. = 4'-0" BI-FOLD 50 B.F. = 5'-0" BI-FOLD 60 B.F. = 6'-0" BI-FOLD

WINDOW NOTE KEY:

WINDOW SIZE CALLOUT: 2040 = 2'-0" x 4'-0" 2050 = 2'-0" x 5'-0" 2060 = 2'-0" x 6'-0"

Area Tabulations

Total Living:

Total Area:

1st floor:

2nd floor:

Cov. Patio:

Garage:

ALL WINDOW CALLOUTS
 ARE MEASURED IN FEE
 & INCHES AS PER THE
 EXAMPLE TABLE ABOVE

1,838 sf

1,204 s

3,042 s

77 s

140 sf

408 s

3,667



40-3042

GOBA

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Lot # - Comm
Street Addre
City, State. Z

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00 Vineland Rd. Suite #200

ISSUE DATE 03/27/202

REVISIONS

REVISIONS

PROJECT: 22-0000


SCALE: AS NOTE

DRAWN BY: M.C.


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FLOOR PLAN


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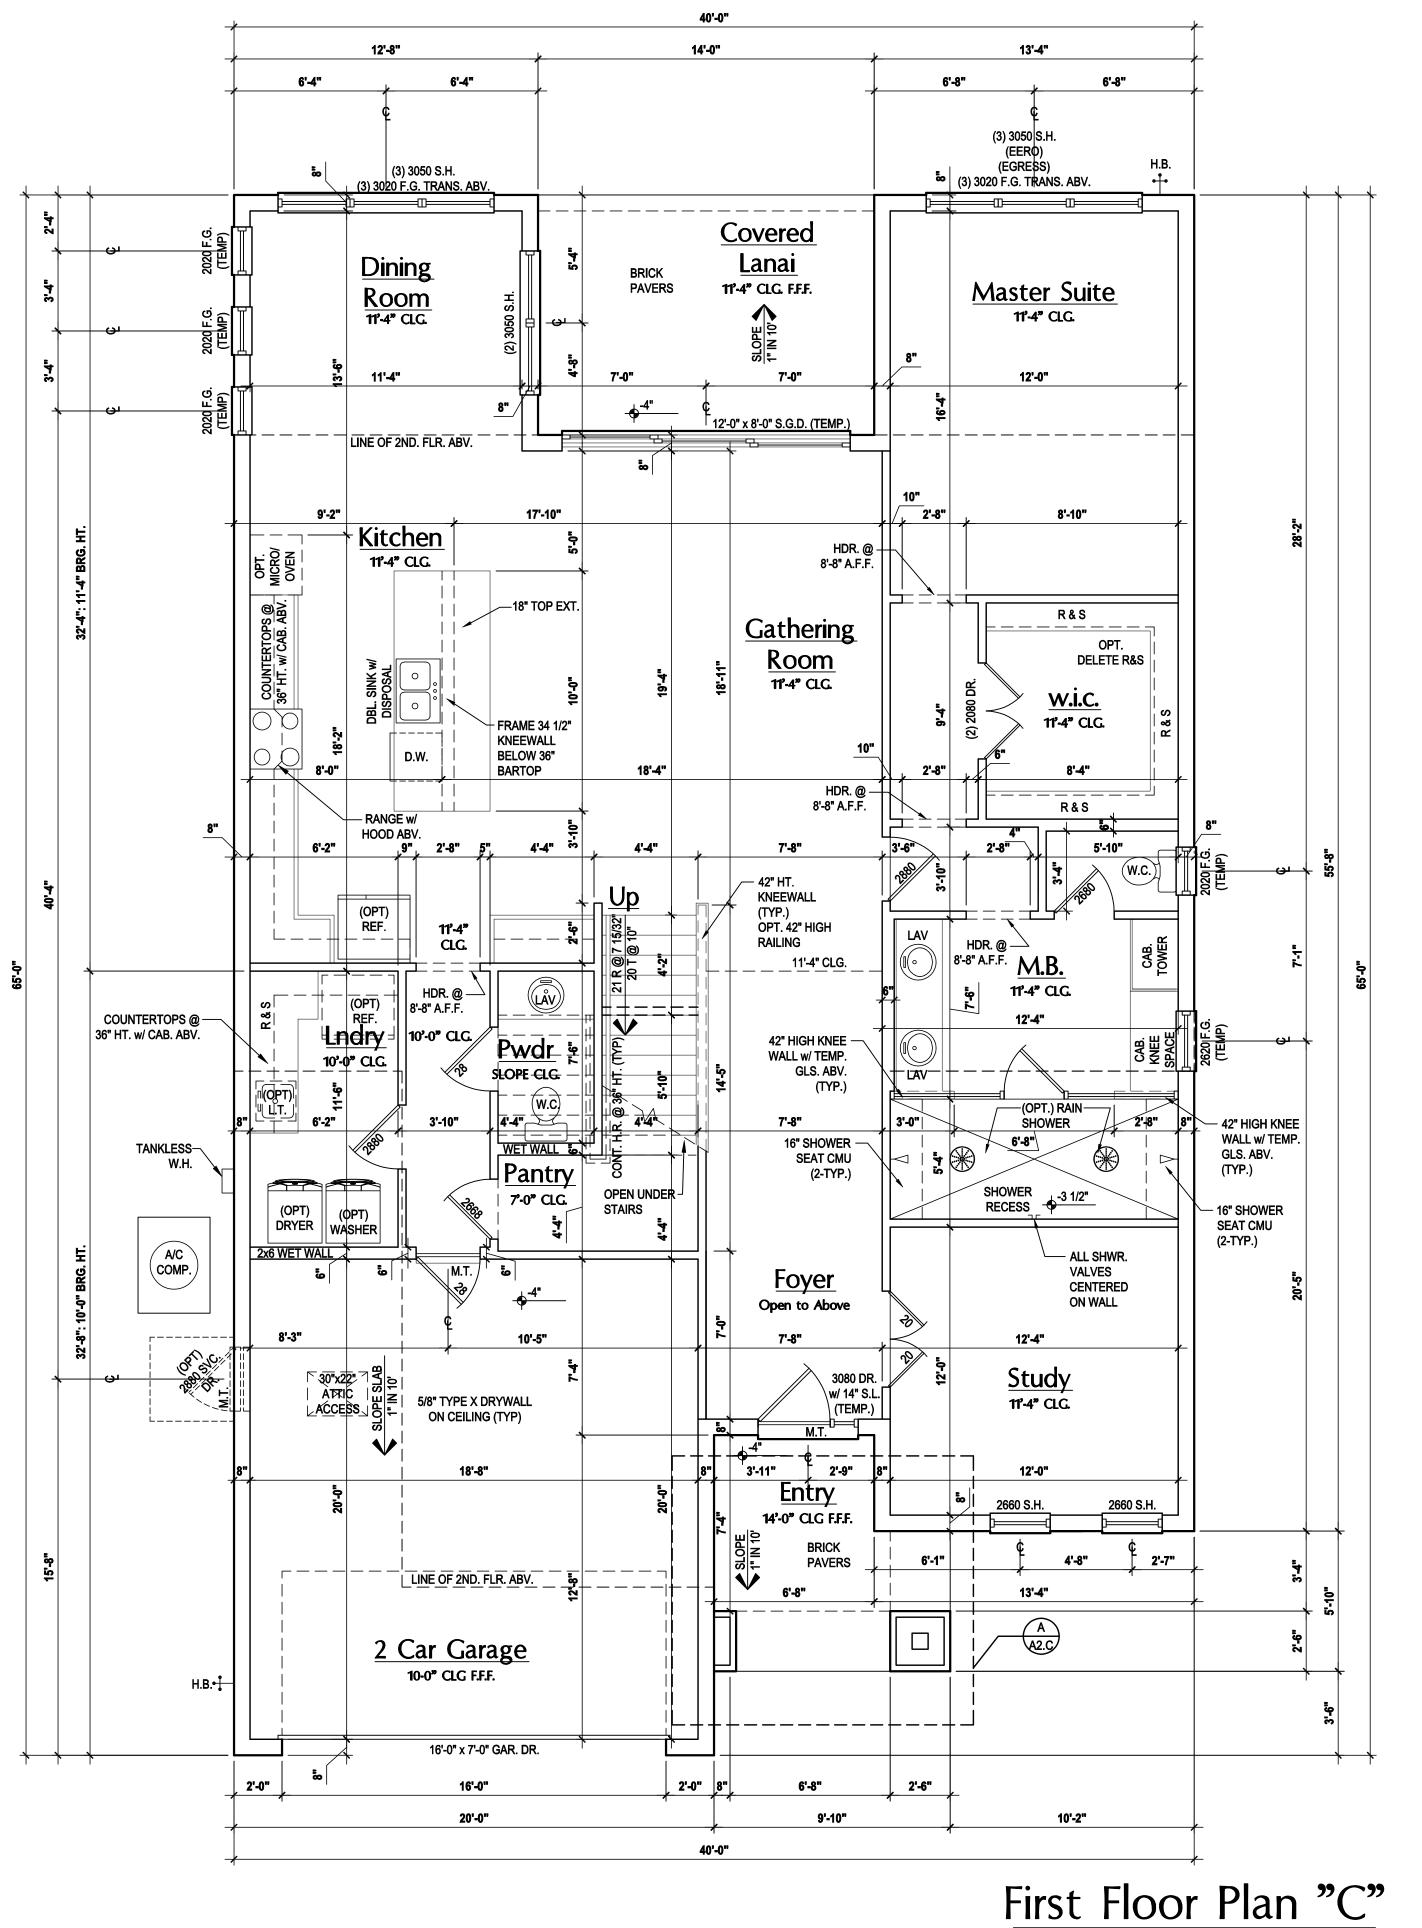


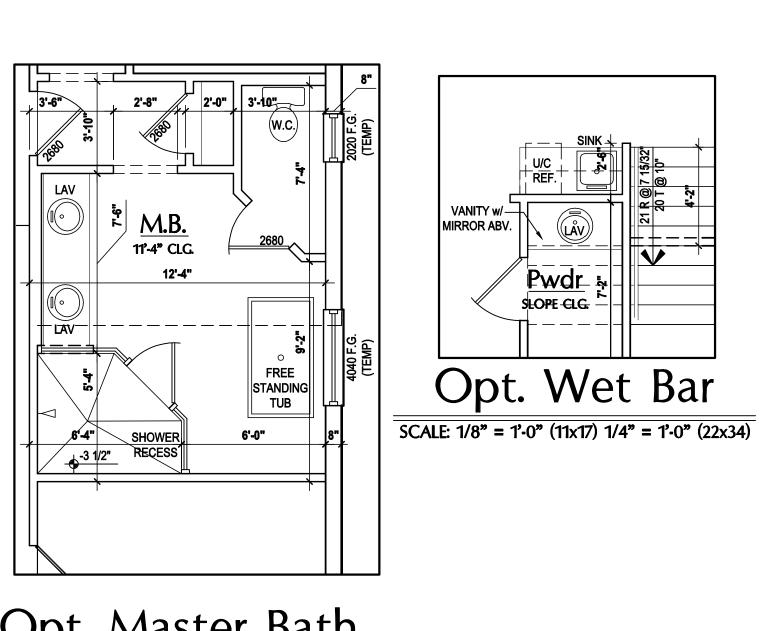

Opt. Master Bath SCALE: 1/8" = 1'-0" (11x17) 1/4" = 1'-0" (22x34)



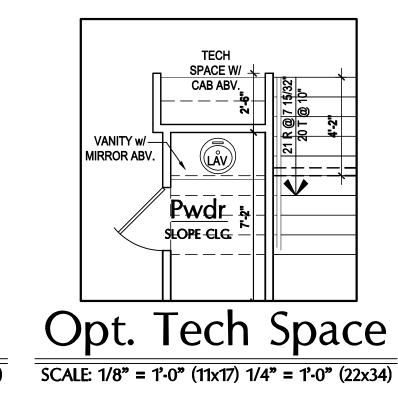

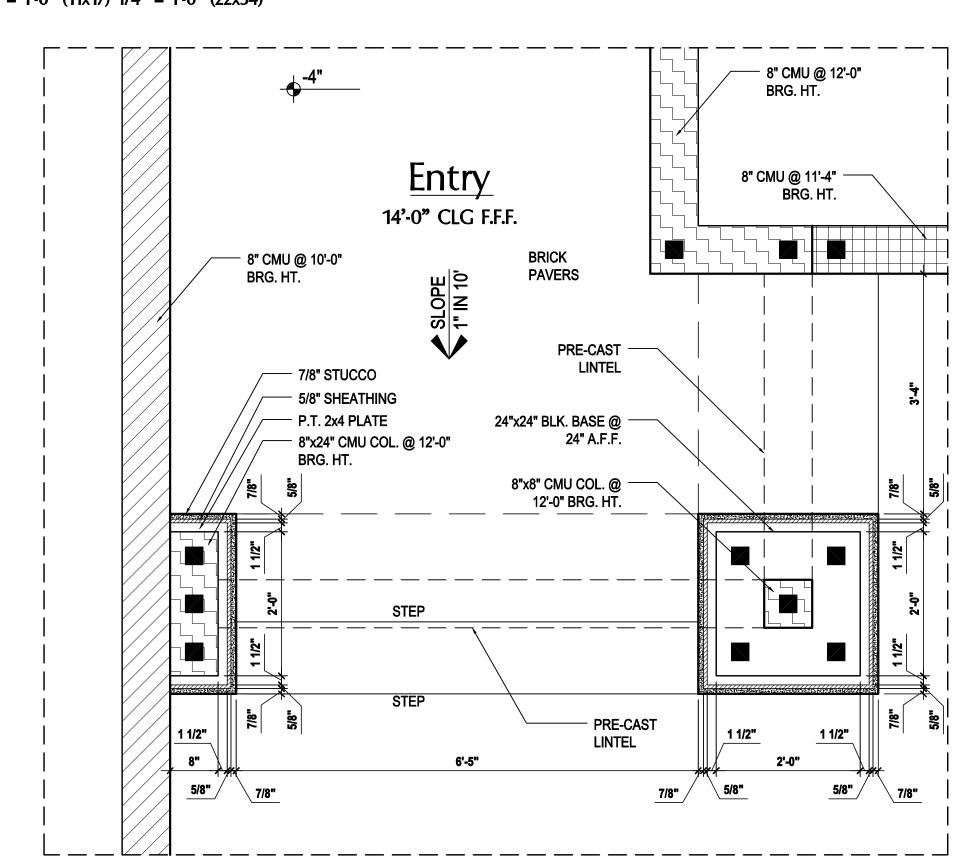

GENERAL NOTES KEY:

THIS STRUCTURE HAS BEEN DESIGNED TO MEET OR EXCEED THE (2020) FLORIDA BUILDING CODE (7TH EDITION)

2- # OF DOORS.

 SH - SINGLE HUNG 2- # OF WINDOWS. DH - DOUBLE HUNG MT - METAL THRESHOLD • HR - HORIZONTAL FR - FRENCH DOORS

SL - SIDE LIGHT BP - BYPASS FG - FIXED GLASS BF - BIFOLD

 TYP. - TYPICAL GB - GLASS BLOCK PKT - POCKET DOOR SPECIALTY WINDOWS/DOOR OBS - OBSCURED GLASS FIXED GLASS WINDOWS, AND TRANSOMS ARE NOTED ON

FLOOR PLAN NOTES:

CONTRACTOR TO VERIFY ALL DIMENSIONS ON JOB SITE.

DO NOT SCALE PRINTS! CONSTRUCTION TO BE FROM CALCULATED DIMENSIONS ONLY. ANY DISCREPANCIES OR ERRORS TO BE REPORTED PROMPTLY TO SUPERVISOR FOR CLARIFICATION.

MECHANICAL EQUIP. LOCATIONS WILL BE DETERMINED BY COMMUNITY AND COUNTY CODES.

A/C CONDENSER UNIT TO BE ANCHORED TO SLAB PER CODE M307.2

PROVIDE RECESS H&C WATER w/ DRAIN @ WASHER SPACE. VENT DRYER THRU EXTERIOR WALL U.N.O.

PROVIDE COLD WATER LINE FOR ICE MAKER LINE @ REF. SPACE.

SAG RESISTANT DRYWALL ON ALL CEILINGS.

PULL ALL DIMENSIONS FROM THE REAR OF PLAN.

REFER TO EXTERIOR ELEVATIONS & TYP. DETAIL SHEETS FOR

REFER TO DETAIL SHEETS FOR FLASHING REQUIREMENTS AT ALL WOOD TO MASONRY INTERFACES.

. ALL INTERIOR FRAME WALL DIMENSIONS TO BE 3 1/2", U.N.O.

. ALL EXTERIOR BLOCK WALL DIMENSIONS TO BE 7 1/2", U.N.O.

4. ALL INT. FIRST FLOOR CEILINGS AT 9'-4" U.N.O.
 •• ALL INT. SECOND FLOOR CEILINGS AT 9'-0" U.N.O.

. C.M.U. & FRAME WALL SYSTEM SEGMENTS WHICH HAVE AN UNINTERRUPTED LENGTH OF 12'-0" OR MORE SHALL BE CONSIDERED SHEAR WALL SWS = SHEAR WALL SEGMENTS.

OPENING BETWEEN GARAGE AND RESIDENCE SHALL BE EQUIPPED w/ A 20 MIN. FIRE RATED SOLID WOOD OR HONEYCOMB CORE STE DOOR NOT LESS THAN 1 3/8" THICKNESS AS PER FBC-R302.5.1.

INSTALL 5/8" TYPE X DRYWALL ON GARAGE CEILING BENEATH HABITABLE ROOMS (TYP.)

GARAGE DOOR TO BE CERTIFIED BY MFR. FOR 140 M.P.H., U.N.O ALL TUB & SHOWER UNITS WILL HAVE ANTI-SCALDING DEVICES

1/2" GYPSUM BOARDS APPLIED TO THE UNDER STAIR SURFACE AND

ALL OPERABLE WINDOWS LOCATED MORE THAN 72" ABV. SURFACE BELOW SHALL HAVE THE LOWEST PORTION OF WINDOW CLEAR OPENING A MIN. OF 24" ABOVE FINISHED FLOOR BEING SERVER PER

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DOOR NOTE KEY:

DOOR SIZE CALLOUT: 20 = 2'-0" 28 = 2'-8" 30 = 3'-0" 24 = 2'-4" 26 = 2'-6"

40 B.F. = 4'-0" BI-FOLD 50 B.F. = 5'-0" BI-FOLD 60 B.F. = 6'-0" BI-FOLD

WINDOW NOTE KEY:

WINDOW SIZE CALLOUT: 2040 = 2'-0" x 4'-0" ALL WINDOW CALLOUT ARE MEASURED IN FEET 2050 = 2'-0" x 5'-0" & INCHES AS PER THE 2060 = 2'-0" x 6'-0" EXAMPLE TABLE ABOVE

(Standard)

SCALE: 1/8" = 1'-0" (11x17) 1/4" = 1'-0" (22x34)

Living: 1,838 sf 1st floor: 2nd floor: 1,204 s Total Living: 3,042 s 84 sf Cov. Patio: 140 sf 408 sf Garage: Total Area: 3,674 sf

Area Tabulations







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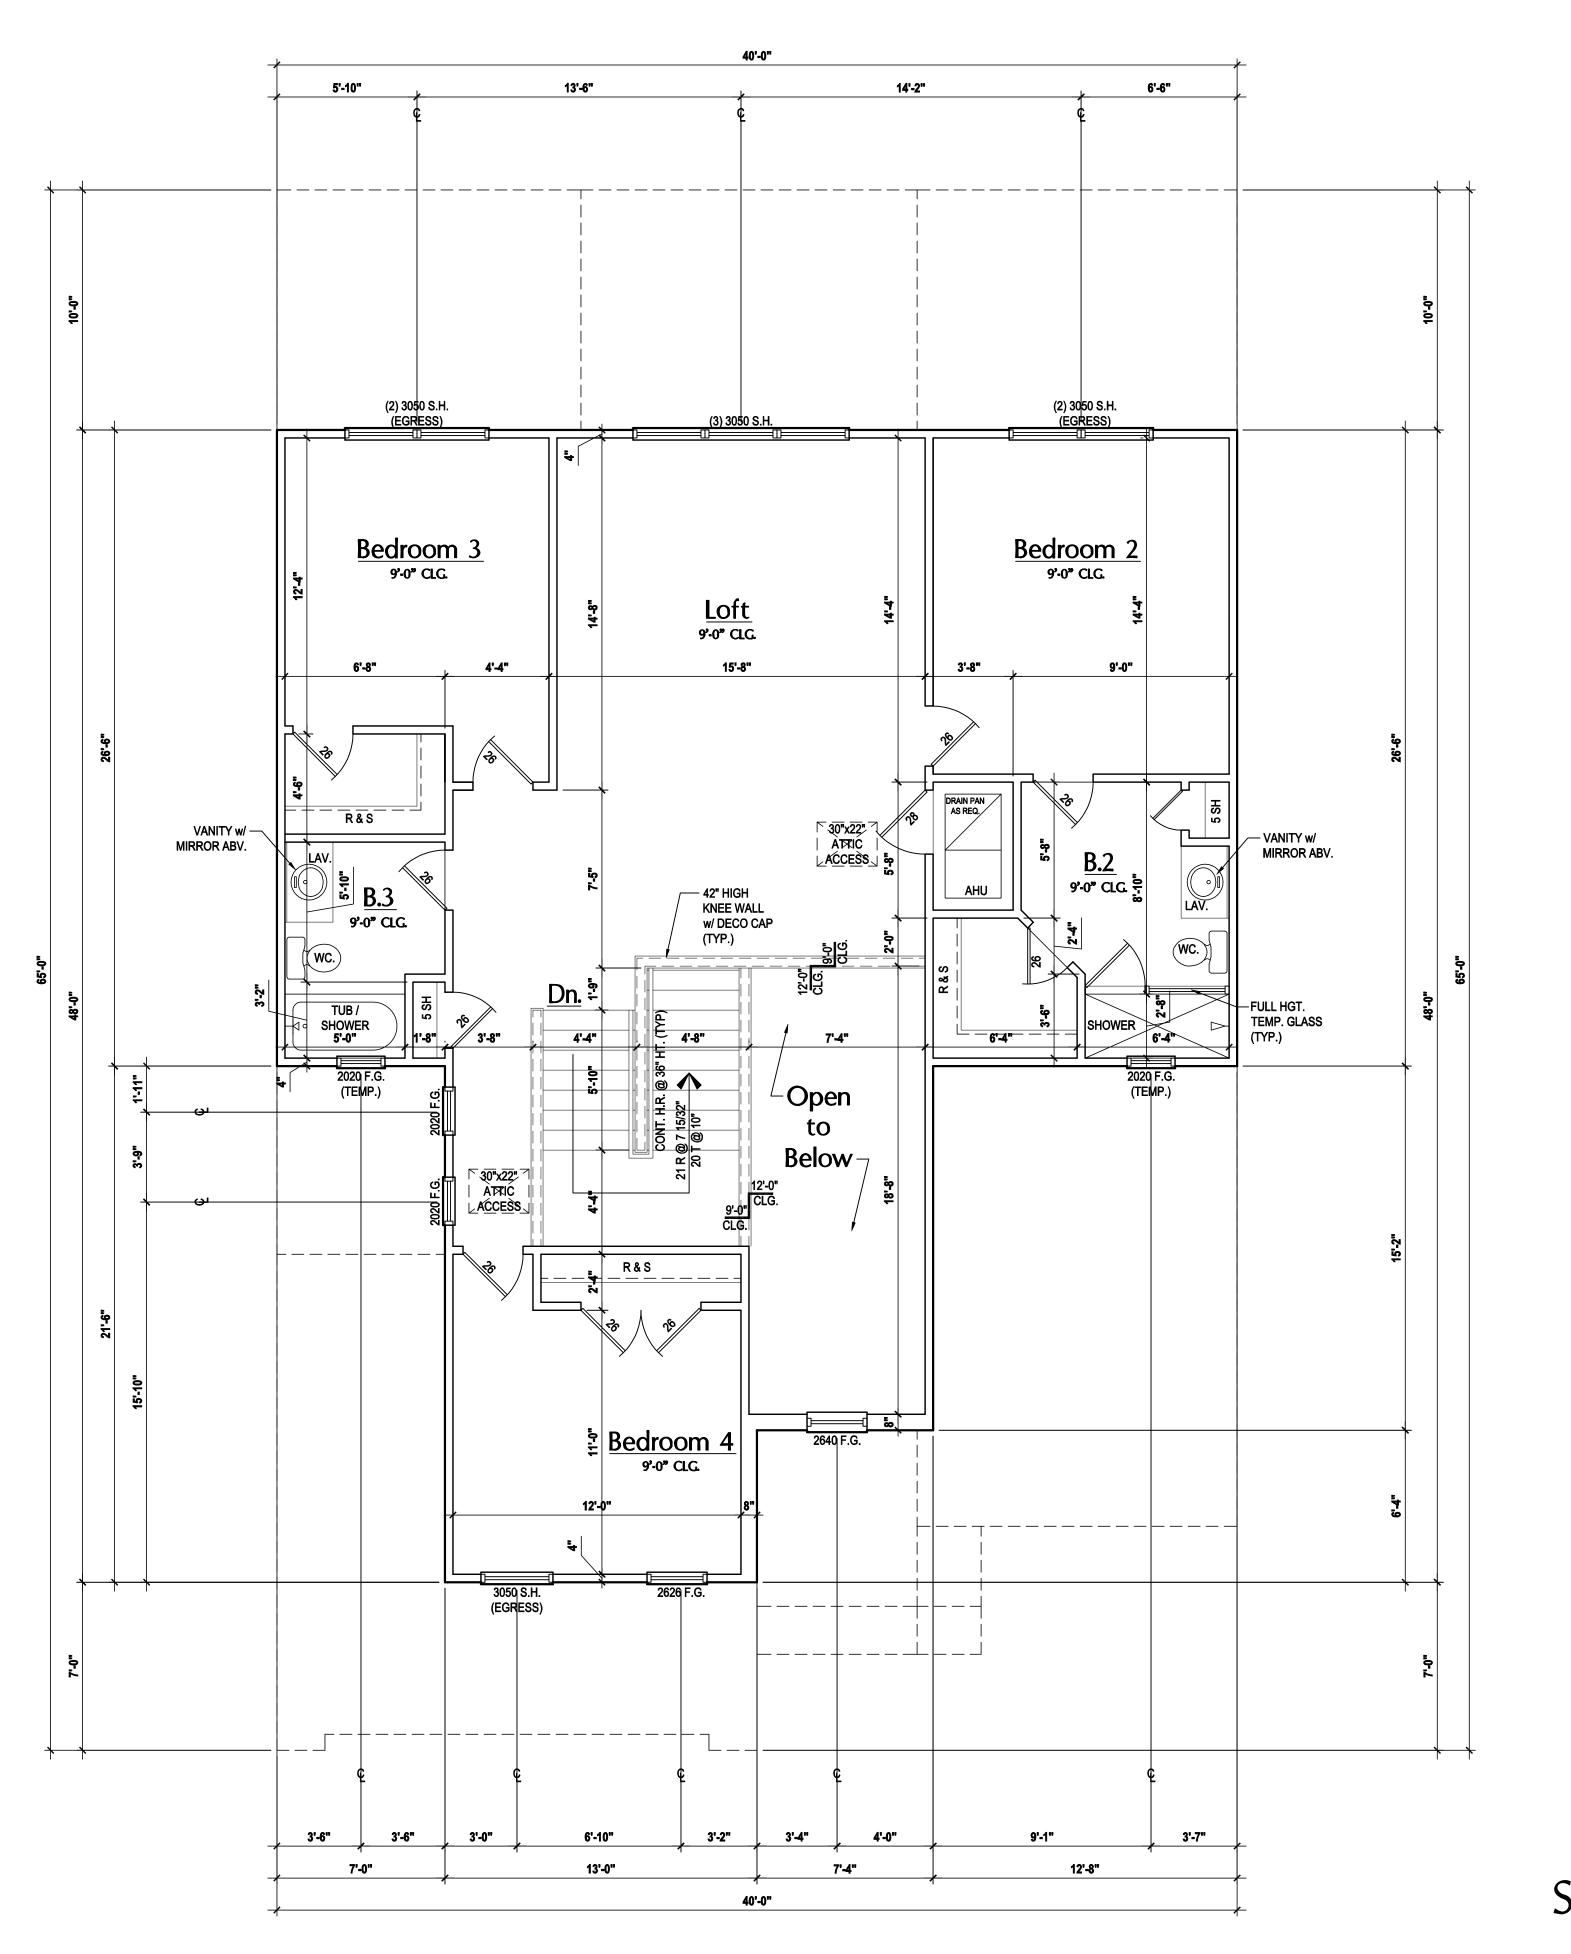
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REVISIONS

PROJECT: 22-0000 SCALE: AS NOTED DRAWN BY: M.C.

FLOOR PLAN



THIS STRUCTURE HAS BEEN DESIGNED TO MEET OR EXCEE THE (2020) FLORIDA BUILDING CODE (7TH EDITION)

BBREVIATIONS:
2- # OF DOORS.
2- # OF WINDOWS.
4- GLASS
5H - SINGLE HUNG
0H - DOUBLE HUNG

2- # OF WINDOWS.
 MT - METAL THRESHOLD
 FR - FRENCH DOORS
 SL - SIDE LIGHT
 FG - FIXED GLASS
 BF - BIFOLD
 TYP TYPICAL

FG - FIXED GLASS
TR - TRANSOM
GB - GLASS BLOCK
PKT - POCKET DOOR

• BF - BIFOLD
• TYP. - TYPICAL
NOTE:
SPECIALTY WINDOWS/DOORS

OBS - OBSCURED GLASS FIXED GLASS WINDOWS, AND TEMP - TEMPERED TRANSOMS ARE NOTED ON PLANS.

FLOOR PLAN NOTES:

NOTES:

1. CONTRACTOR TO VERIFY ALL DIMENSIONS ON JOB SITE.

2. <u>DO NOT SCALE PRINTS!</u> CONSTRUCTION TO BE FROM CALCULATED DIMENSIONS ONLY. ANY DISCREPANCIES OR ERRORS TO BE REPORTED PROMPTLY TO SUPERVISOR FOR CLARIFICATION.

MECHANICAL EQUIP. LOCATIONS WILL BE DETERMINED BY COMMUNITY AND COUNTY CODES.

I. A/C CONDENSER UNIT TO BE ANCHORED TO SLAB PER CODE M307.

PROVIDE RECESS H&C WATER w/ DRAIN @ WASHER SPACE.

PROVIDE RECESS TIRE WATER WIDINAIN & WASHER

VENT DRYER THRU EXTERIOR WALL U.N.O.

PROVIDE COLD WATER LINE FOR ICE MAKER LINE @ REF. SPACE.

SAG RESISTANT DRYWALL ON ALL CEILINGS.

PULL ALL DIMENSIONS FROM THE REAR OF PLAN.

REFER TO EXTERIOR ELEVATIONS & TYP. DETAIL SHEETS FOR EXTERIOR WALL FINISH SPEC'S.

REFER TO DETAIL SHEETS FOR FLASHING REQUIREMENTS AT ALL WOOD TO MASONRY INTERFACES.

2. ALL INTERIOR FRAME WALL DIMENSIONS TO BE 3 1/2", U.N.O.

3. ALL EXTERIOR BLOCK WALL DIMENSIONS TO BE 7 1/2", U.N.O.

4. ALL INT. FIRST FLOOR CEILINGS AT 9'-4" U.N.O.
•• ALL INT. SECOND FLOOR CEILINGS AT 9'-0" U.N.O.

 C.M.U. & FRAME WALL SYSTEM SEGMENTS WHICH HAVE AN UNINTERRUPTED LENGTH OF 12'-0" OR MORE SHALL BE CONSIDERE

SHEAR WALL SWS = SHEAR WALL SEGMENTS.

16. OPENING BETWEEN GARAGE AND RESIDENCE SHALL BE EQUIPPED

W/ A 20 MIN. FIRE RATED SOLID WOOD OR HONEYCOMB CORE STEEL DOOR NOT LESS THAN 1 3/8" THICKNESS AS PER FBC-R302.5.1.

INSTALL 5/8" TYPE X DRYWALL ON GARAGE CEILING BENEATH HABITABLE ROOMS (TYP.)

B. GARAGE DOOR TO BE CERTIFIED BY MFR. FOR 140 M.P.H., U.N.O

ALL TUB & SHOWER UNITS WILL HAVE ANTI-SCALDING DEVICES

. 1/2" GYPSUM BOARDS APPLIED TO THE UNDER STAIR SURFACE AND

SIDES.

ALL OPERABLE WINDOWS LOCATED MORE THAN 72" ABV. SURFACE

BELOW SHALL HAVE THE LOWEST PORTION OF WINDOW CLEAR OPENING A MIN. OF 24" ABOVE FINISHED FLOOR BEING SERVER PE (FBC-R312.2).

2. SEE COLOR SHEET FOR INTERIOR DOOR HEIGHT REQUIREMENTS

 1/2" GYPSUM BOARD APPLIED TO THE GARAGE SIDE OF WALL TO UNDERSIDE OF DECKING.

UNDERSIDE OF DECKING.

24. ALL WINDOW AND DOOR ROUGH OPENINGS VARY PER
MANUFACTURER'S SPECIFICATIONS, AND ARE NOT REFLECTED O
THE PLANS. DIMENSIONS PROVIDED ON PLANS ARE USED FOR AN

MANUFACTURER'S SPECIFICATIONS, AND ARE NOT REFLECTED ON THE PLANS. DIMENSIONS PROVIDED ON PLANS ARE USED FOR AN APPROXIMATE LOCATION OF WINDOWS & DOORS, AND DO NOT REFLECT THE ROUGH OPENINGS REQUIRED FOR PROPER INSTALLATION. BUILDER WILL BE REQUIRED TO CROSS-REFERENCE ROUGH OPENINGS AND PLAN DIMENSIONS.

SOIL TESTING IS RECOMMENDED. THE DESIGN TEAM AT MJS & E.O.R STRONGLY RECOMMEND A SOIL TEST TO CONFIRM SOIL BEARING CAPACITY AND SURFACE GEO-TECHNICAL CONDITIONS. FOOTINGS SHALL BEAR ON UNDISTURBED SOIL A/O PROPERLY COMPACTED FILL (2000 PSF MIN.). FILL MATERIAL SHALL BE COMPACTED TO 95% DENSITY OF A STANDARD PROCTOR. TO BE VERIFIED BY GENERAL CONTRACTOR / OWNER.

DOOR NOTE KEY:

DOOR SIZE CALLOUT: 20 = 2'-0" 24 = 2'-4" 26 = 2'-6" 28 = 2'-8" 30 = 3'-0" 40 B.F. = 4'-0" BI-FOLD 50 B.F. = 5'-0" BI-FOLD 60 B.F. = 6'-0" BI-FOLD

WINDOW NOTE KEY:

WINDOW SIZE CALLOUT: 2040 = 2'-0" x 4'-0" 2050 = 2'-0" x 5'-0" 2060 = 2'-0" x 6'-0" ALL WINDOW CALLOUTS
ARE MEASURED IN FEET
& INCHES AS PER THE
EXAMPLE TABLE ABOVE



40-3042



A division of Park Square

GOBA

ISSUE DATE 03/27/2023
REVISIONS


PROJECT: 22-0000
SCALE: AS NOTED
DRAWN BY: M.C.
DESIGNED BY: MJS

FLOOR PLAN

A3.A Le

Second Floor Plan "A"

(Standard)

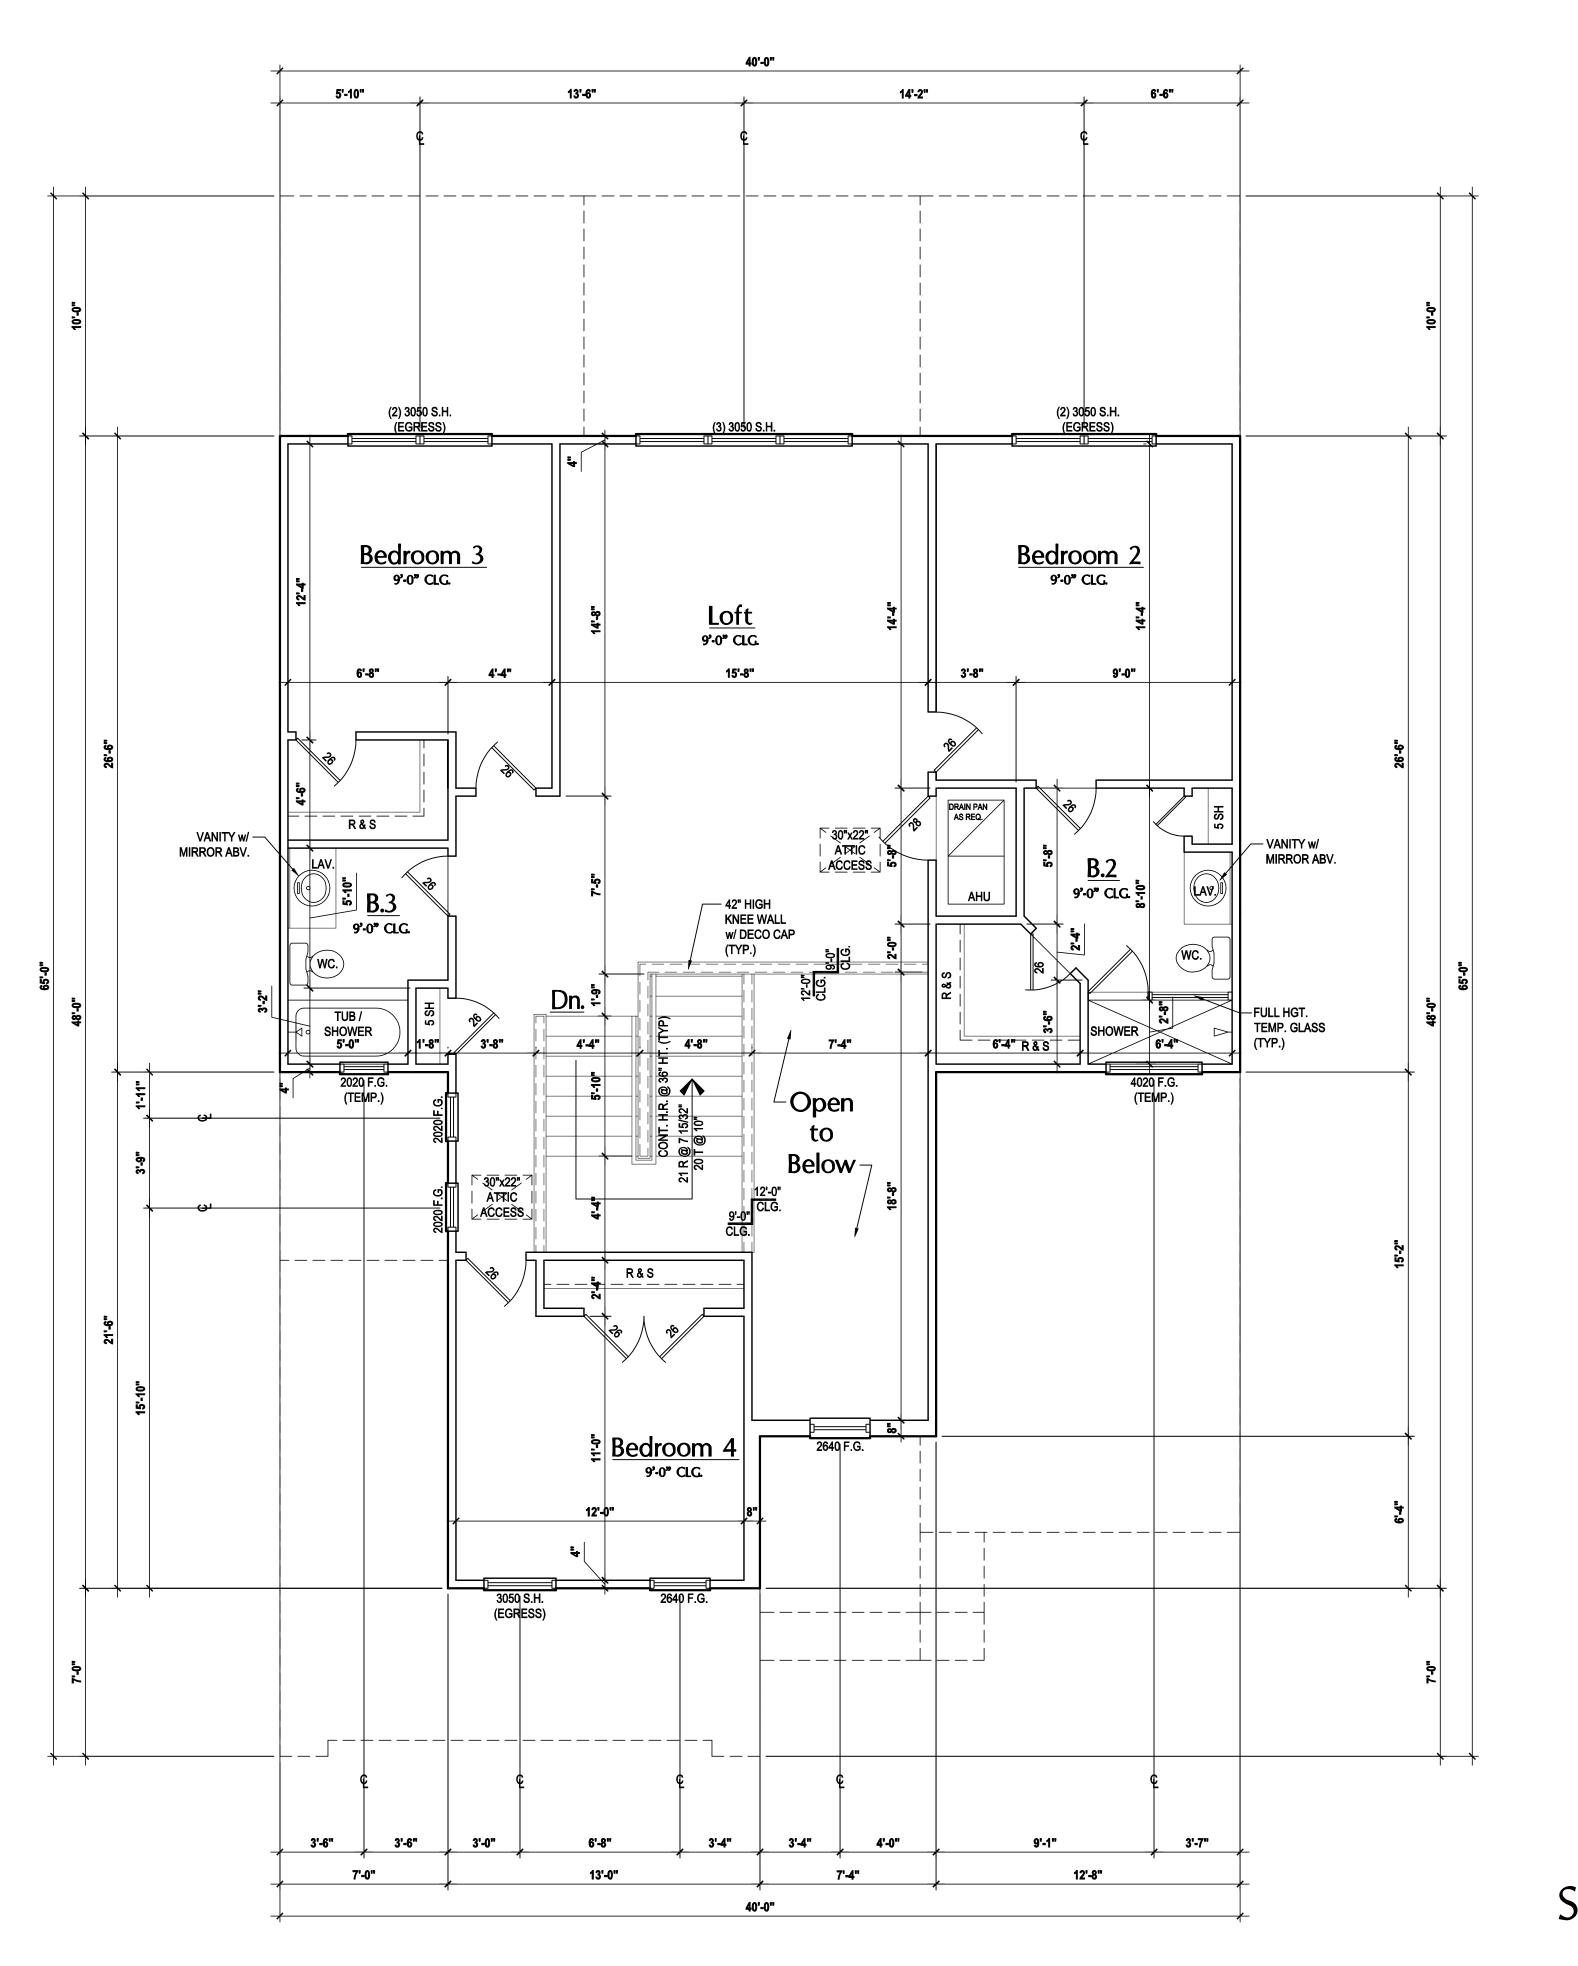

HIS STRUCTURE HAS BEEN DESIGNED TO MEET OR EXCEE THE (2020) FLORIDA BUILDING CODE (7TH EDITION)

 SH - SINGLE HUNG 2- # OF DOORS.

2- # OF WINDOWS. • DH - DOUBLE HUNG MT - METAL THRESHOLD • HR - HORIZONTAL FR - FRENCH DOORS SL - SIDE LIGHT BP - BYPASS FG - FIXED GLASS BF - BIFOLD

TR - TRANSOM TYP. - TYPICAL GB - GLASS BLOCK NOTE: PKT - POCKET DOOR SPECIALTY WINDOWS/DOORS

OBS - OBSCURED GLASS FIXED GLASS WINDOWS, AND TRANSOMS ARE NOTED ON

FLOOR PLAN NOTES:

CONTRACTOR TO VERIFY ALL DIMENSIONS ON JOB SITE.

TEMP - TEMPERED

DO NOT SCALE PRINTS! CONSTRUCTION TO BE FROM CALCULATED DIMENSIONS ONLY. ANY DISCREPANCIES OR ERRORS TO BE REPORTED PROMPTLY TO SUPERVISOR FOR CLARIFICATION.

MECHANICAL EQUIP. LOCATIONS WILL BE DETERMINED BY COMMUNITY AND COUNTY CODES.

A/C CONDENSER UNIT TO BE ANCHORED TO SLAB PER CODE M307.

PROVIDE RECESS H&C WATER w/ DRAIN @ WASHER SPACE.

VENT DRYER THRU EXTERIOR WALL U.N.O.

PROVIDE COLD WATER LINE FOR ICE MAKER LINE @ REF. SPACE.

SAG RESISTANT DRYWALL ON ALL CEILINGS.

PULL ALL DIMENSIONS FROM THE REAR OF PLAN.

REFER TO EXTERIOR ELEVATIONS & TYP. DETAIL SHEETS FOR EXTERIOR WALL FINISH SPEC'S. REFER TO DETAIL SHEETS FOR FLASHING REQUIREMENTS AT ALL

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2. ALL INTERIOR FRAME WALL DIMENSIONS TO BE 3 1/2", U.N.O. 3. ALL EXTERIOR BLOCK WALL DIMENSIONS TO BE 7 1/2", U.N.O.

4. ALL INT. FIRST FLOOR CEILINGS AT 9'-4" U.N.O.

•• ALL INT. SECOND FLOOR CEILINGS AT 9'-0" U.N.O.

5. C.M.U. & FRAME WALL SYSTEM SEGMENTS WHICH HAVE AN UNINTERRUPTED LENGTH OF 12'-0" OR MORE SHALL BE CONSIDERE SHEAR WALL SWS = SHEAR WALL SEGMENTS.

OPENING BETWEEN GARAGE AND RESIDENCE SHALL BE EQUIPPE w/ A 20 MIN. FIRE RATED SOLID WOOD OR HONEYCOMB CORE STEI DOOR NOT LESS THAN 1 3/8" THICKNESS AS PER FBC-R302.5.1.

INSTALL 5/8" TYPE X DRYWALL ON GARAGE CEILING BENEATH HABITABLE ROOMS (TYP.)

GARAGE DOOR TO BE CERTIFIED BY MFR. FOR 140 M.P.H., U.N.O

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1/2" GYPSUM BOARDS APPLIED TO THE UNDER STAIR SURFACE AN ALL OPERABLE WINDOWS LOCATED MORE THAN 72" ABV. SURFACE

BELOW SHALL HAVE THE LOWEST PORTION OF WINDOW CLEAR OPENING A MIN. OF 24" ABOVE FINISHED FLOOR BEING SERVER PE

2. SEE COLOR SHEET FOR INTERIOR DOOR HEIGHT REQUIREMENTS

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UNDERSIDE OF DECKING. 24. ALL WINDOW AND DOOR ROUGH OPENINGS VARY PER MANUFACTURER'S SPECIFICATIONS, AND ARE NOT REFLECTED O

APPROXIMATE LOCATION OF WINDOWS & DOORS, AND DO NOT REFLECT THE ROUGH OPENINGS REQUIRED FOR PROPER INSTALLATION. BUILDER WILL BE REQUIRED TO CROSS-REFERENCE ROUGH OPENINGS AND PLAN DIMENSIONS.

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DOOR NOTE KEY:

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WINDOW NOTE KEY:

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SANIBEL A division of Park Square Enterprises Inc. 200 Vineland Rd. Suite #200

40-3042



GOBA


ISSUE DATE | 03/27/2023 **REVISIONS**

PROJECT: 22-0000 SCALE: AS NOTED DRAWN BY: M.C. DESIGNED BY: MJS

> FLOOR PLAN A3.B Le

Second Floor Plan "B"

(Standard)

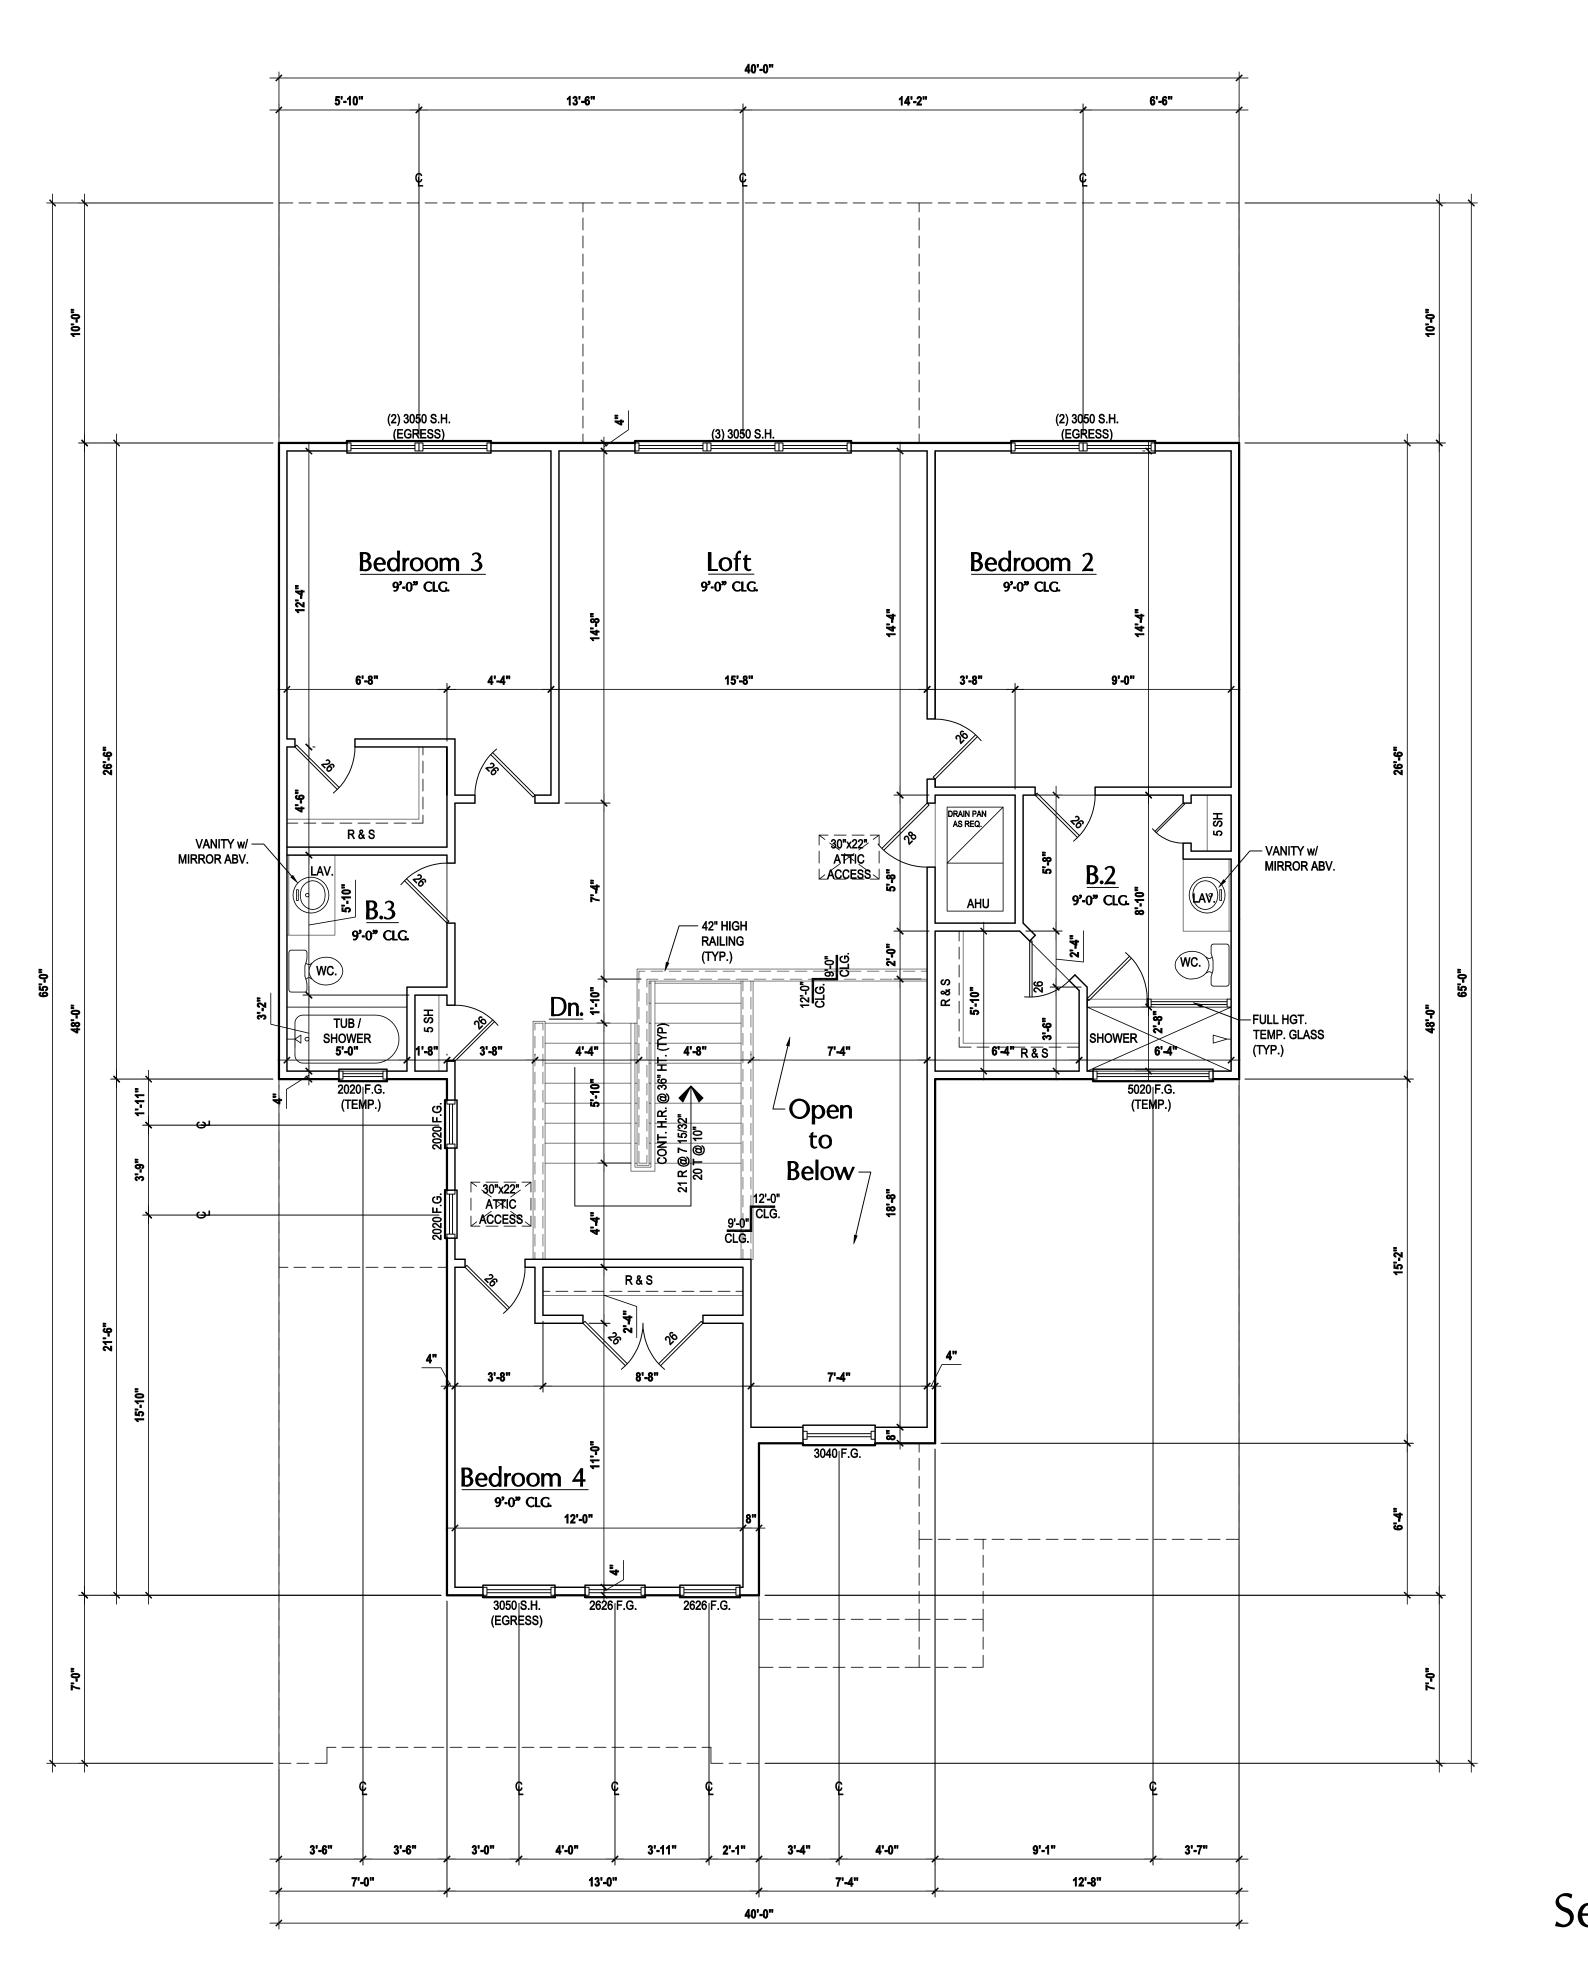

HIS STRUCTURE HAS BEEN DESIGNED TO MEET OR EXCEE THE (2020) FLORIDA BUILDING CODE (7TH EDITION)

 SH - SINGLE HUNG 2- # OF DOORS. 2- # OF WINDOWS. DH - DOUBLE HUNG

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REFER TO DETAIL SHEETS FOR FLASHING REQUIREMENTS AT ALL WOOD TO MASONRY INTERFACES.

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DOOR NOTE KEY:

DOOR SIZE CALLOUT: 24 = 2'-4" 26 = 2'-6"

CONTRACTOR / OWNER.

28 = 2'-8" 30 = 3'-0" 40 B.F. = 4'-0" BI-FOLD 50 B.F. = 5'-0" BI-FOLD 60 B.F. = 6'-0" BI-FOLD

WINDOW NOTE KEY:

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ALL WINDOW CALLOUT ARE MEASURED IN FEET & INCHES AS PER THE **EXAMPLE TABLE ABOVE**

ISSUE DATE | 03/27/2023 **REVISIONS**

PROJECT: 22-0000 SCALE: AS NOTED DRAWN BY: M.C. DESIGNED BY: MJS

FLOOR PLAN

Second Floor Plan "C"

(Standard)

SCALE: 1/8" = 1'-0" (11x17) 1/4" = 1'-0" (22x34)







SANIBEL (
Lot # - Comm
Street Addre
City, State. 2

A division of Park Square

Enterprises Inc.

200 Vineland Rd. Suite #200 Orlando, Fl. 32811 Phone: (407) 529-3000


40-3042



Front Elevation "A"

(Standard)

SCALE: 1/8" = 1'-0" (11x17) 1/4" = 1'-0" (22x34)

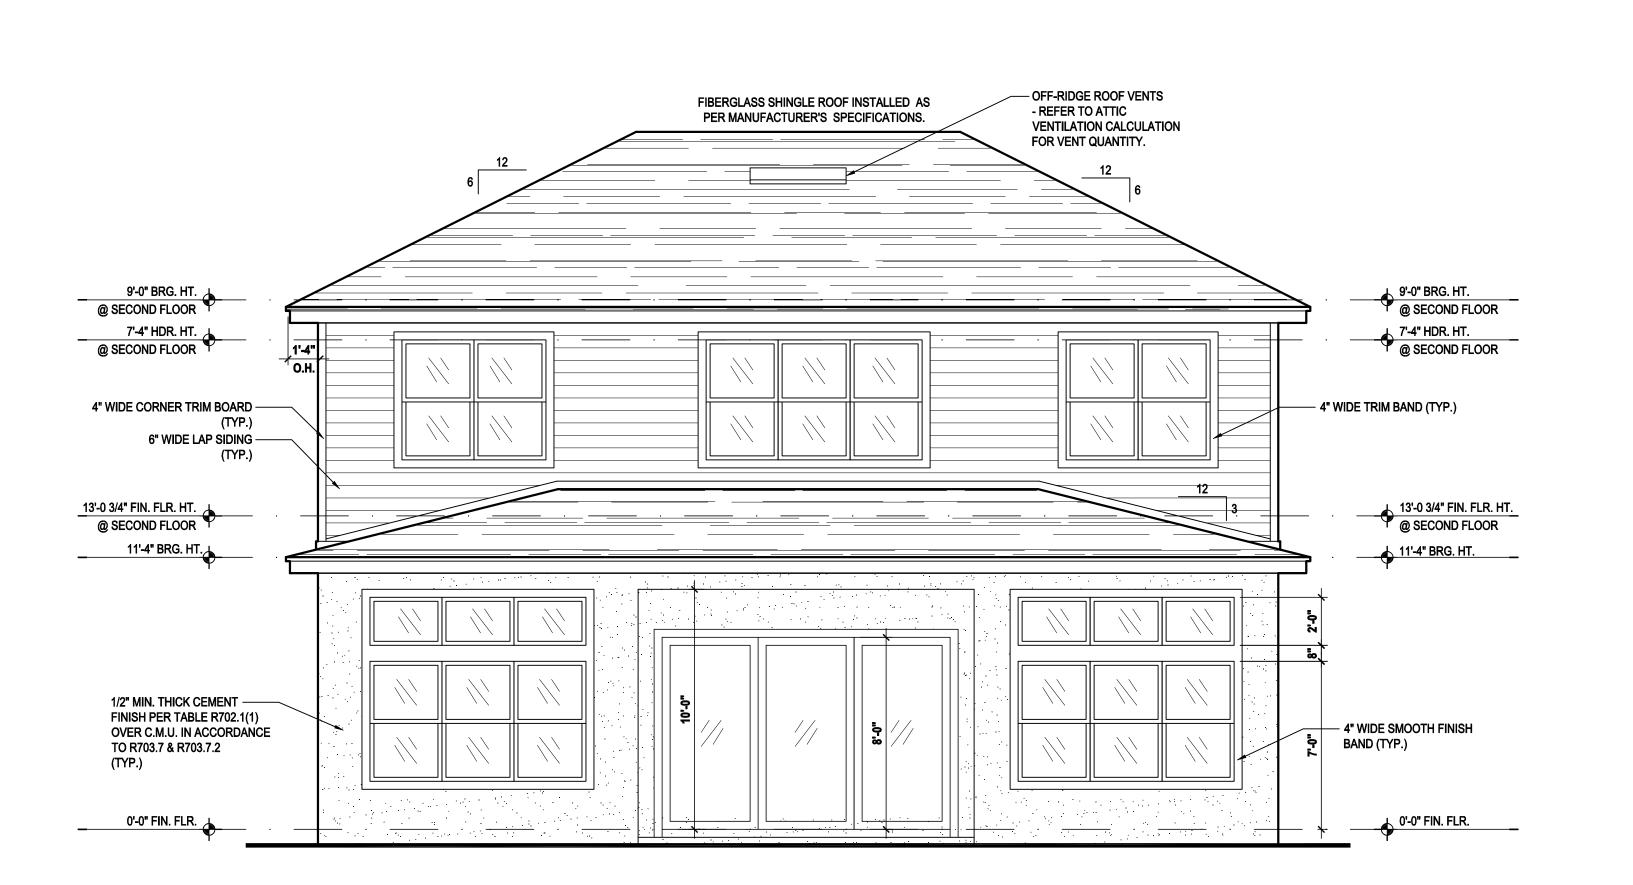

Rear Elevation "A"

(Standard)

SCALE: 1/8" = 1'-0" (11x17) 1/4" = 1'-0" (22x34)



2020 FLORIDA BUILDING CODE (7TH EDITION) SECTION R806
MIN. 40% - MAX 50% OF REQUIRED VENTILATION TO BE IN
UPPER PORTION OF ATTIC SPACE AND THE BALANCE TO BE
IN LOWER PORTION (EAVES).

(OFF-RIDGE VENT MAXIMUM OPENING SIZES)

MINIMUM NET VENTILATION AREA SHALL BE $\frac{1}{150}$ OF VENTED


TOTAL VENTED SPACE: $\frac{3,354}{300} = \frac{11.18 \text{ SF.}}{\text{REQUIRED}}$ NET FREE

UPPER PORTION VENTILATION TOTAL: 4.472 SF.
TO BE PROVIDED w/ OFF RIDGE VENTS:
6 VENTS @ .745 /PER VENT

 $\label{tile:ohagin model "S", Shingle: Lomanco 770-d)} \label{tile:ohagin model "S", Shingle: Lomanco 770-d)}.$

LOWER PORTION VENTILATION TOTAL: $\underline{6.708~SF.}$ TO BE PROVIDED w/ SOFFITS @ EAVE: $\underline{80.00~LF.}$ @ 0.083 SF. VENTING/LF

UPPER ROOF PERCENTAGE: 40% LOWER ROOF PERCENTAGE: 60%

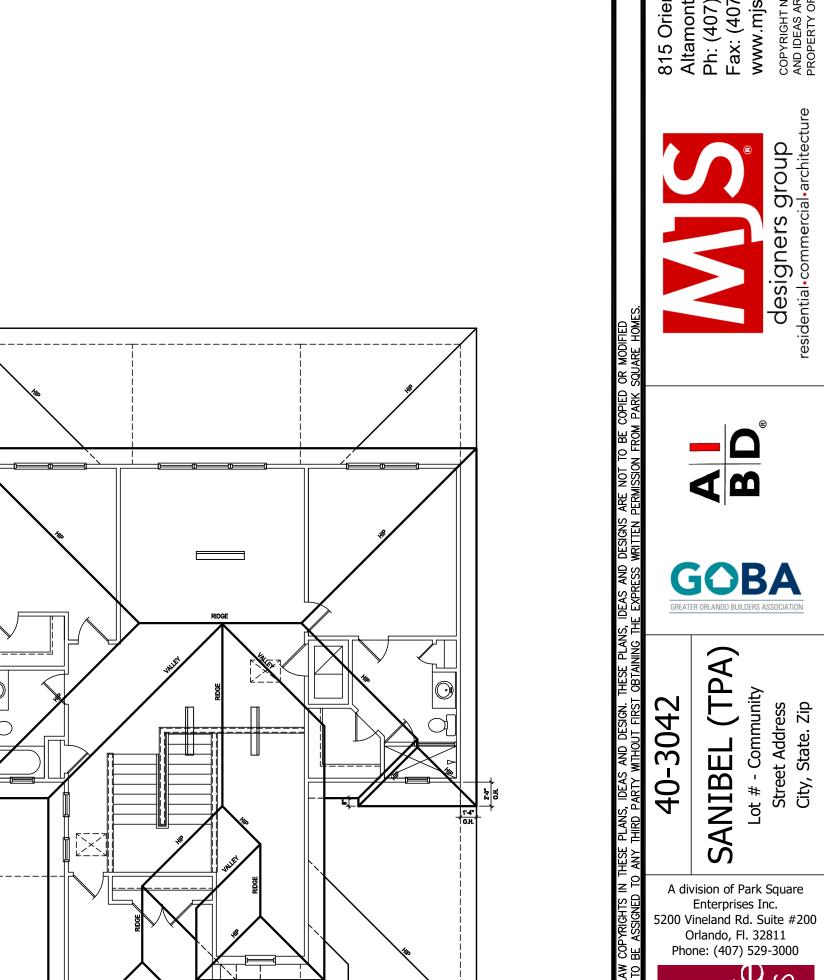

Roof Layout

SCALE: 1/16" = 1'-0" (11x17) 1/8" = 1'-0" (22x34)

PROJECT: 22-0000

SCALE: AS NOTED

DRAWN BY: M.C.

DESIGNED BY: MJS


FI EVATIONS "A"

ISSUE DATE 03/27/2023

REVISIONS


ELEVATIONS "A"

A4.A

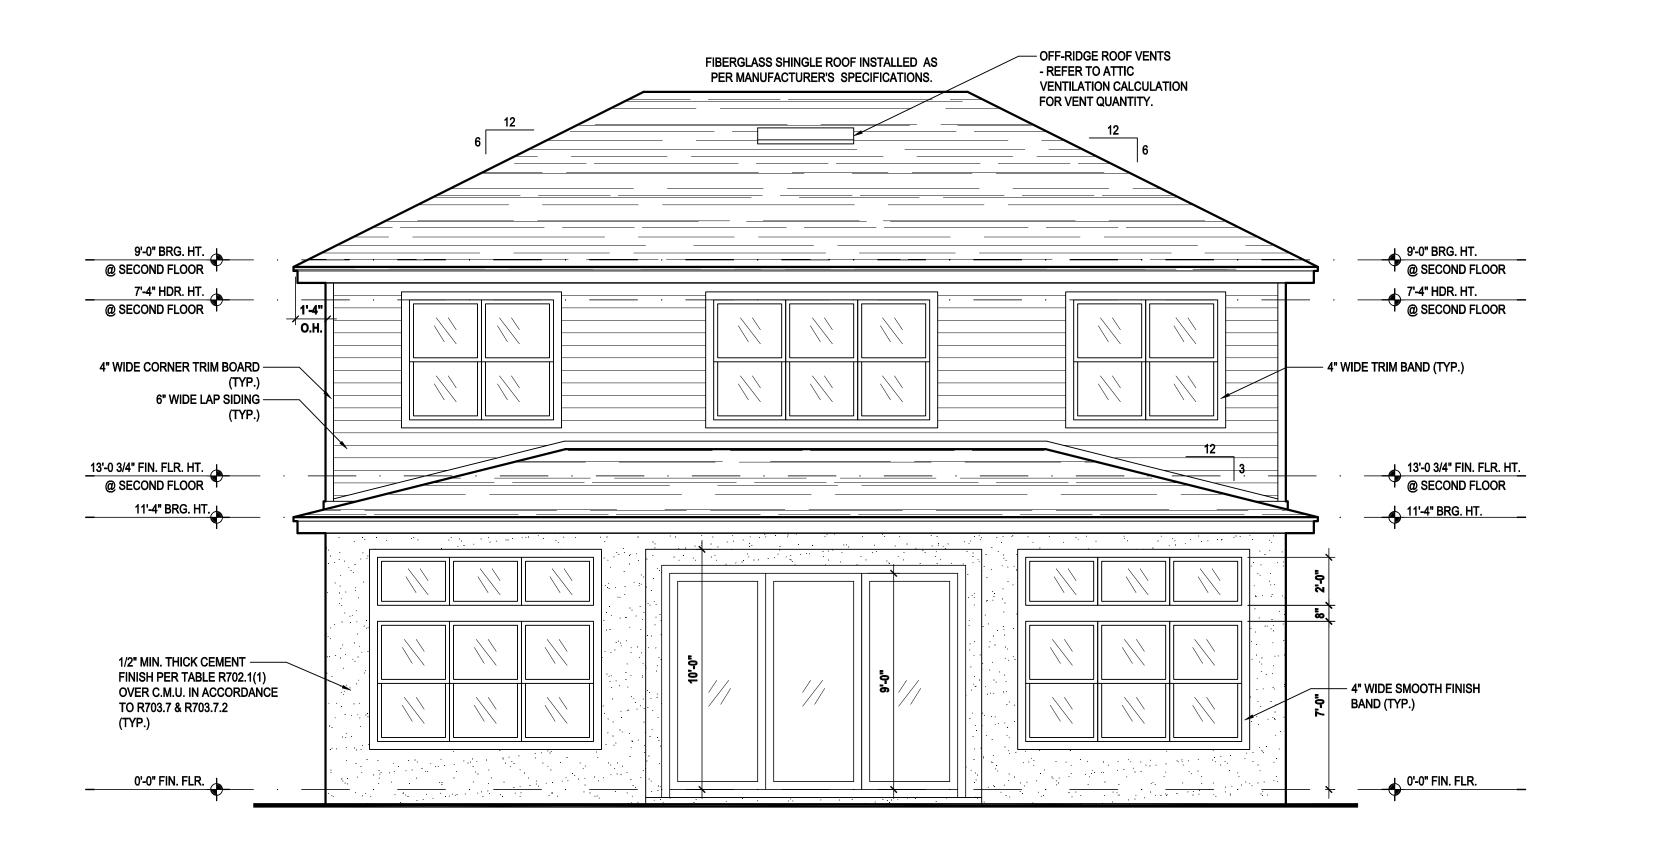

Rear Elevation "A"

(Opt. 9'-0" SGD.) SCALE: 1/8" = 1'-0" (11x17) 1/4" = 1'-0" (22x34)

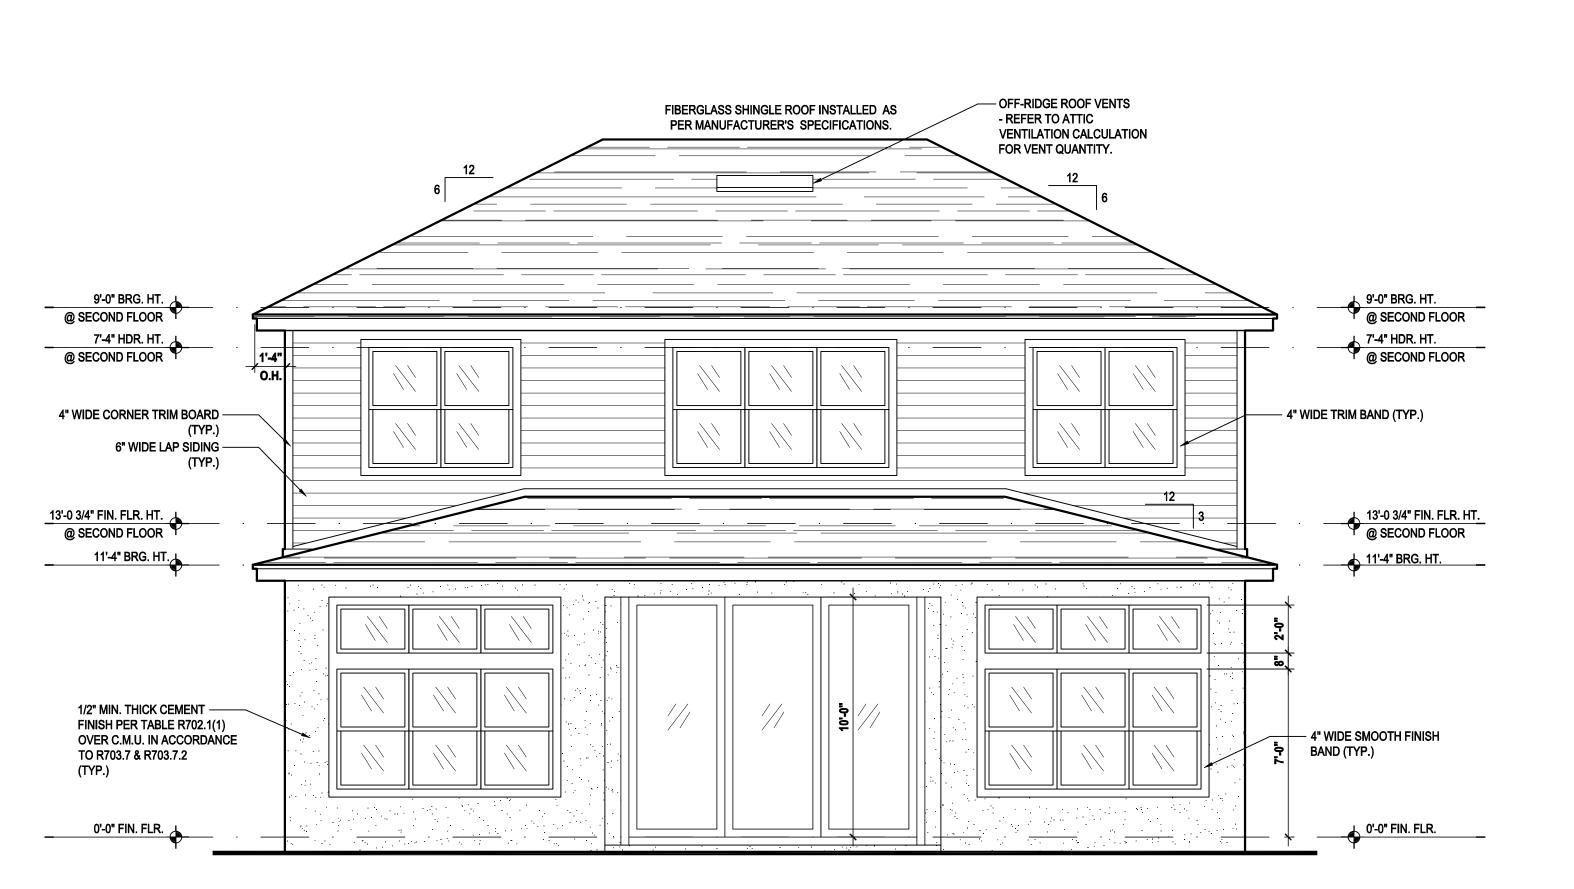

Rear Elevation "A"

(Opt. 10'-0" SGD.) SCALE: 1/8" = 1'-0" (11x17) 1/4" = 1'-0" (22x34)



2020 FLORIDA BUILDING CODE (7TH EDITION) SECTION R80 MIN. 40% - MAX 50% OF REQUIRED VENTILATION TO BE IN UPPER PORTION OF ATTIC SPACE AND THE BALANCE TO BE IN LOWER PORTION (EAVES).

(OFF-RIDGE VENT MAXIMUM OPENING SIZES)

MINIMUM NET VENTILATION AREA SHALL BE 150 OF VENTED


TOTAL VENTED SPACE: $\frac{3,354}{300} = \frac{11.18 \text{ SF.}}{\text{REQUIRED}}$

UPPER PORTION VENTILATION TOTAL: 4.472 SF.
TO BE PROVIDED w/ OFF RIDGE VENTS: 6 VENTS @ .745 /PER VENT

TILE: O'HAGIN MODEL "S", SHINGLE: LOMANCO 770-D).

LOWER PORTION VENTILATION TOTAL: 6.708 SF. TO BE PROVIDED w/ SOFFITS @ EAVE: 80.00 LF. @ 0.083 SF. VENTING/LF

UPPER ROOF PERCENTAGE: 40% LOWER ROOF PERCENTAGE: 60%

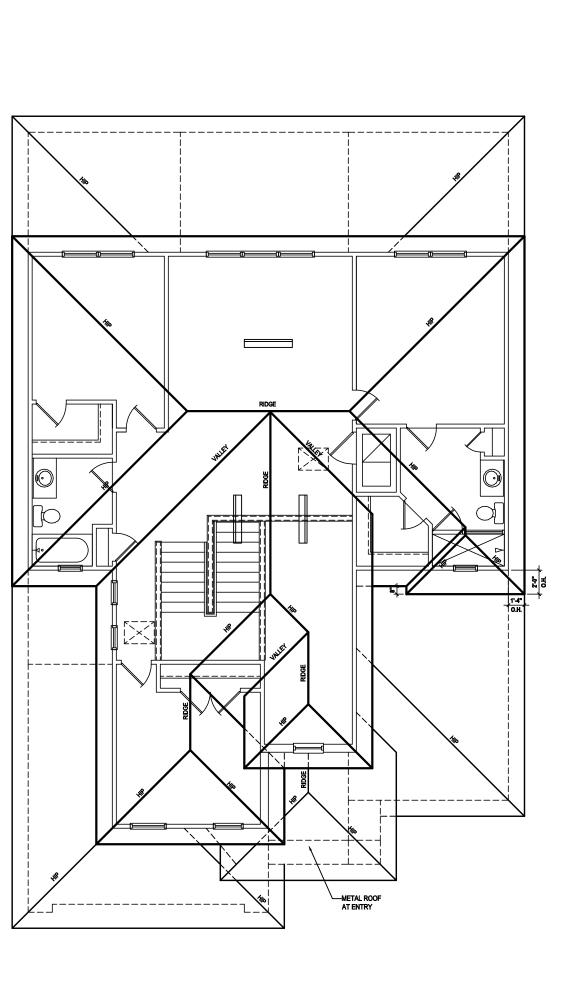

Roof Layout SCALE: 1/16" = 1'-0" (11x17) 1/8" = 1'-0" (22x34)





SANIBEL (TPA)

Lot # - Community

Street Address

City, State. Zip INS, IDEAS AND DESIGN. THE PARTY WITHOUT FIRST OF PARTY WITH FIRST OF PARTY WITH FIRST OF PARTY WITH FIRST OF PART


A division of Park Square Enterprises Inc. 5200 Vineland Rd. Suite #200 Orlando, Fl. 32811



ISSUE DATE 03/27/2023 **REVISIONS**

PROJECT: 22-0000 DRAWN BY: M.C.

DESIGNED BY: MJS **ELEVATIONS "A"**

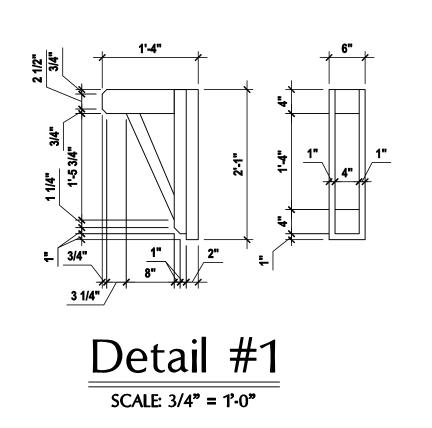




Front Elevation "B"

(Standard)

SCALE: 1/8" = 1'-0" (11x17) 1/4" = 1'-0" (22x34)

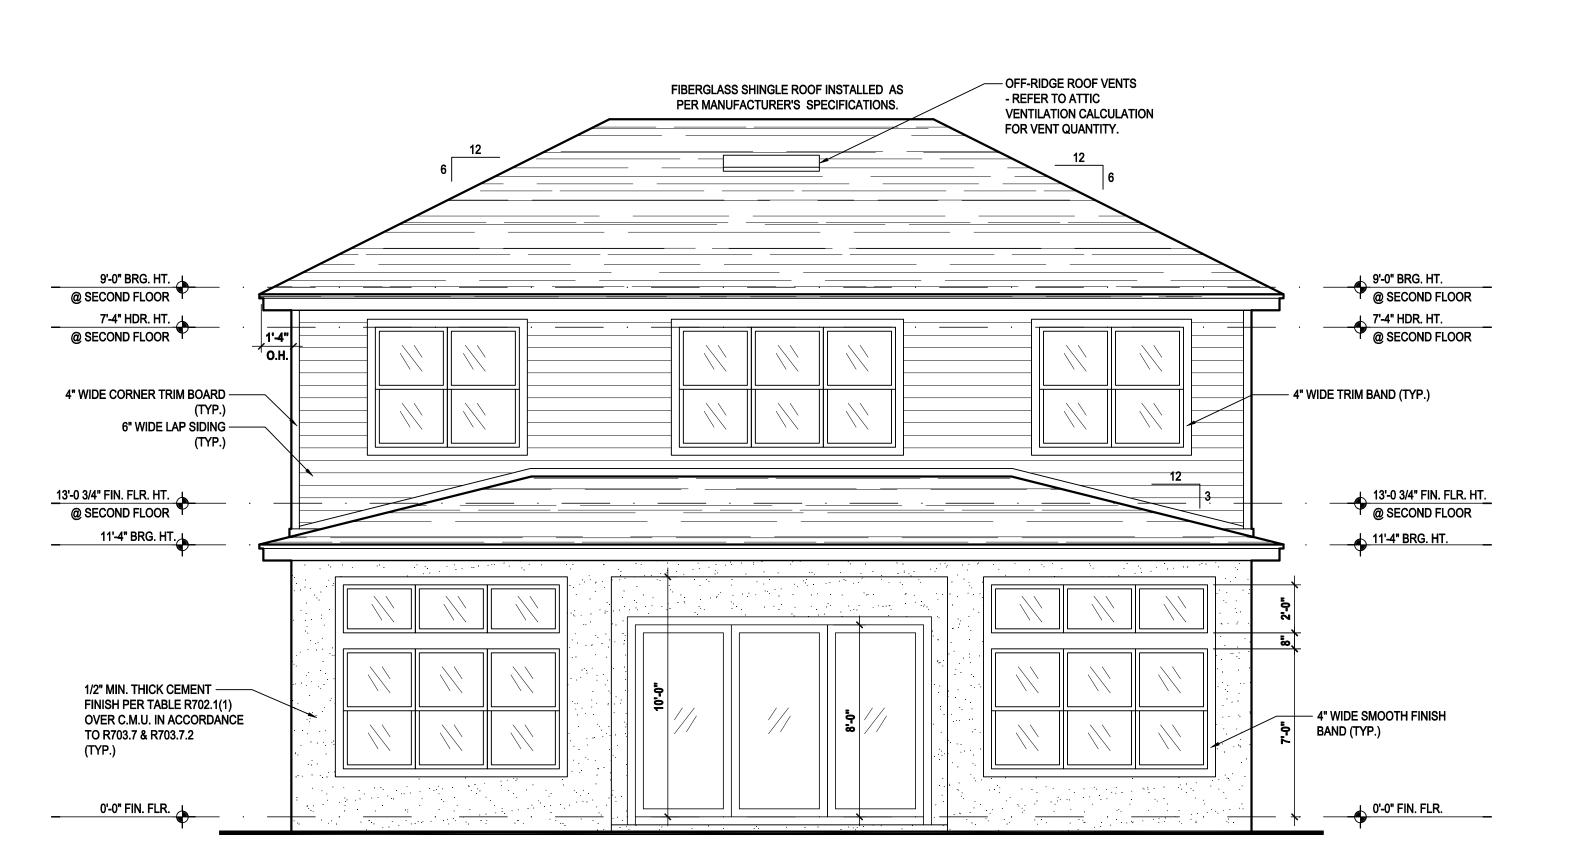

Rear Elevation "B"

(Standard)

SCALE: 1/8" = 1'-0" (11x17) 1/4" = 1'-0" (22x34)

ATTIC VENT CALC'S:

2020 FLORIDA BUILDING CODE (7TH EDITION) SECTION R806
MIN. 40% - MAX 50% OF REQUIRED VENTILATION TO BE IN
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IN LOWER PORTION (EAVES).
(OFF-RIDGE VENT MAXIMUM OPENING SIZES)

MINIMUM NET VENTILATION AREA SHALL BE 150 OF VENTED SPACE

SPACE.

TOTAL VENTED SPACE: $\frac{3,354}{300} = \frac{11.18 \text{ SF.}}{\text{REQUIRED}}$ NET FREE REQUIRED

UPPER PORTION VENTILATION TOTAL: 4.472 SF.
TO BE PROVIDED w/ OFF RIDGE VENTS:

TILE: O'HAGIN MODEL "S", SHINGLE: LOMANCO 770-D).

LOWER PORTION VENTILATION TOTAL: 6.708 SF.
TO BE PROVIDED w/ SOFFITS @ EAVE:
80.00 LF. @ 0.083 SF. VENTING/LF.

UPPER ROOF PERCENTAGE: 40% LOWER ROOF PERCENTAGE: 60%

Roof Layout

SCALE: 1/16" = 1'-0" (11x17) 1/8" = 1'-0" (22x34)

THOMPSON ENGINEERING GROUP, IN 4401 Vineland Road Suite A6 Orlando, FL. 32811

-6711

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-designs.com

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CALL RIGHTS RESERVED.

Ph: (407) 629-Ph: (407) 629-Fax: (407) 629www.mjshome PROPERTY NOTICE: 1 AND IDEAS ARE THE E PROPERTY OF MJS, IN







SANIBEL (TPA)

Lot # - Community

Street Address

City, State. Zip

A division of Park Square Enterprises Inc. 5200 Vineland Rd. Suite #200



ISSUE DATE 03/27/2023
REVISIONS

PROJECT: 22-0000
SCALE: AS NOTED
DRAWN BY: M.C.


DESIGNED BY: M.C.


DESIGNED BY: MJS

FLEVATIONS "B"

ELEVATIONS "B"


A4.B

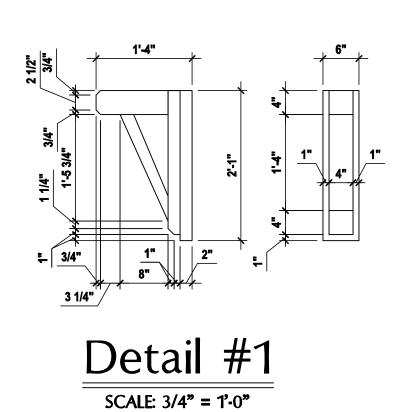

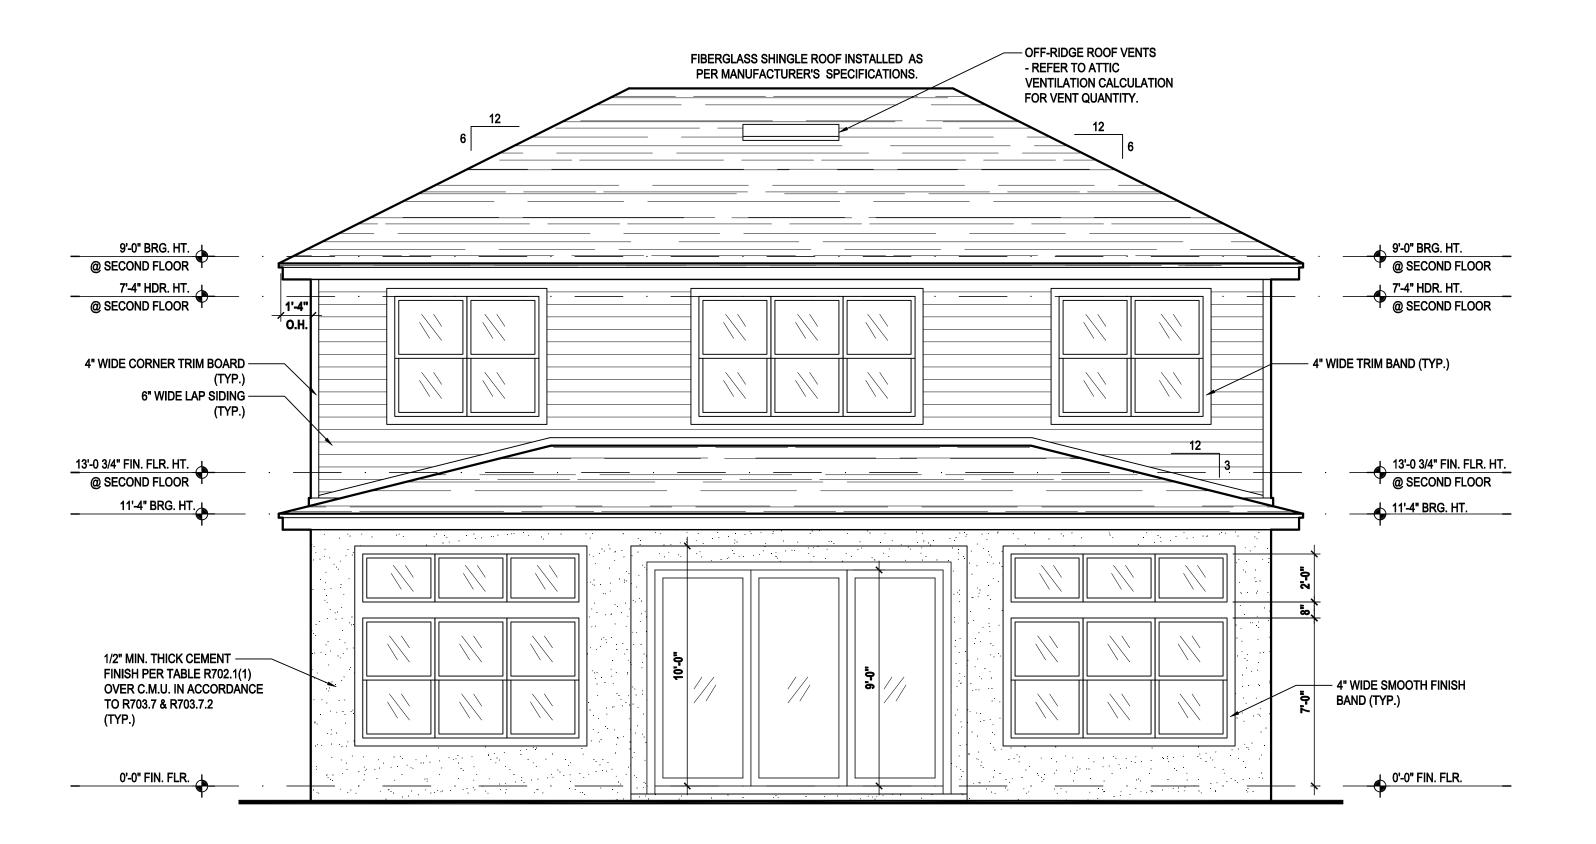

Rear Elevation "B"

(Opt. 9'-0" SGD.) SCALE: 1/8" = 1'-0" (11x17) 1/4" = 1'-0" (22x34)

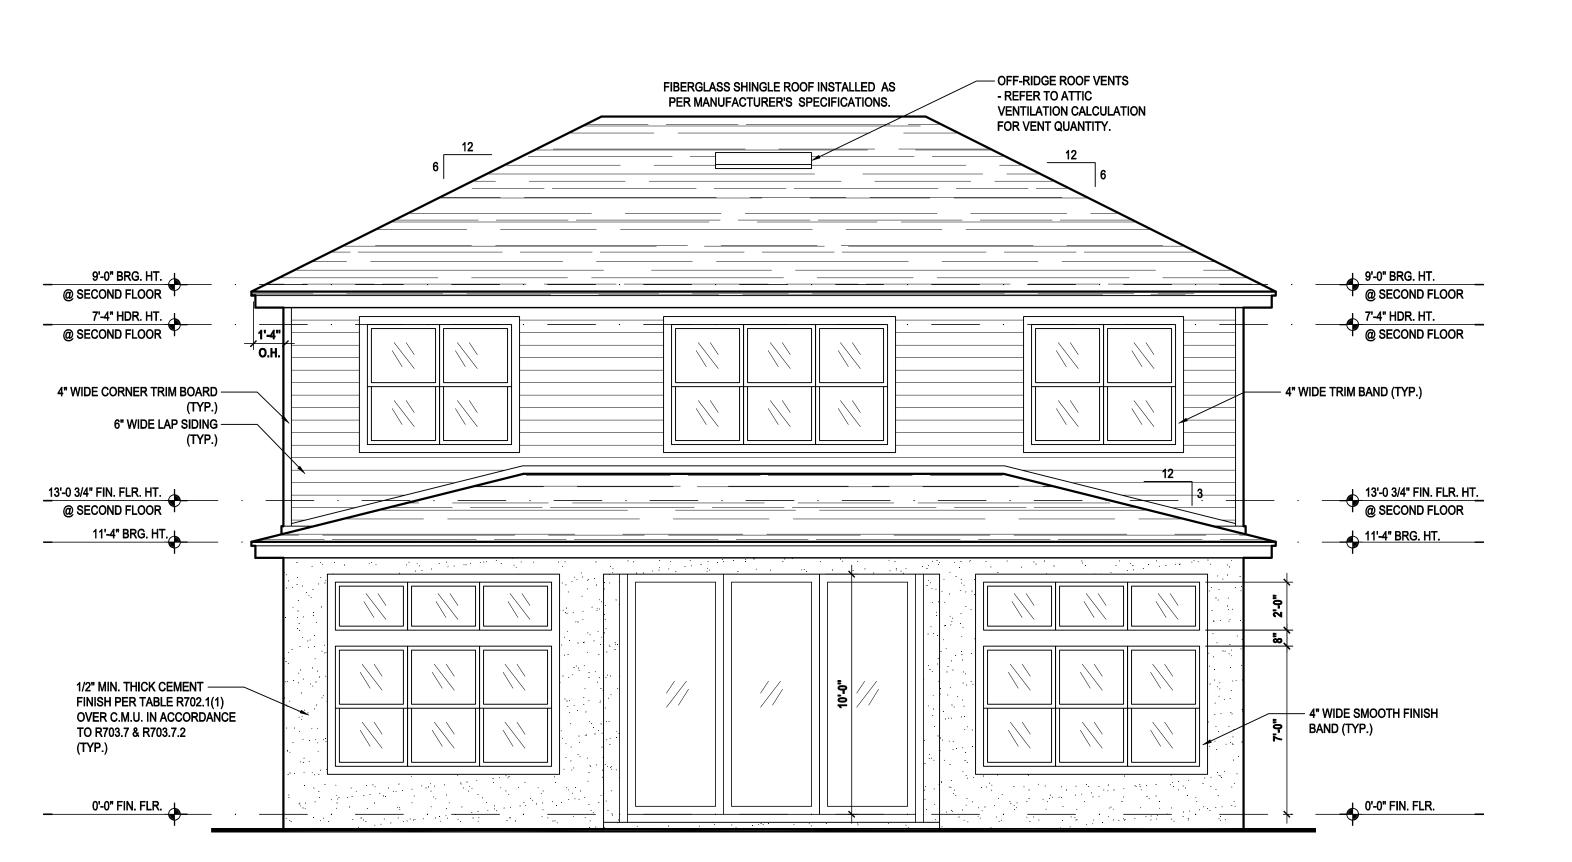

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2020 FLORIDA BUILDING CODE (7TH EDITION) SECTION R806 MIN. 40% - MAX 50% OF REQUIRED VENTILATION TO BE IN UPPER PORTION OF ATTIC SPACE AND THE BALANCE TO BE IN LOWER PORTION (EAVES). (OFF-RIDGE VENT MAXIMUM OPENING SIZES)

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TOTAL VENTED SPACE: $\frac{3,354}{300} = \frac{11.18 \text{ SF.}}{\text{REQUIRED}}$

UPPER PORTION VENTILATION TOTAL: 4.472 SF.
TO BE PROVIDED w/ OFF RIDGE VENTS:

6 VENTS @ .745 /PER VENT TILE: O'HAGIN MODEL "S", SHINGLE: LOMANCO 770-D).

LOWER PORTION VENTILATION TOTAL: <u>6.708 SF.</u>
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UPPER ROOF PERCENTAGE: 40% LOWER ROOF PERCENTAGE: 60%





SANIBEL (TPA)

Lot # - Community

Street Address

City, State. Zip


A division of Park Square Enterprises Inc. 5200 Vineland Rd. Suite #200 Orlando, Fl. 32811



ISSUE DATE | 03/27/2023 REVISIONS


PROJECT: 22-0000 SCALE: AS NOTED DRAWN BY: M.C.


DESIGNED BY: MJS **ELEVATIONS "B"** A4.B1

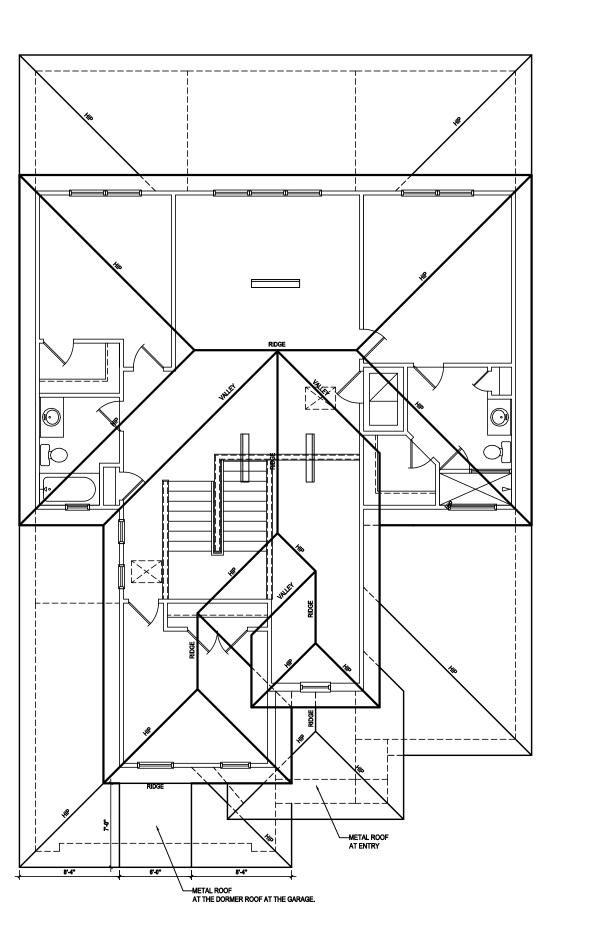

Roof Layout



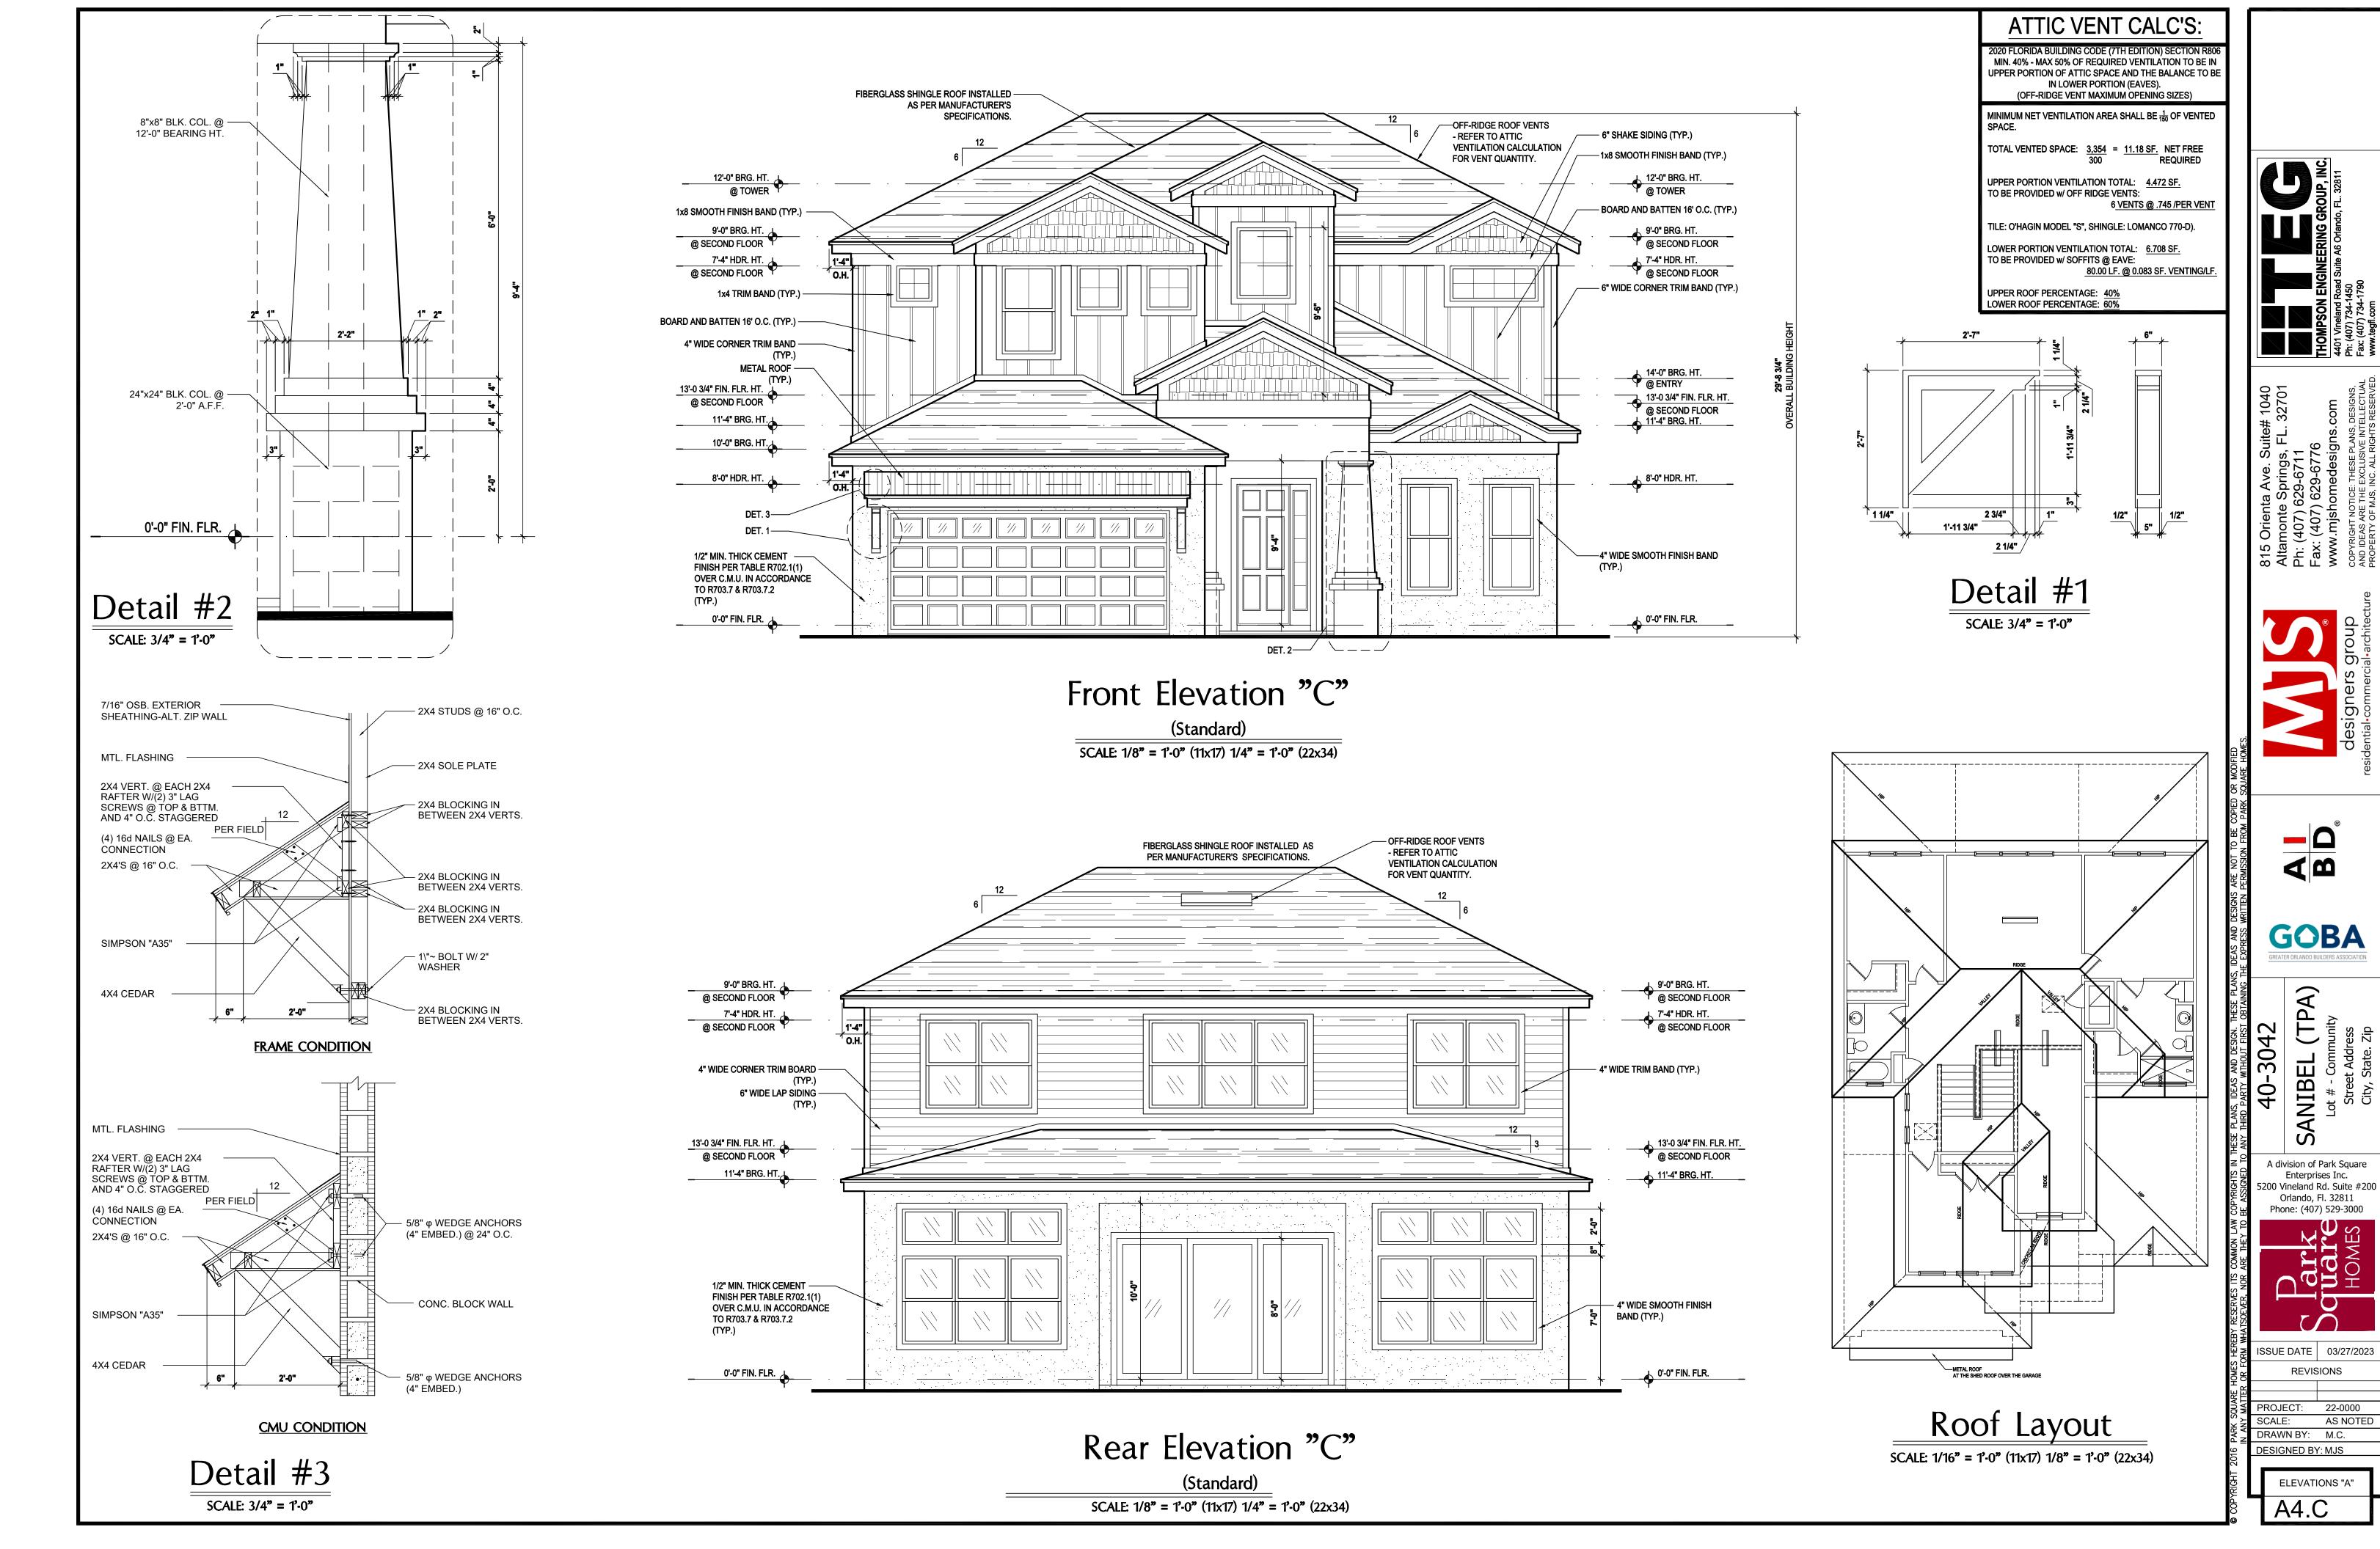


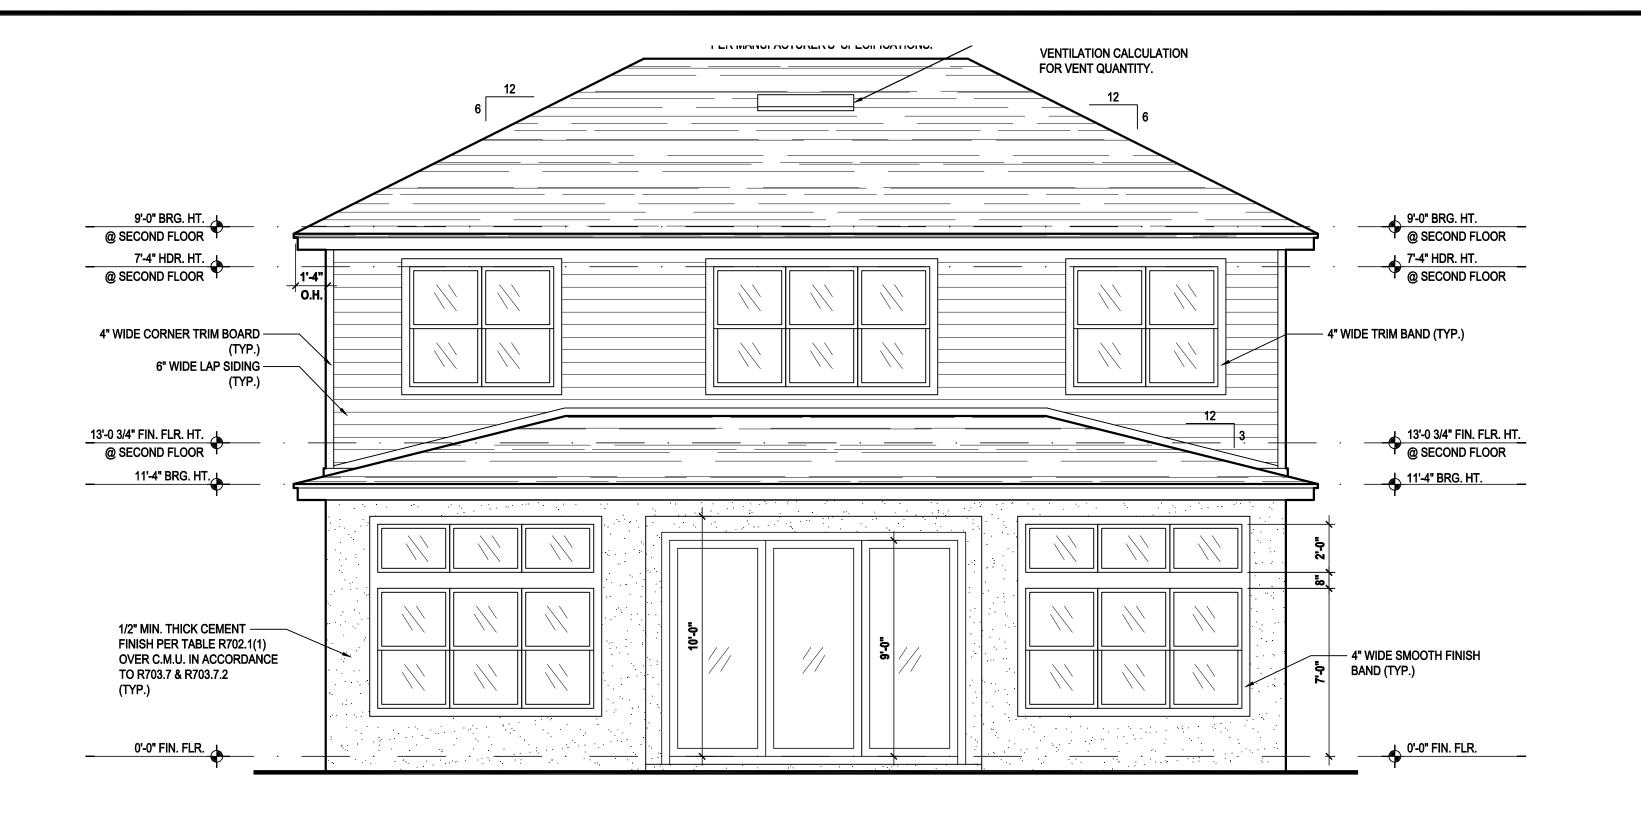

Rear Elevation "C"

(Opt. 9'-0" SGD)

SCALE: 1/8" = 1'-0" (11x17) 1/4" = 1'-0" (22x34)

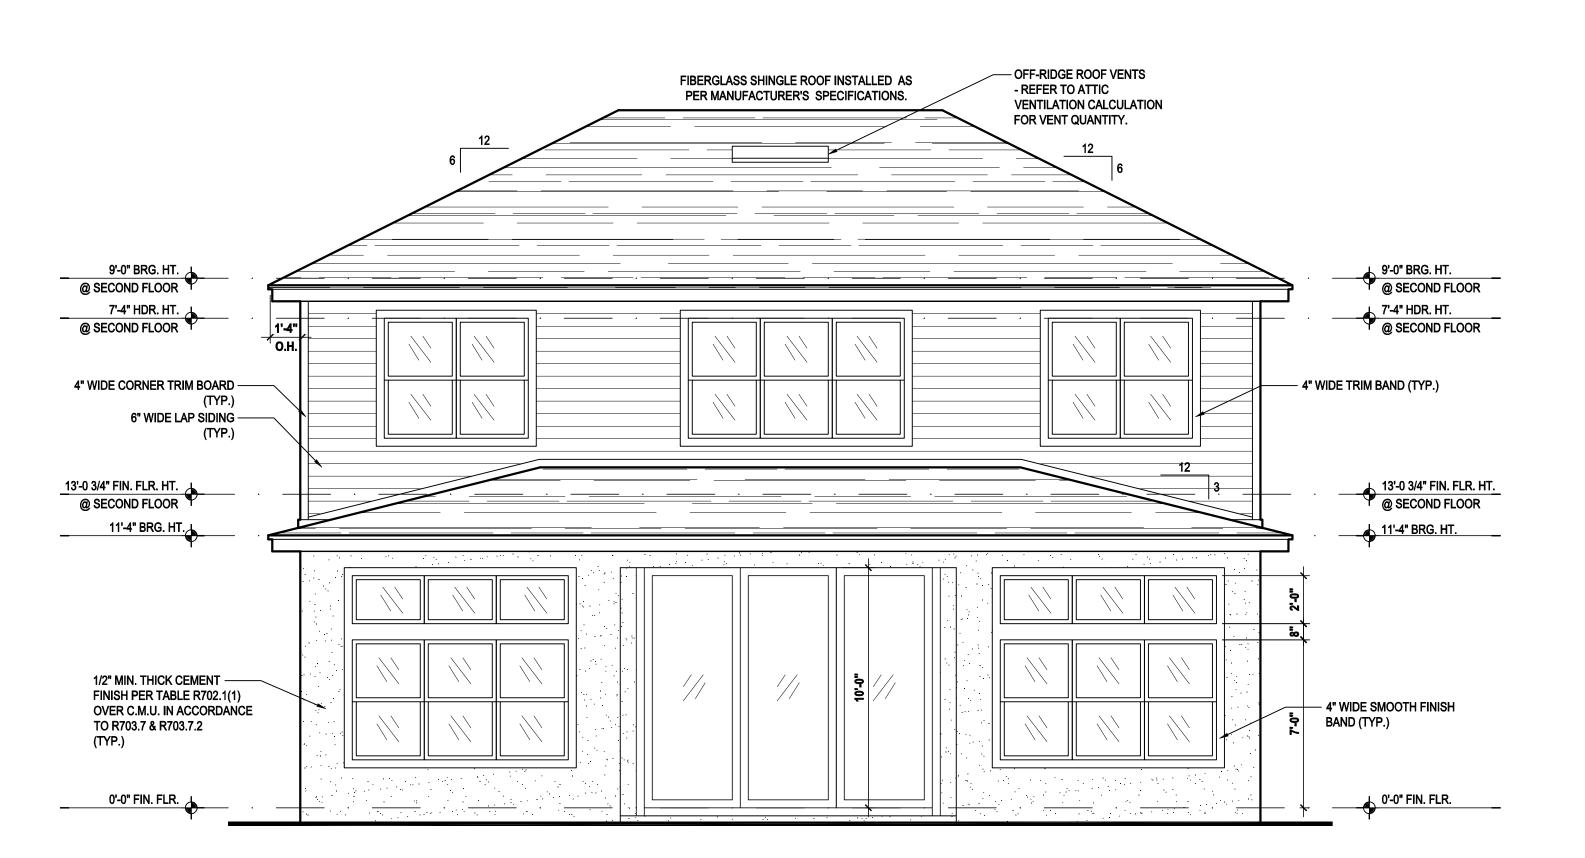

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(OFF-RIDGE VENT MAXIMUM OPENING SIZES)

(OFF-RIDGE VENT MAXIMUM OPENING SIZES)

MINIMUM NET VENTILATION AREA SHALL BE $\frac{1}{150}$ OF VENTED

TOTAL VENTED SPACE: $\frac{3,354}{300} = \frac{11.18 \text{ SF.}}{\text{REQUIRED}}$

JUDDED DODTION VENTUATION TOTAL: 4.472.95

UPPER PORTION VENTILATION TOTAL: 4.472 SF.
TO BE PROVIDED w/ OFF RIDGE VENTS:
6 VENTS @ .745 /PER VENT

TILE: O'HAGIN MODEL "S", SHINGLE: LOMANCO 770-D).

LOWER PORTION VENTILATION TOTAL: 6.708 SF.
TO BE PROVIDED w/ SOFFITS @ EAVE:
80.00 LF. @ 0.083 SF. VENTING/LF

UPPER ROOF PERCENTAGE: 40% LOWER ROOF PERCENTAGE: 60%

HOMPSON ENGINEERING GROUP, I

ns.com
ANS, DESIGNS,
E INTELLECTUAL
GHTS RESERVED.

THOMP.
4401 Vine
Ph: (407)
Fax: (407)

Ph: (407) 629-6711

Fax: (407) 629-6776

www.mjshomedesigns.c

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40-3042

SANIBEL (TPA)

Lot # - Community

Street Address

City, State. Zip

A division of Park Square
Enterprises Inc.
5200 Vineland Rd. Suite #200
Orlando, Fl. 32811
Phone: (407) 520, 2000




ISSUE DATE 03/27/2023

REVISIONS

PROJECT: 22-0000
SCALE: AS NOTED
DRAWN BY: M.C.
DESIGNED BY: MJS

ELEVATIONS "A"


A4.C1

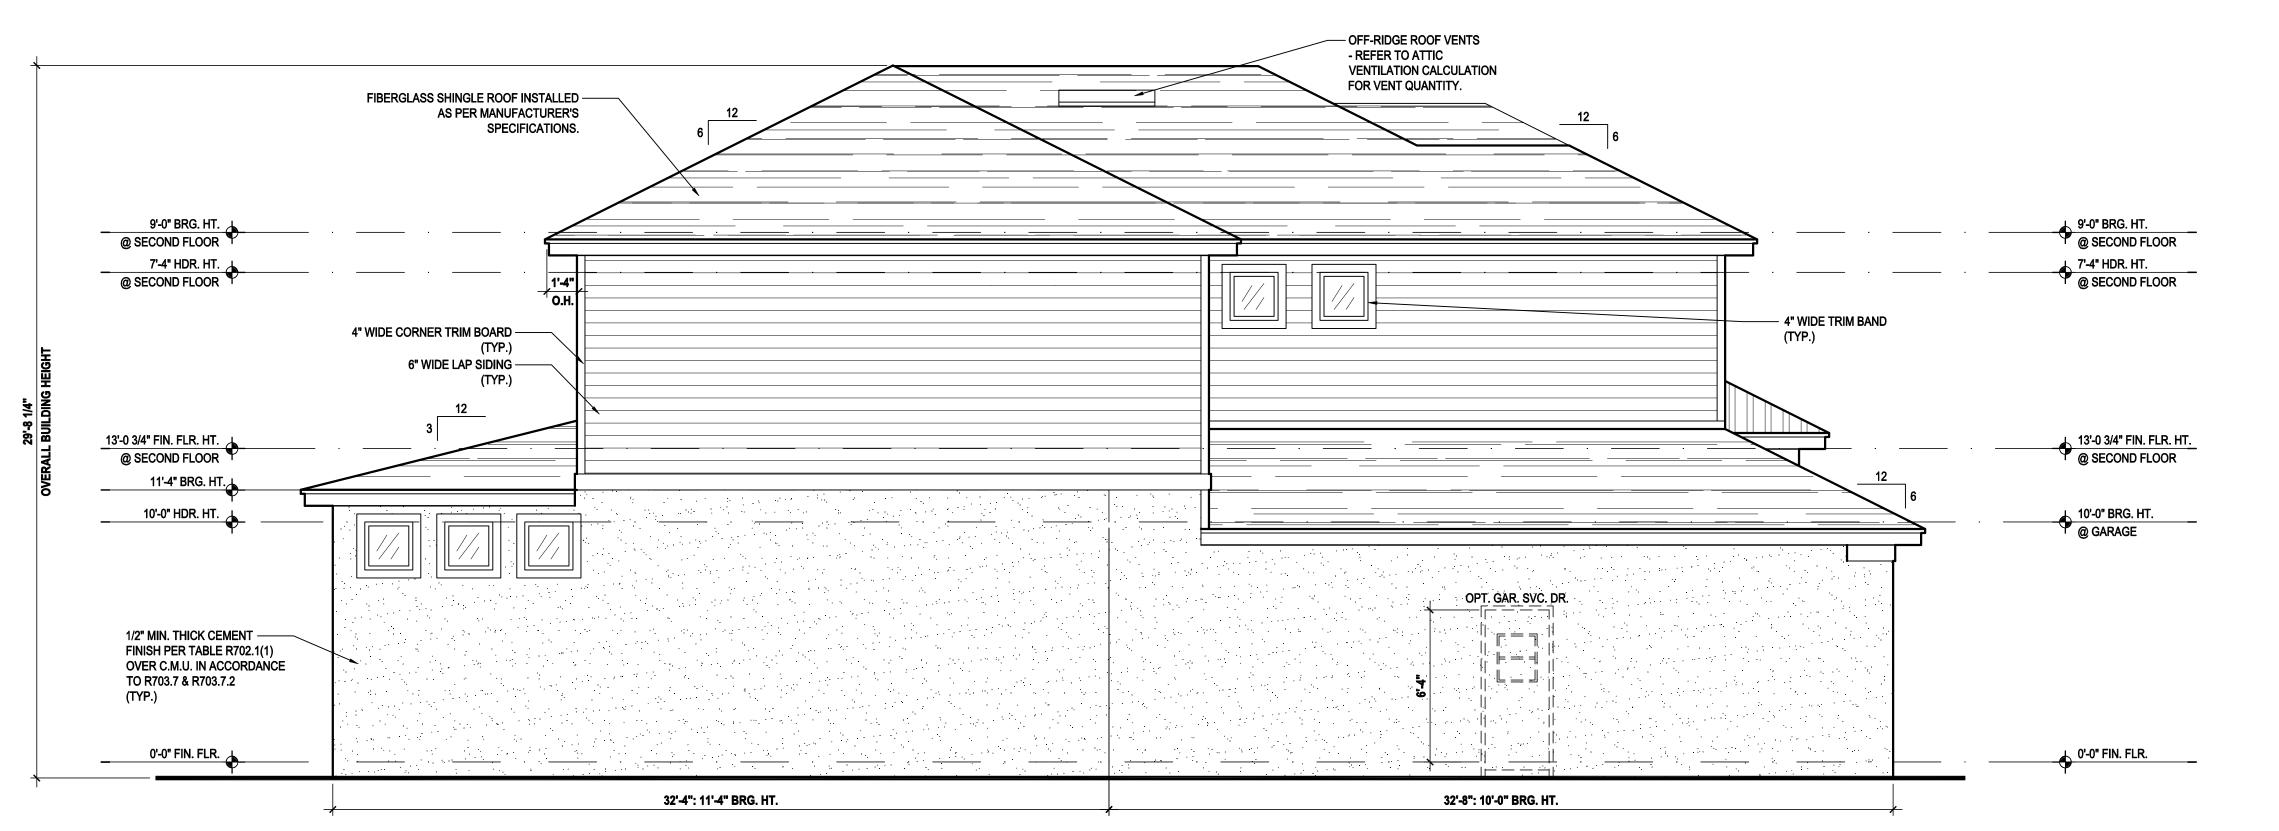

Left Elevation "A"

(Standard)

SCALE: 1/8" = 1'-0" (11x17) 1/4" = 1'-0" (22x34)

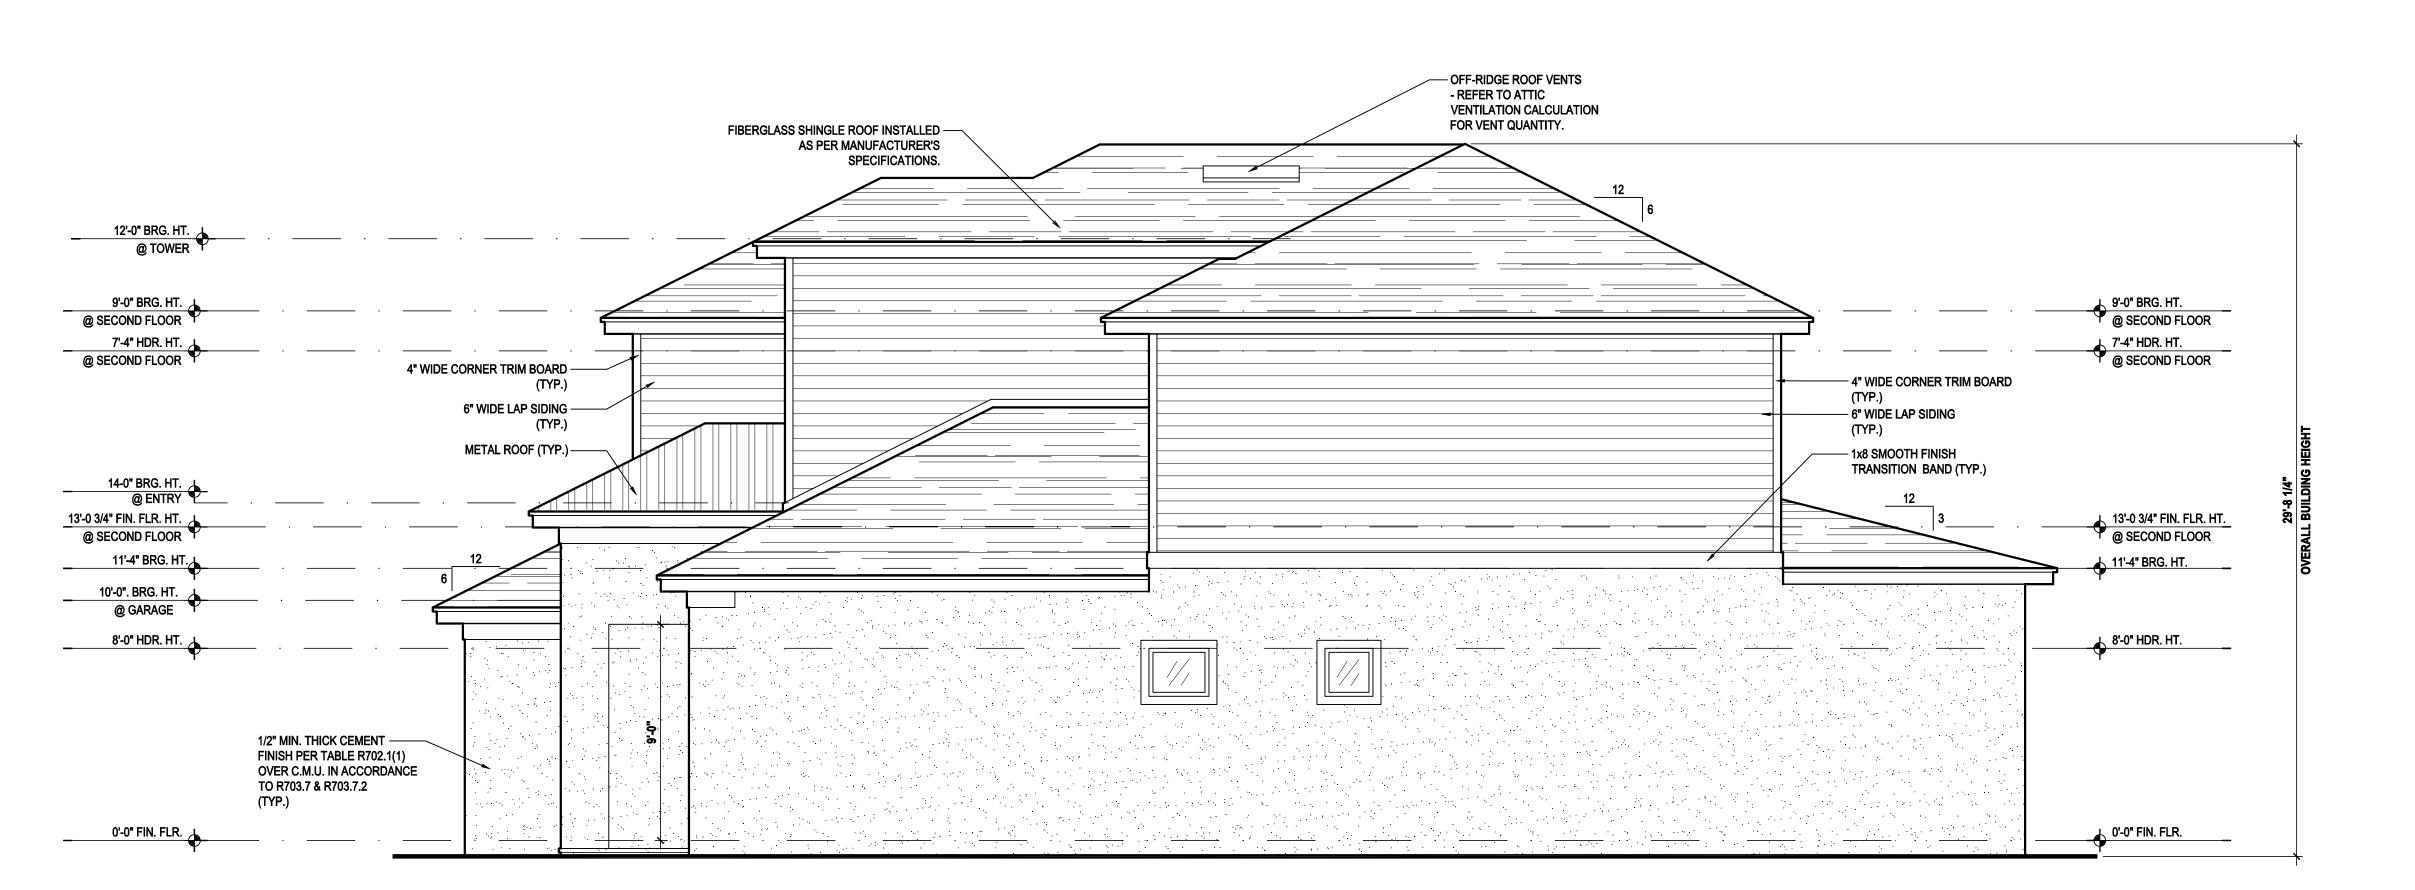

Right Elevation "A"

(Standard)

SCALE: 1/8" = 1'-0" (11x17) 1/4" = 1'-0" (22x34)









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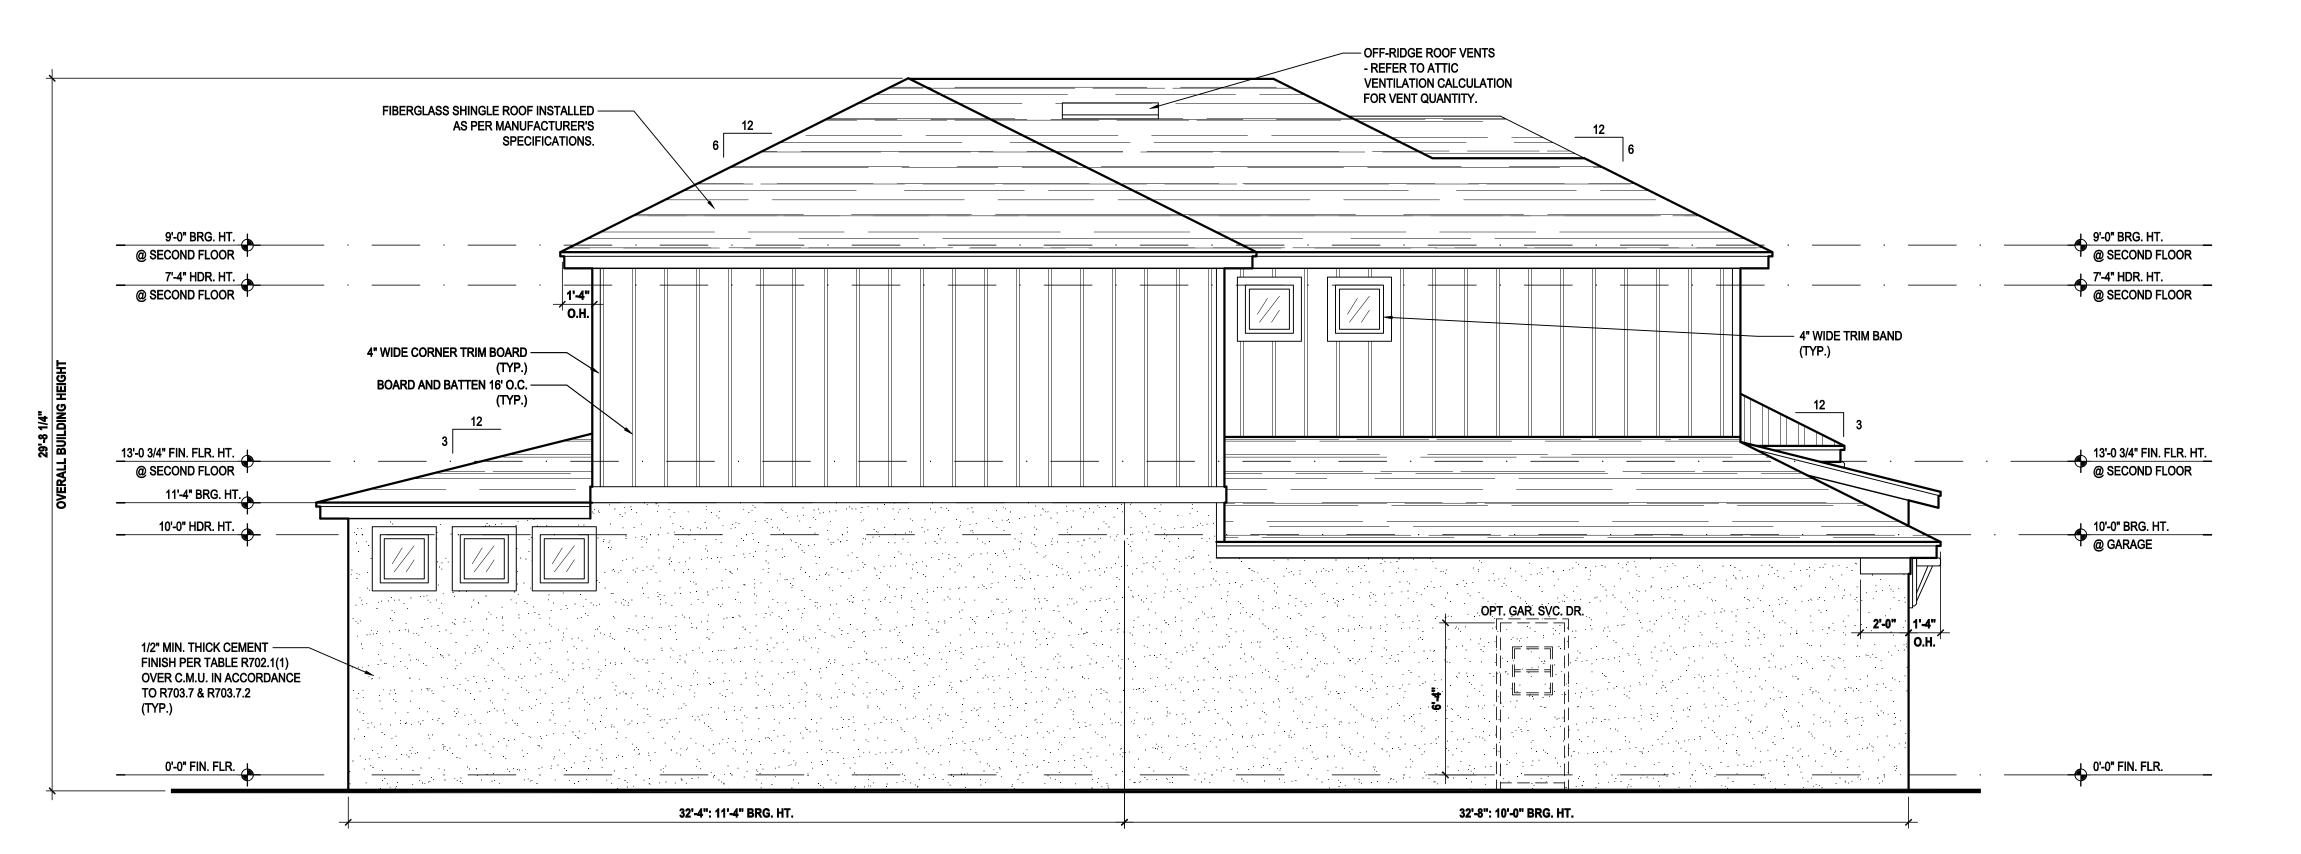


ISSUE DATE | 03/27/2023

REVISIONS

PROJECT: 22-0000 SCALE: AS NOTED DRAWN BY: M.C.


> **ELEVATIONS "A"** A5.A



Left Elevation "B"

(Standard)

SCALE: 1/8" = 1'-0" (11x17) 1/4" = 1'-0" (22x34)

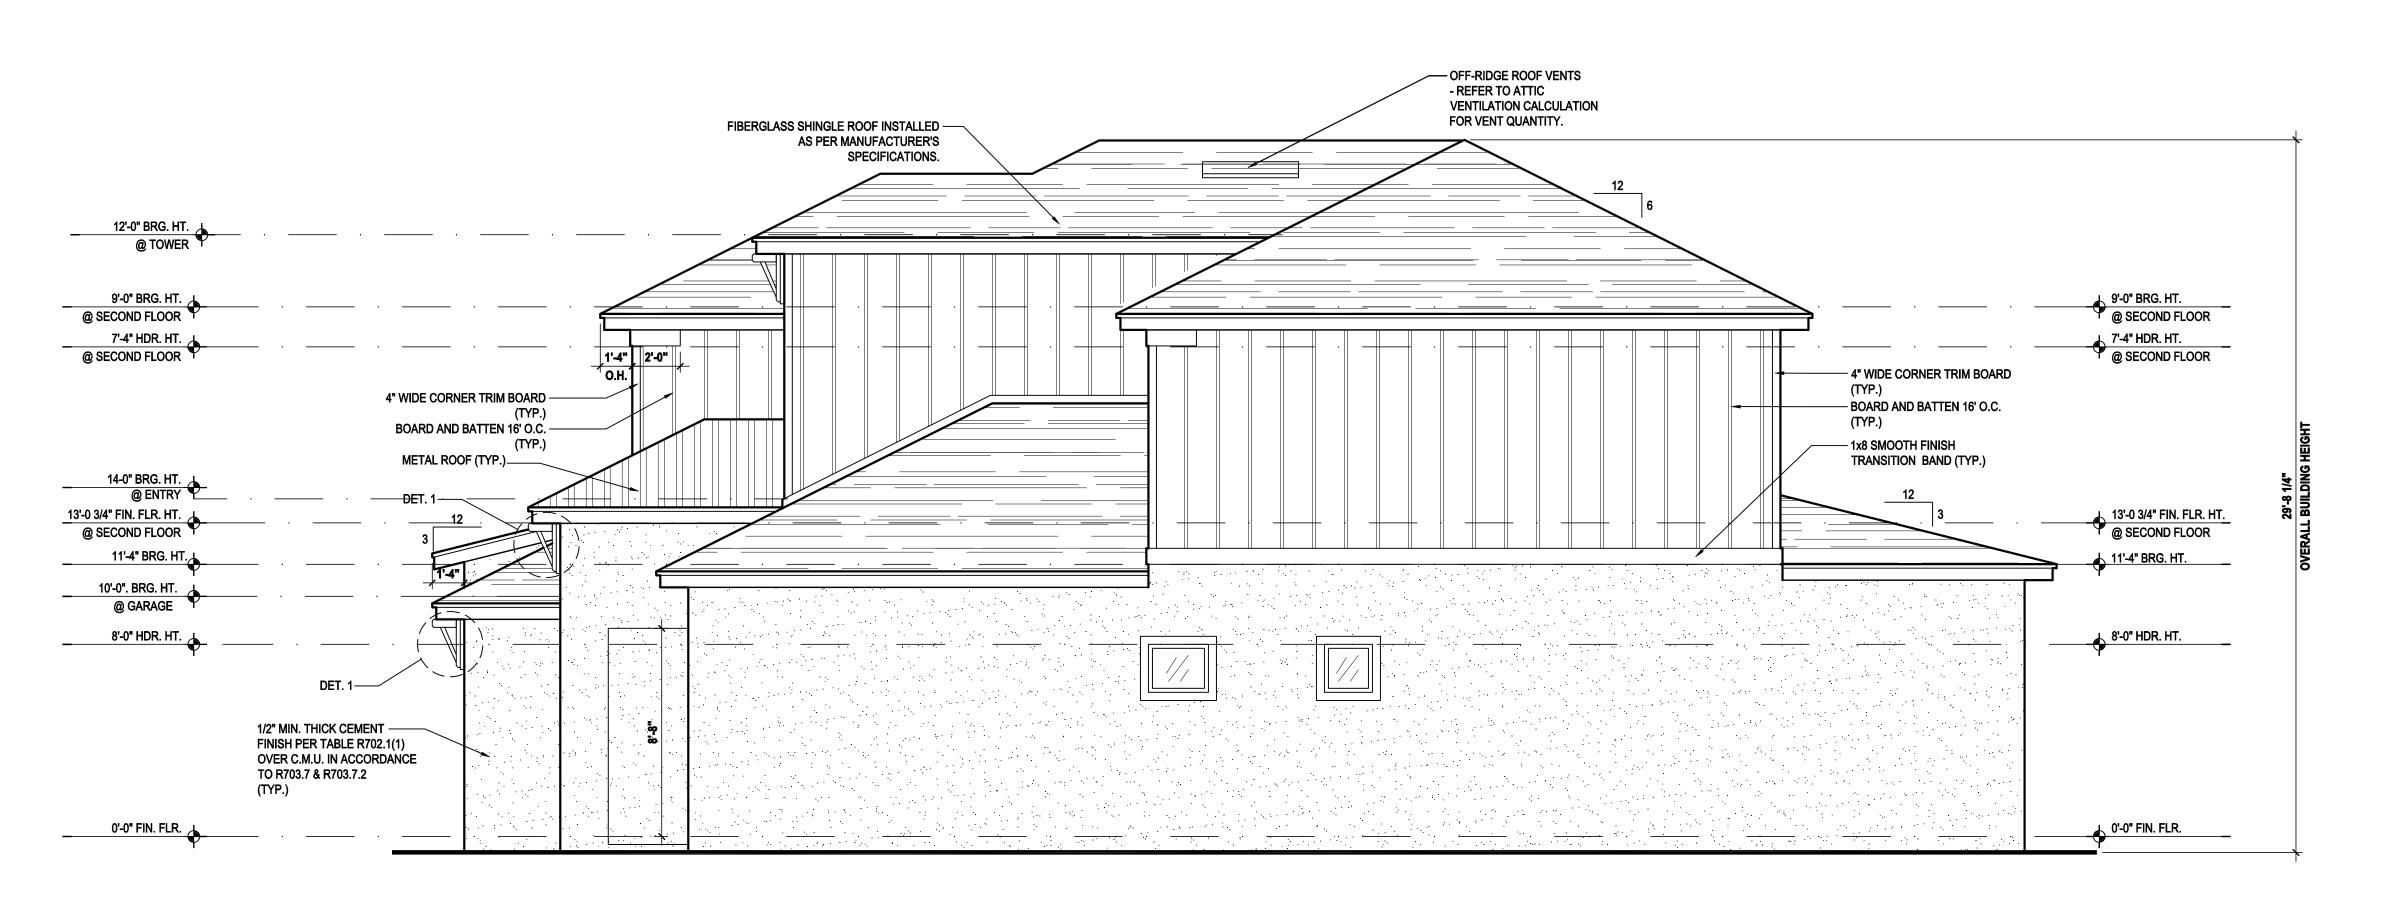

Right Elevation "B"

(Standard)

SCALE: 1/8" = 1'-0" (11x17) 1/4" = 1'-0" (22x34)



THOMPSON ENGINEERIN 4401 Vineland Road Suite A6 Or Fh: (407) 734-1790

Ph: (407) 629-6711
Fax: (407) 629-6776
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AO-3042

NIBEL (TPA)

Street Address

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Enterprises Inc.
5200 Vineland Rd. Suite #200
Orlando, Fl. 32811
Phone: (407) 529-3000




ISSUE DATE 03/27/2023
REVISIONS

PROJECT: 22-0000
SCALE: AS NOTED

PROJECT: 22-0000
SCALE: AS NOTE
DRAWN BY: M.C.
DESIGNED BY: MJS


ELEVATIONS "B"

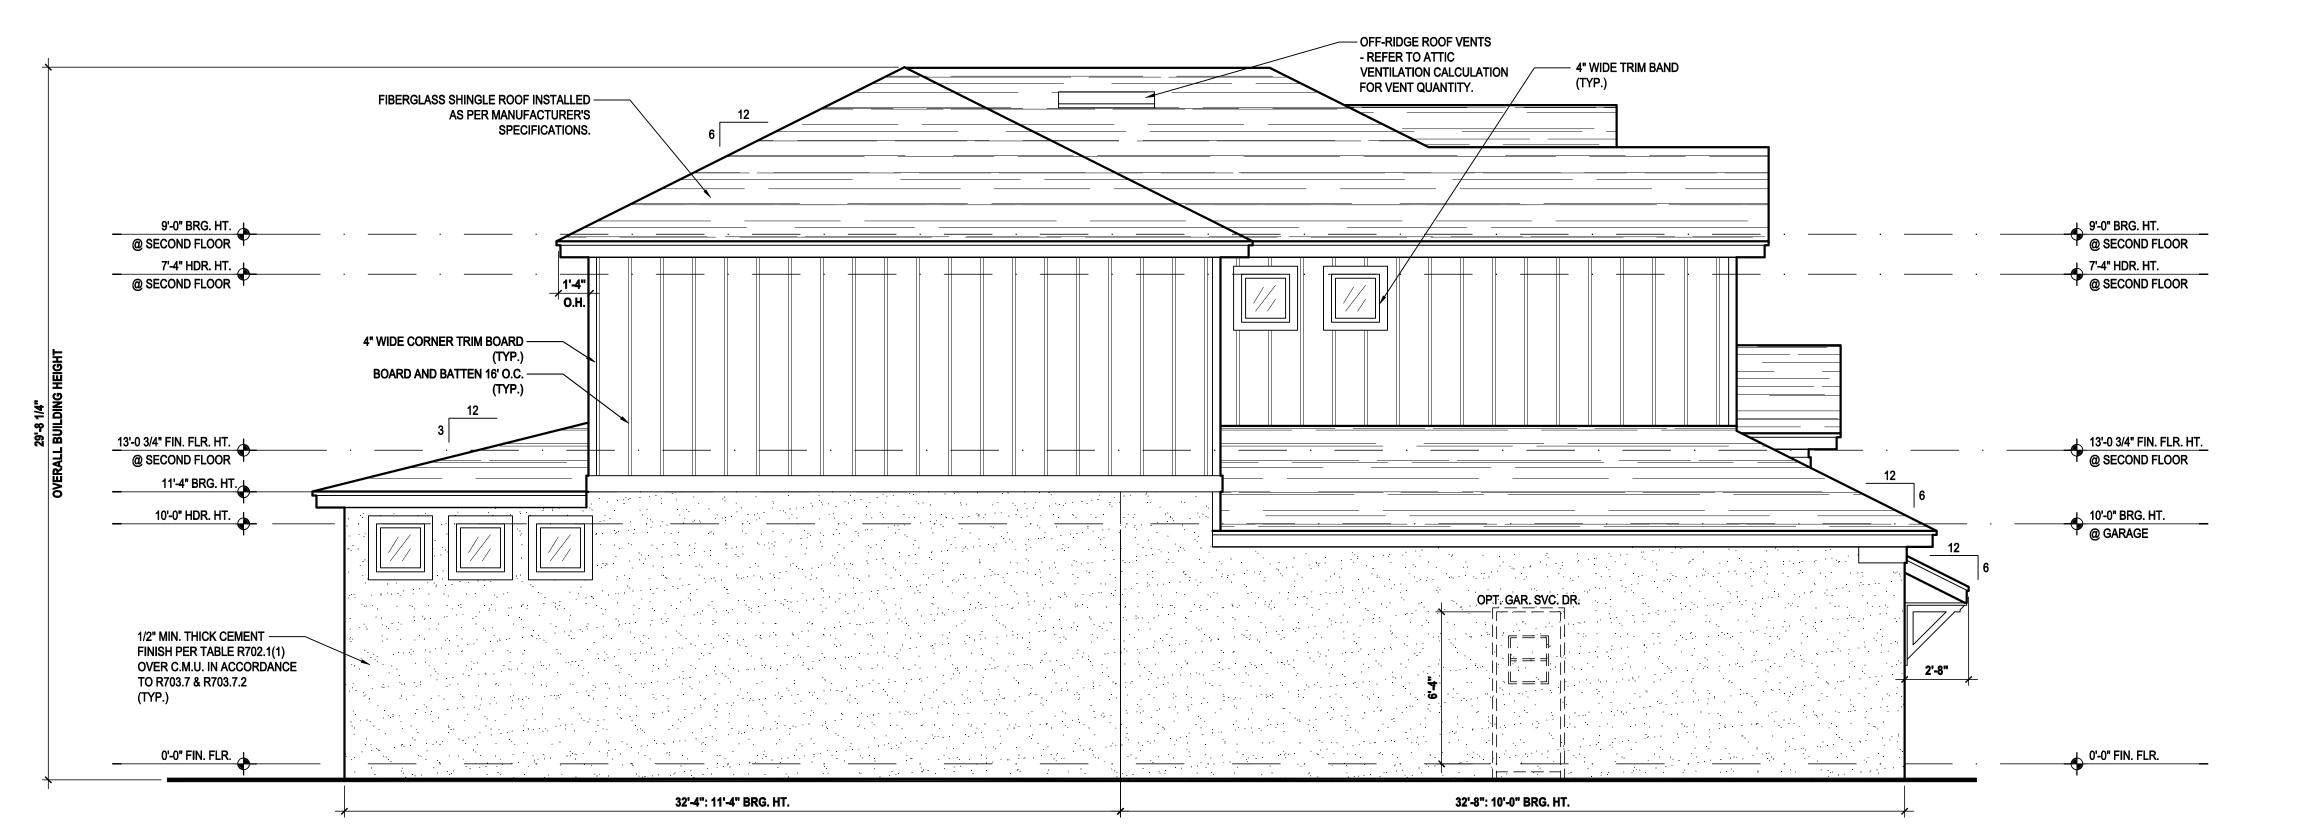

Left Elevation "C"

(Standard)

SCALE: 1/8" = 1'-0" (11x17) 1/4" = 1'-0" (22x34)

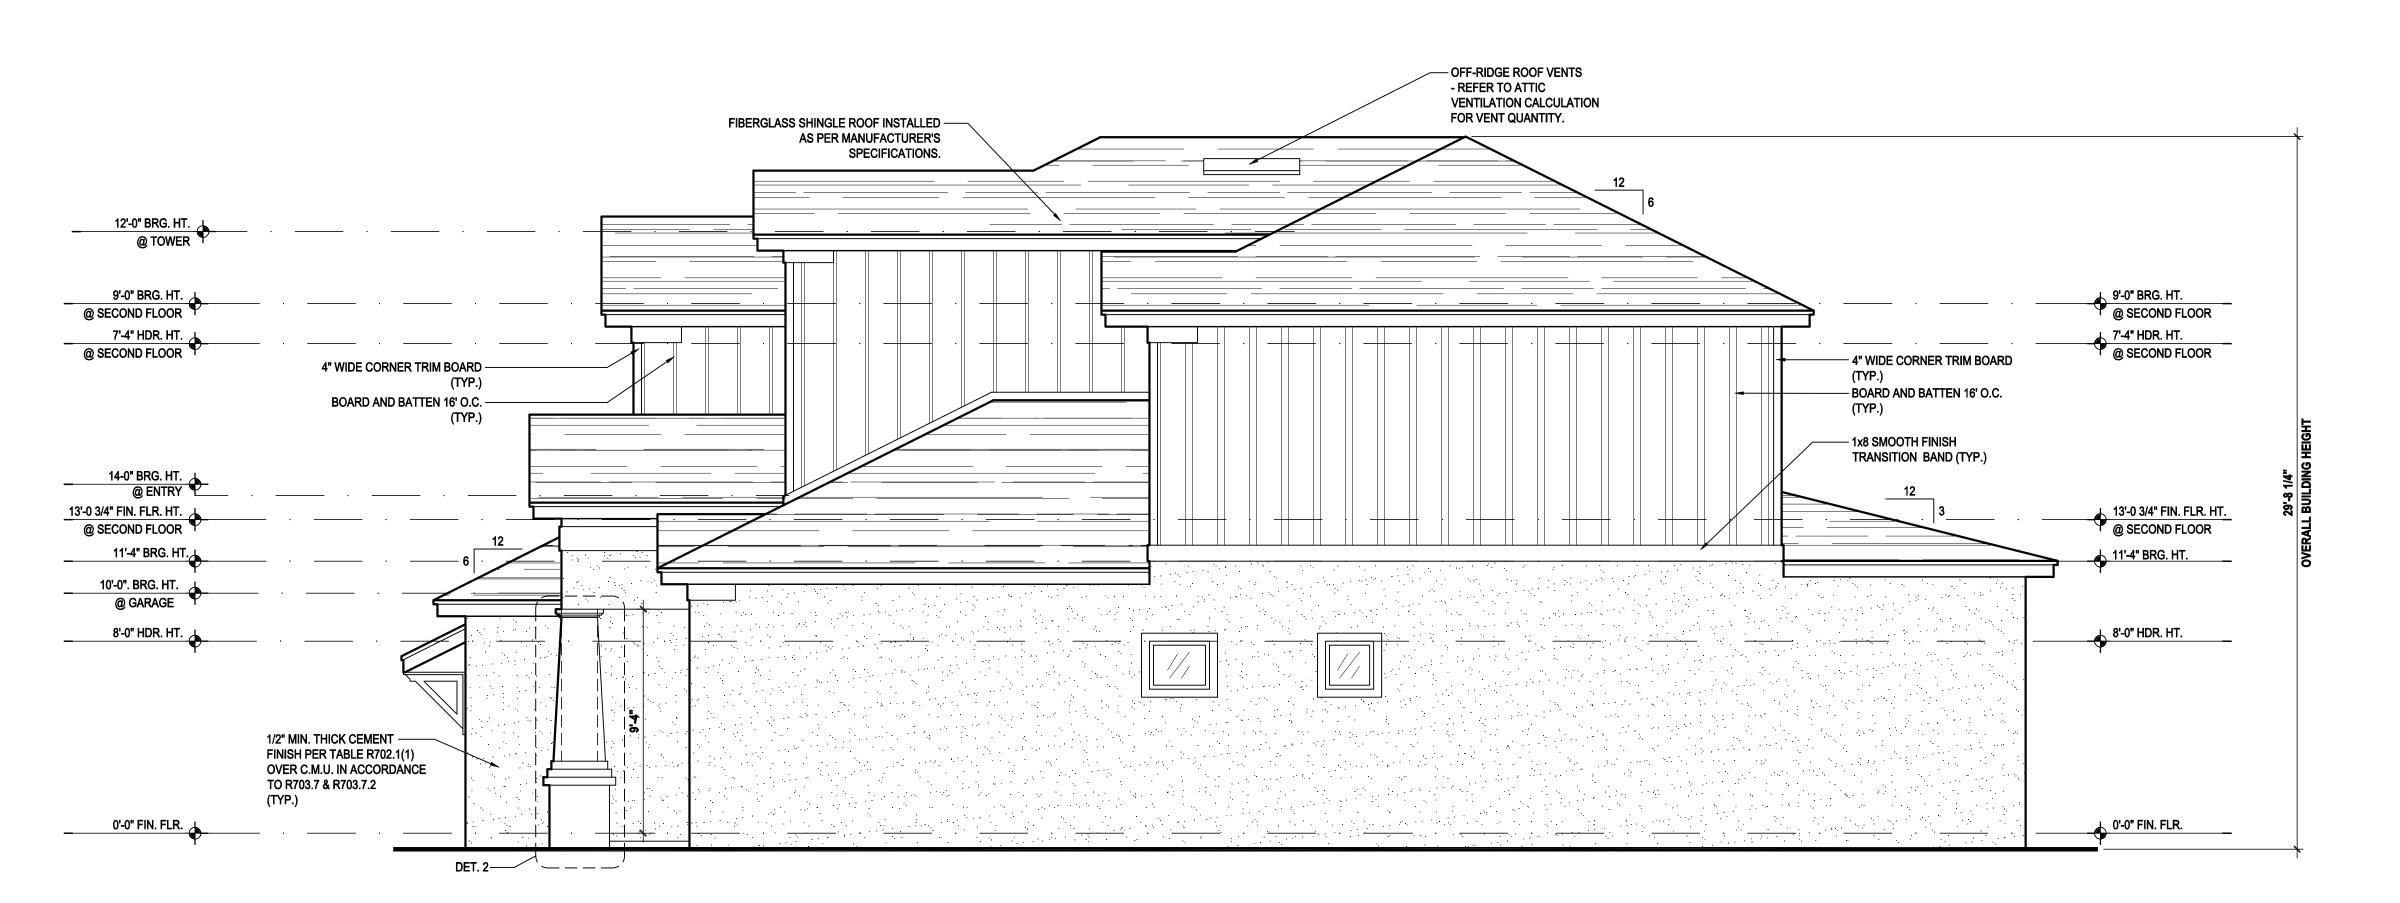

Right Elevation "C"

(Standard)

SCALE: 1/8" = 1'-0" (11x17) 1/4" = 1'-0" (22x34)


GOBA
GREATER ORLANDO BUILDERS ASSOCIATION NS, IDEAS AND DESIGN. THE PARTY WITHOUT FIRST CHARLES AND 18042 SANIBEL Lot # - Comm A division of Park Square Enterprises Inc.
5200 Vineland Rd. Suite #200
Orlando, Fl. 32811
Phone: (407) 529-3000 ISSUE DATE | 03/27/2023 REVISIONS PROJECT: 22-0000 SCALE: AS NOTED DRAWN BY: M.C. DESIGNED BY: MJS

ELEVATIONS "A"


A5.C

NOTES:


- STAIRWAY CONSTRUCTION TO CONFORM TO FBCR 2020, 7TH EDITION SECTION R311.7.
- 2. MAX HT. OF RISER TO BE 7 3/4".
- MIN. WIDTH OF TREAD TO BE 10" (EXCLUSIVE OF NOSING.
- ALL TREADS LESS THAN 10" IN WIDTH SHALL HAVE APPROX. 1" OF NOSING.
- 3/16" MAX VARIATION IN RISERS/TREADS ADJACENT TO EACH OTHER.
- 1/2" MAX VARIATION IN ANY RISE/TREAD.
- HAND RAIL CIRCULAR CROSS SECTION DIA. TO BE 1 1/4" 2" OR TO PROVIDE EQUIVALENT GRASPABILITY.
- 8. UNDER MIN. 6" WIDE @NARROW END.
- 34'-38" HANDRAIL HT.
- 10. HEADROOM CLEARANCE MIN 6'-8".

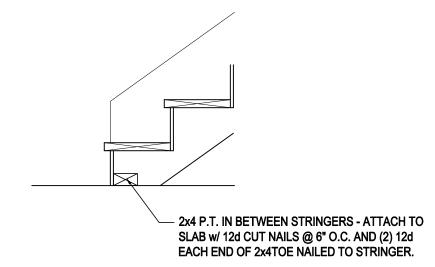

S1 TYP. STAIR CONNECT. A6 SCALE: 3/4" = 1'-0" (11x17) 1 1/2" = 1'-0" (22"x34")

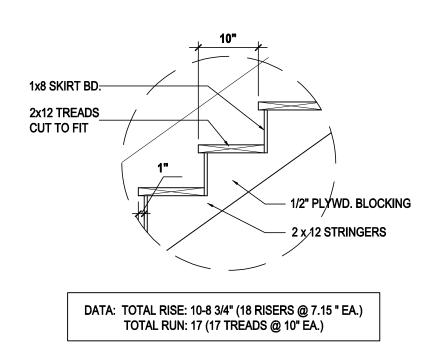


S2 TREAD & RISER DETAIL A6 SCALE: 3/4" = 1'-0" (11x17) 1 1/2" = 1'-0" (22x34)

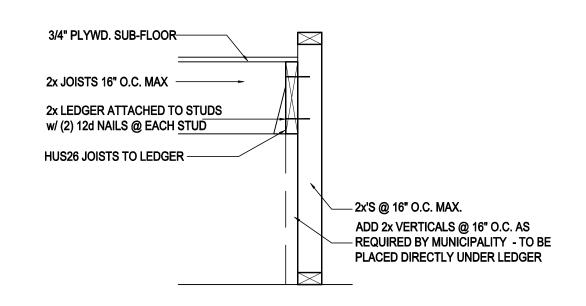


LANDING CONNECT. DETAIL

SCALE: 3/4" = 1'-0" (11x17) 1 1/2" = 1'-0" (22x34) PLATFORM FRAMING

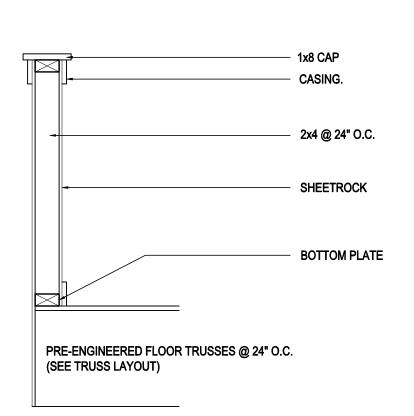


S3 HALF WALL DETAIL

SCALE: 3/4" = 1'-0" (11x17) 1 1/2" = 1'-0" (22x34)

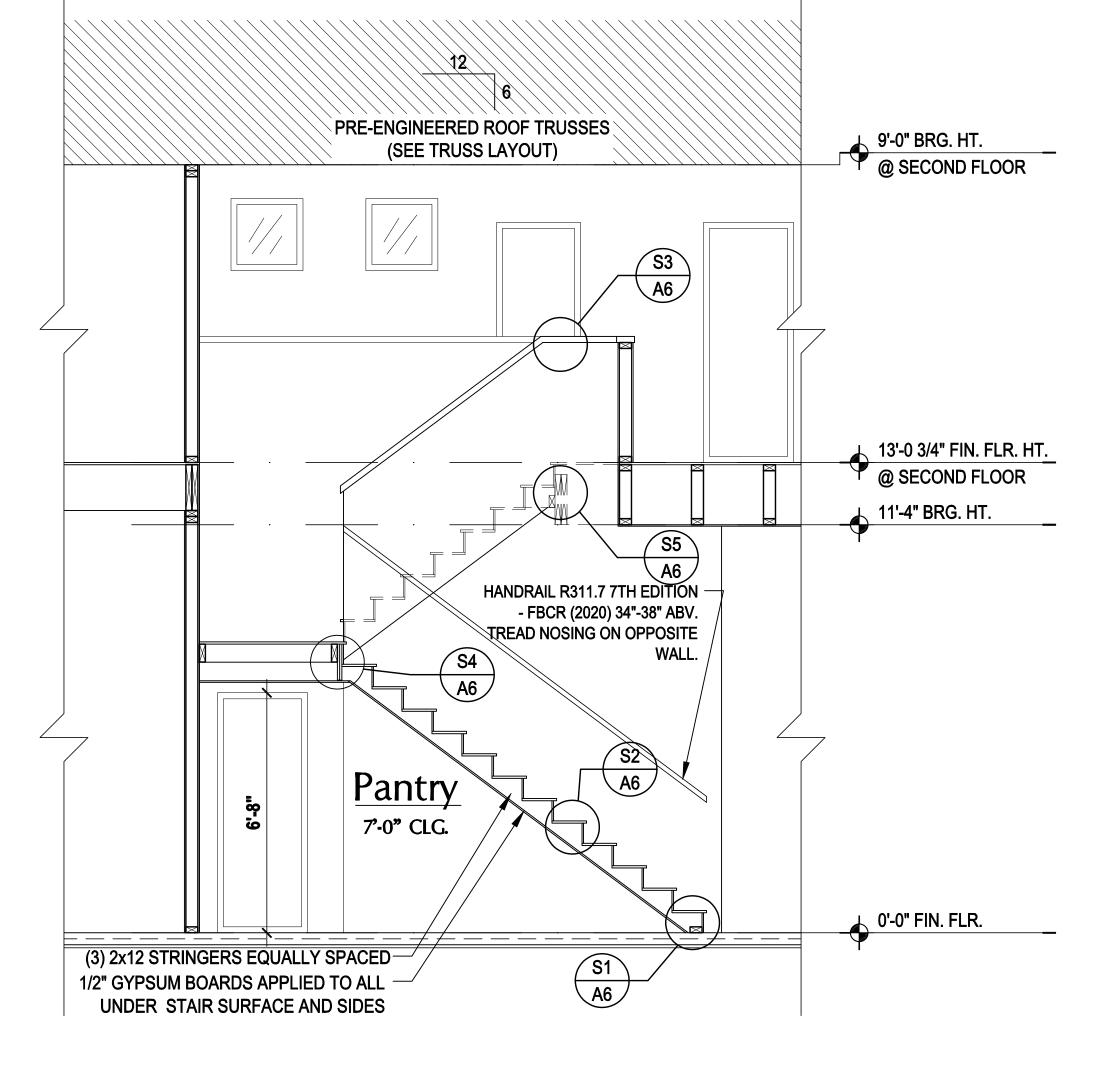



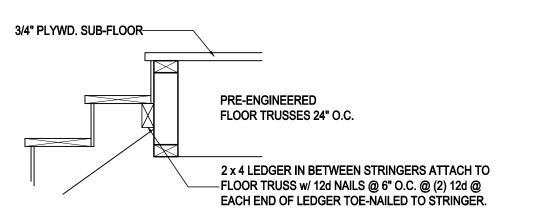







REVISIONS


PROJECT: 22-0000


SECTIONS

DRAWN BY: M.C.

DESIGNED BY: MJS

A6

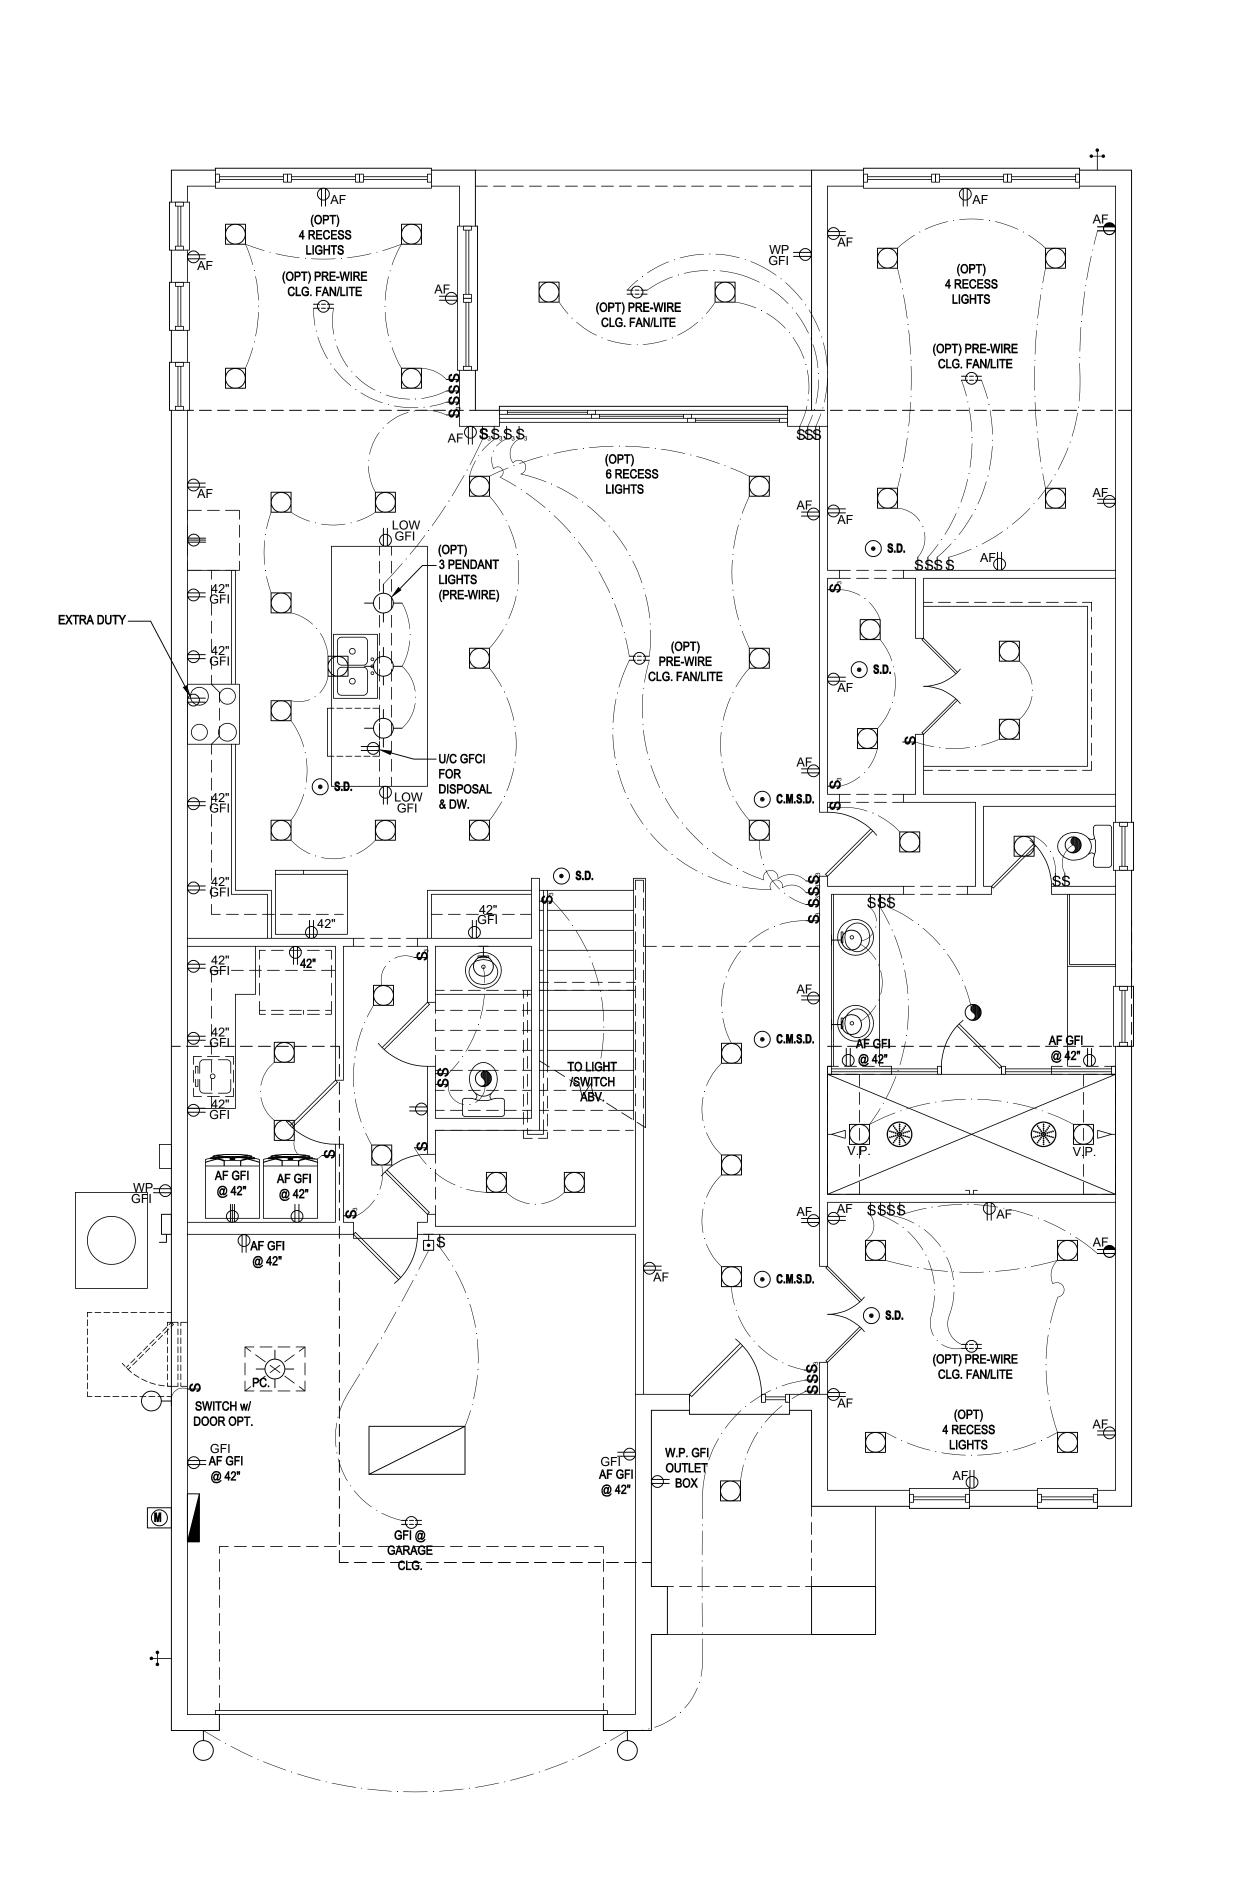

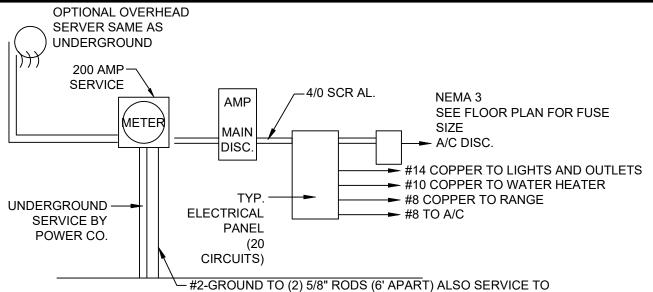

• ALL ELECTRICAL WORK AND APPLIANCES ARE IN FULL COMPLIANCE WITH N.F.P.A., N.E.C. 2017, F.B.C. 7TH EDITION (2020) RESIDENTIAL, AND ALL APPLICABLE LOCAL STANDARDS, CODES, AND ORDINANCES. THIS ELECTRICAL LAYOUT IS FOR BID PURPOSE ONLY.

BE BONDED TO FOOTING STEEL

- 1/0 COPPER THWN WILL BE USED FOR BOTH HOT WIRES . #1 COPPER THWN WILL BE USED FOR
- 3/0 SER ALUM. CABLE WILL BE USED FROM THE DISC. TO THE INSIDE PANELS FROM BOTH DISC.

200 AMP ELECTRICAL RISER

GENERAL NOTES KEY:

BUILDER TO VERIFY EXACT LOCATION OF FLOOR OUTLETS

- ALL OUTLETS ARE TO BE AFCI PROTECTED.
- ALL 15A AND 20A 120V BRANCH CIRCUITS WILL BE AFCI
- ALL 15A AND 20A 120V BRANCH CIRCUITS LOCATED IN THE
- GARAGE AND LAUNDRY WILL BE GFCI PROTECTED. ALL GARAGE BAYS WILL HAVE DEDICATED GFCI OUTLET.
- ALL OUTLETS LOCATED IN THE KITCHEN AND BATHROOMS
- ARE TO BE GFCI PROTECTED. DW. AND GARBAGE DISPOSAL ARE TO BE GFCI PROTECTED
- EXCEPTIONS TO THE GFCI STIPULATION WILL BE ALLOWED ONLY IF ALLOWED PER CURRENT NFPA / NEC.
- OUTLETS LOCATED IN THE LAUNDRY ARE TO BE GFCI AND AFCI PROTECTED.
- OUTLETS LOCATED WITHIN 6'-0" OF A WET AREA ARE TO BE GFCI PROTECTED.
- ALL OUTLETS OVER COUNTERTOPS TO BE 42" A.F.F. (U.N.O.)
- . ALL SMOKE/CARBON MONOXIDE DETECTORS ARE TO BE
- HARD WIRED, INTERCONNECTED AND AFCI PROTECTED. 3. 8'-0" HEIGHT VANITY LIGHTS IN MASTER BATHROOM AND 7'-0
- IN ALL OTHER BATHROOMS. IN AREAS SPECIFIED IN SECTION E3901.1, 125-VOLT, 15- AND
- 20-AMPERE RECEPTACLES SHALL BE LISTED TAMPER-RESISTANT RECEPTACLES.

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- VARIOUS SYMBOLS ON ELECTRICAL LEGEND MAY OR MAY NOT BE USED ON THIS PLAN.

ELECTRICAL KEY:

CEILING MOUNTED LIGHT

PULL CHAIN LIGHT

WALL MOUNTED LIGHT WALL WASH RECESSED

DUPLEX RECEPTACLE 220 V RECEPTACLE 1/2 HOT, 1/2 SWITCHED

FLOOR RECEPTACLE PRE-WIRE FOR CLG. FAN

WALL SWITCH

3-WAY SWITCH DIMMER SWITCH TELEPHONE JACK

CABLE JACK

 \Box

●S.D.

L.V.

FLUORESCENT LIGHT

DISCONNECT SWITCH **ELECTRICAL METER**

SMOKE DETECTOR

CEILING FAN

WALL SCONCE

SPOT LIGHT

SPEAKER

JUNCTION BOX

LOW VOLTAGE VAPOR PROOF

ELECTRICAL PANEL

WATER PROOF RECEPTACLE

GROUND FAULT INTERRUPT

PRE-WIRE GARAGE DOOR OPENER

DOOR BELL / GARAGE DOOR SWITCH

CARBON MONOXIDE / SMOKE DETECTOR

FLUSH MOUNT FLUORESCENT LIGHT

FAN / LIGHT COMBINATION

ARC FAULT PROTECTION

GARBAGE DISPOSAL MOTOR







40-3042

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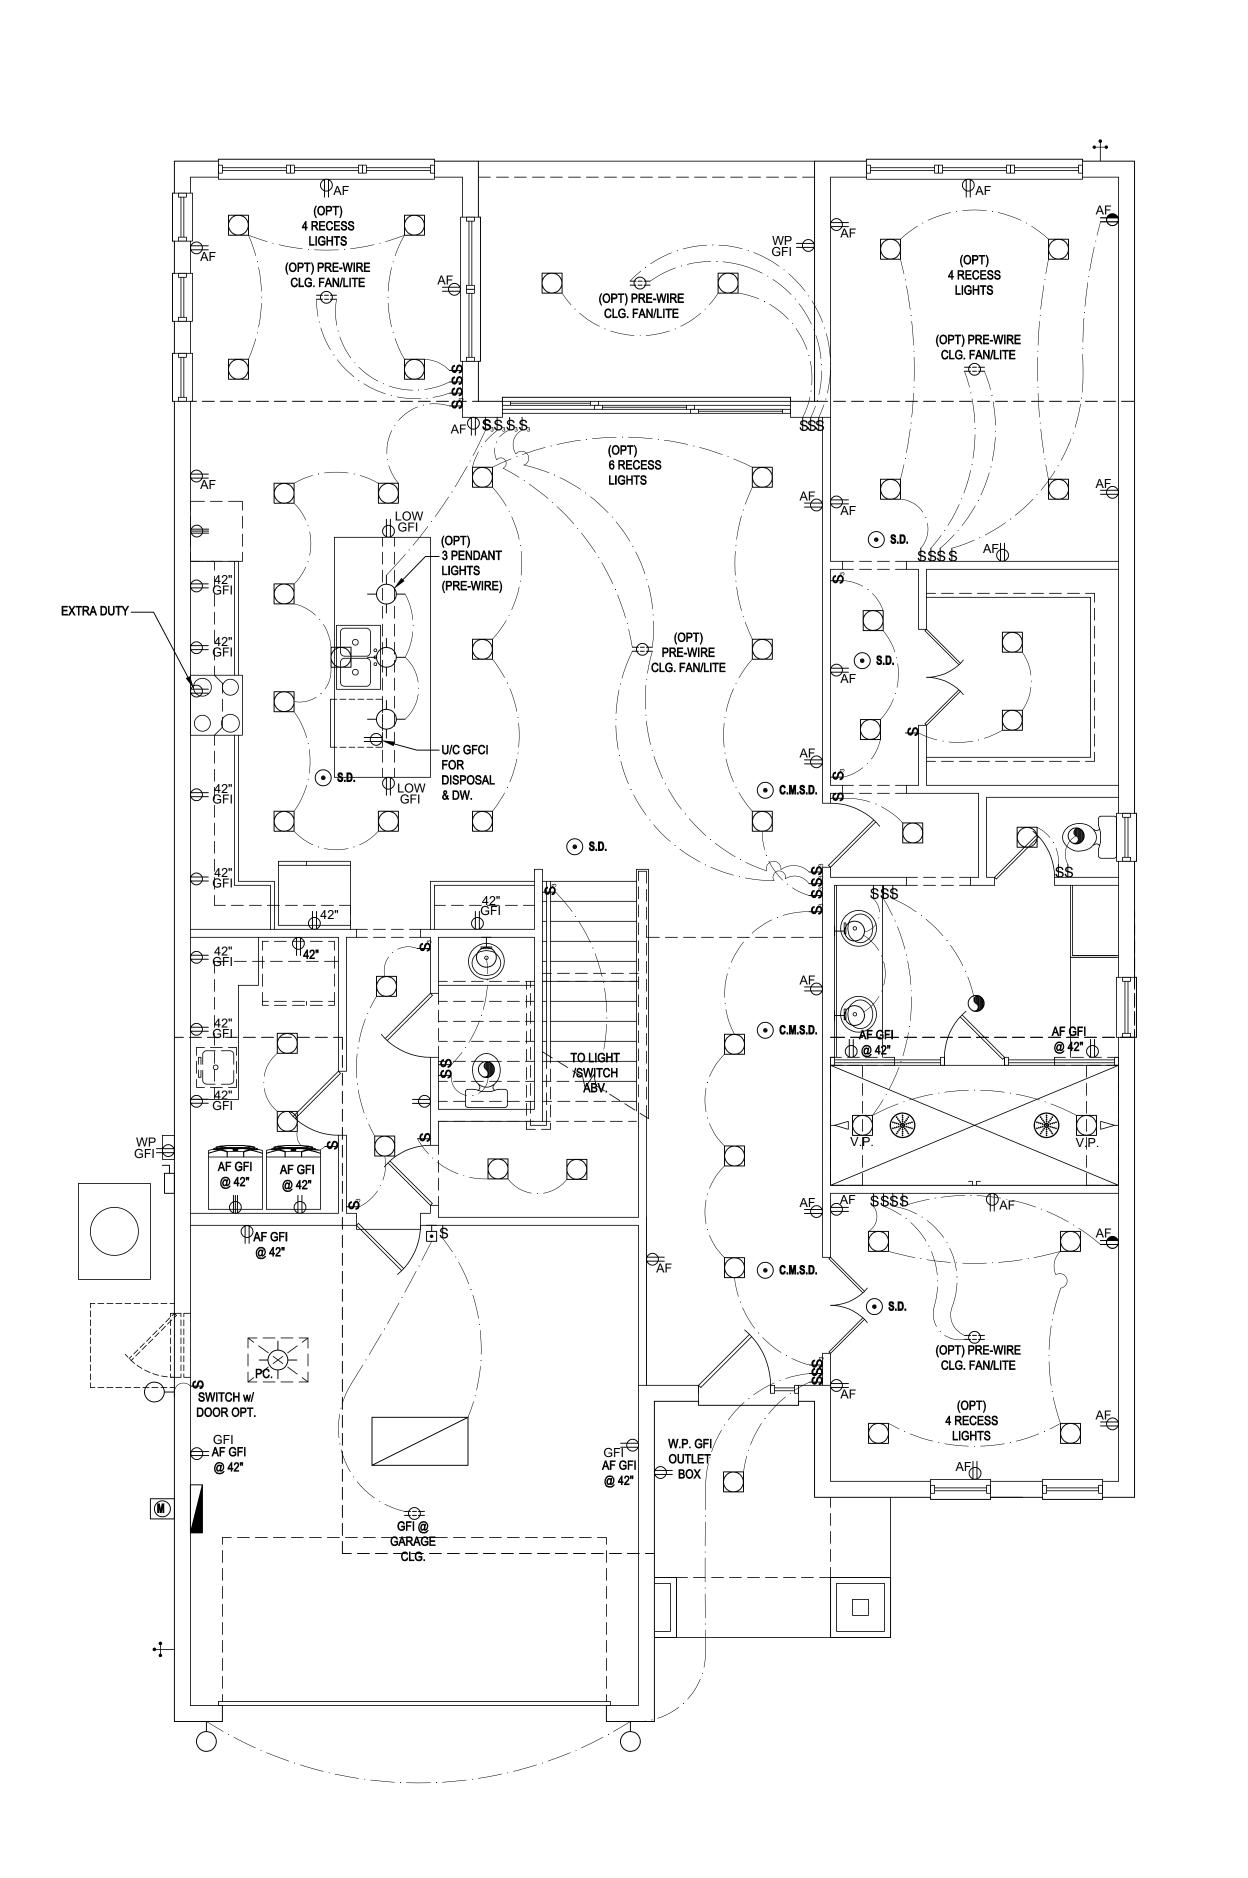
ISSUE DATE | 03/27/2023 **REVISIONS**


PROJECT: 22-0000 SCALE: DRAWN BY: M.C.

ESIGNED BY: MJS A7.AB Le

First Floor Electrical Plan "A&B"

(Standard)



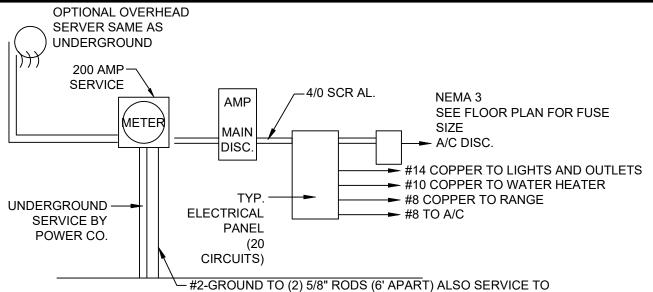

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PULL CHAIN LIGHT

WALL MOUNTED LIGHT WALL WASH RECESSED

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FLOOR RECEPTACLE

WALL SWITCH

3-WAY SWITCH DIMMER SWITCH TELEPHONE JACK

CABLE JACK

FLUORESCENT LIGHT

DISCONNECT SWITCH **ELECTRICAL METER**

SMOKE DETECTOR

CEILING FAN

WALL SCONCE

CHANDELIER

SPOT LIGHT

SPEAKER

JUNCTION BOX

LOW VOLTAGE VAPOR PROOF

ELECTRICAL PANEL

PRE-WIRE FOR CLG. FAN

GROUND FAULT INTERRUPT

PRE-WIRE GARAGE DOOR OPENER

DOOR BELL / GARAGE DOOR SWITCH

CARBON MONOXIDE / SMOKE DETECTOR

FLUSH MOUNT FLUORESCENT LIGHT

FAN / LIGHT COMBINATION

ARC FAULT PROTECTION

GARBAGE DISPOSAL MOTOR

⊕

 \Box

●S.D.

(S)

• L.V.

WATER PROOF RECEPTACLE









40-3042 SANIBEL (
Lot # - Comm
Street Addra
City, State.

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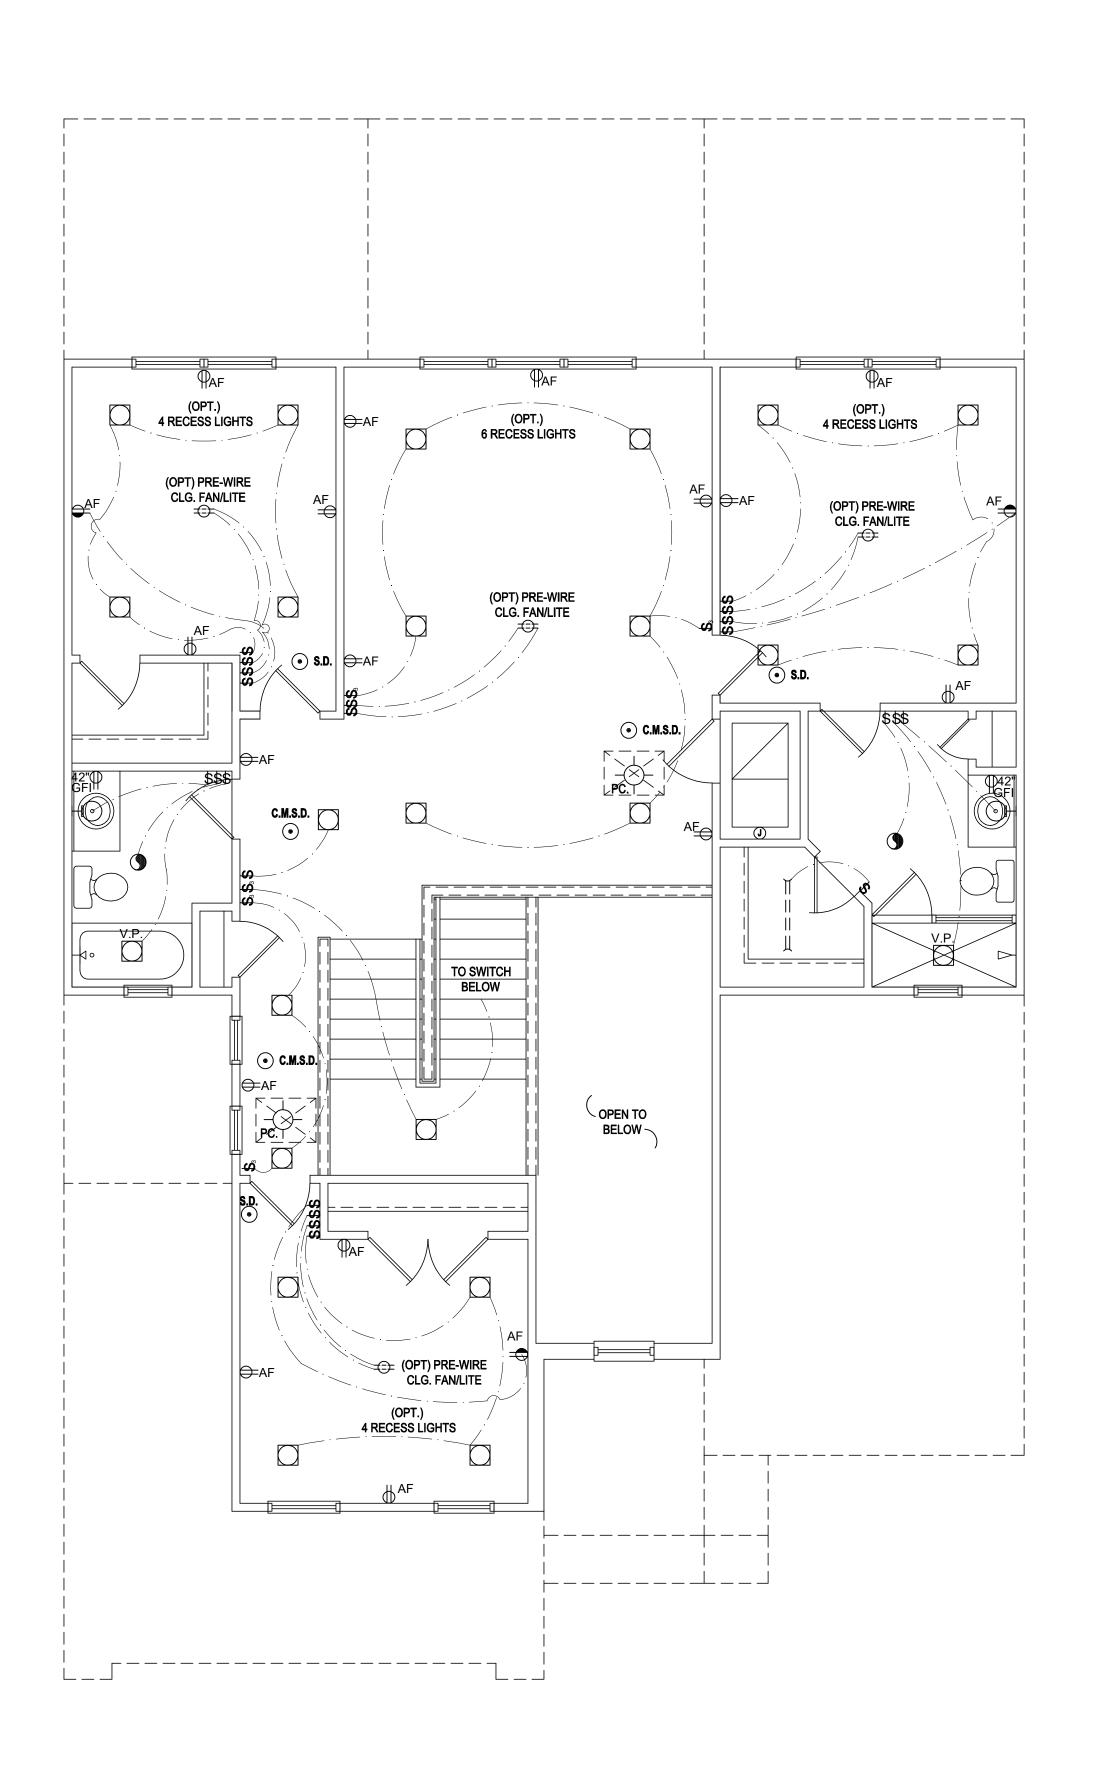
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PROJECT: 22-0000 SCALE: AS NOTED DRAWN BY: M.C.

ESIGNED BY: MJS A7.C Le

First Floor Electrical Plan "C"

(Standard)



BUILDER TO VERIFY EXACT LOCATION OF FLOOR OUTLETS

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 - EXCEPTIONS TO THE GFCI STIPULATION WILL BE ALLOWED

 - AFCI PROTECTED.
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 - IN ALL OTHER BATHROOMS.
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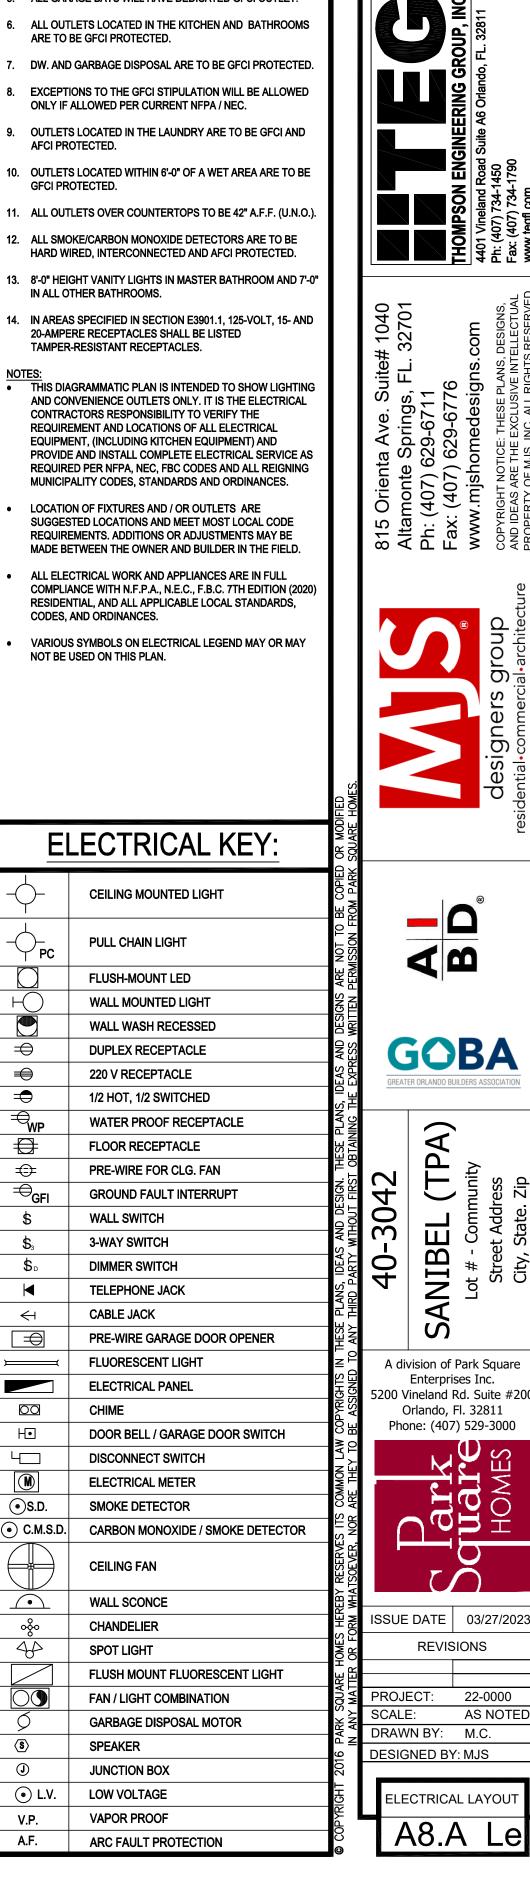
- SUGGESTED LOCATIONS AND MEET MOST LOCAL CODE REQUIREMENTS. ADDITIONS OR ADJUSTMENTS MAY BE MADE BETWEEN THE OWNER AND BUILDER IN THE FIELD.
- RESIDENTIAL, AND ALL APPLICABLE LOCAL STANDARDS, CODES, AND ORDINANCES.
- NOT BE USED ON THIS PLAN.

'	
-\rightarrow_FC	PULL CHAIN LIGHT
	FLUSH-MOUNT LED
$\overline{\Box}$	WALL MOUNTED LIGHT
	WALL WASH RECESSED
#	DUPLEX RECEPTACLE
#	220 V RECEPTACLE
	1/2 HOT, 1/2 SWITCHED
₩P	WATER PROOF RECEPTACLE
\Box	FLOOR RECEPTACLE
+	PRE-WIRE FOR CLG. FAN
\Rightarrow_{GFI}	GROUND FAULT INTERRUPT
\$	WALL SWITCH
\$ ₃	3-WAY SWITCH
\$₀	DIMMER SWITCH
M	TELEPHONE JACK
\forall	CABLE JACK
\bigoplus	PRE-WIRE GARAGE DOOR OPENER
	FLUORESCENT LIGHT
	ELECTRICAL PANEL
00	CHIME
H●	DOOR BELL / GARAGE DOOR SWITCH
	DISCONNECT SWITCH
M	ELECTRICAL METER
●S.D.	SMOKE DETECTOR
• C.M.S.D.	CARBON MONOXIDE / SMOKE DETECTOR
	CEILING FAN
•	WALL SCONCE
080	CHANDELIER
46	SPOT LIGHT
	FLUSH MOUNT FLUORESCENT LIGHT
	FAN / LIGHT COMBINATION
\circ	GARBAGE DISPOSAL MOTOR
(S)	SPEAKER

Second Floor Electrical Plan "A"

(Standard)


SCALE: 1/8" = 1'-0" (11x17) 1/4" = 1'-0" (22x34)





5200 Vineland Rd. Suite #200



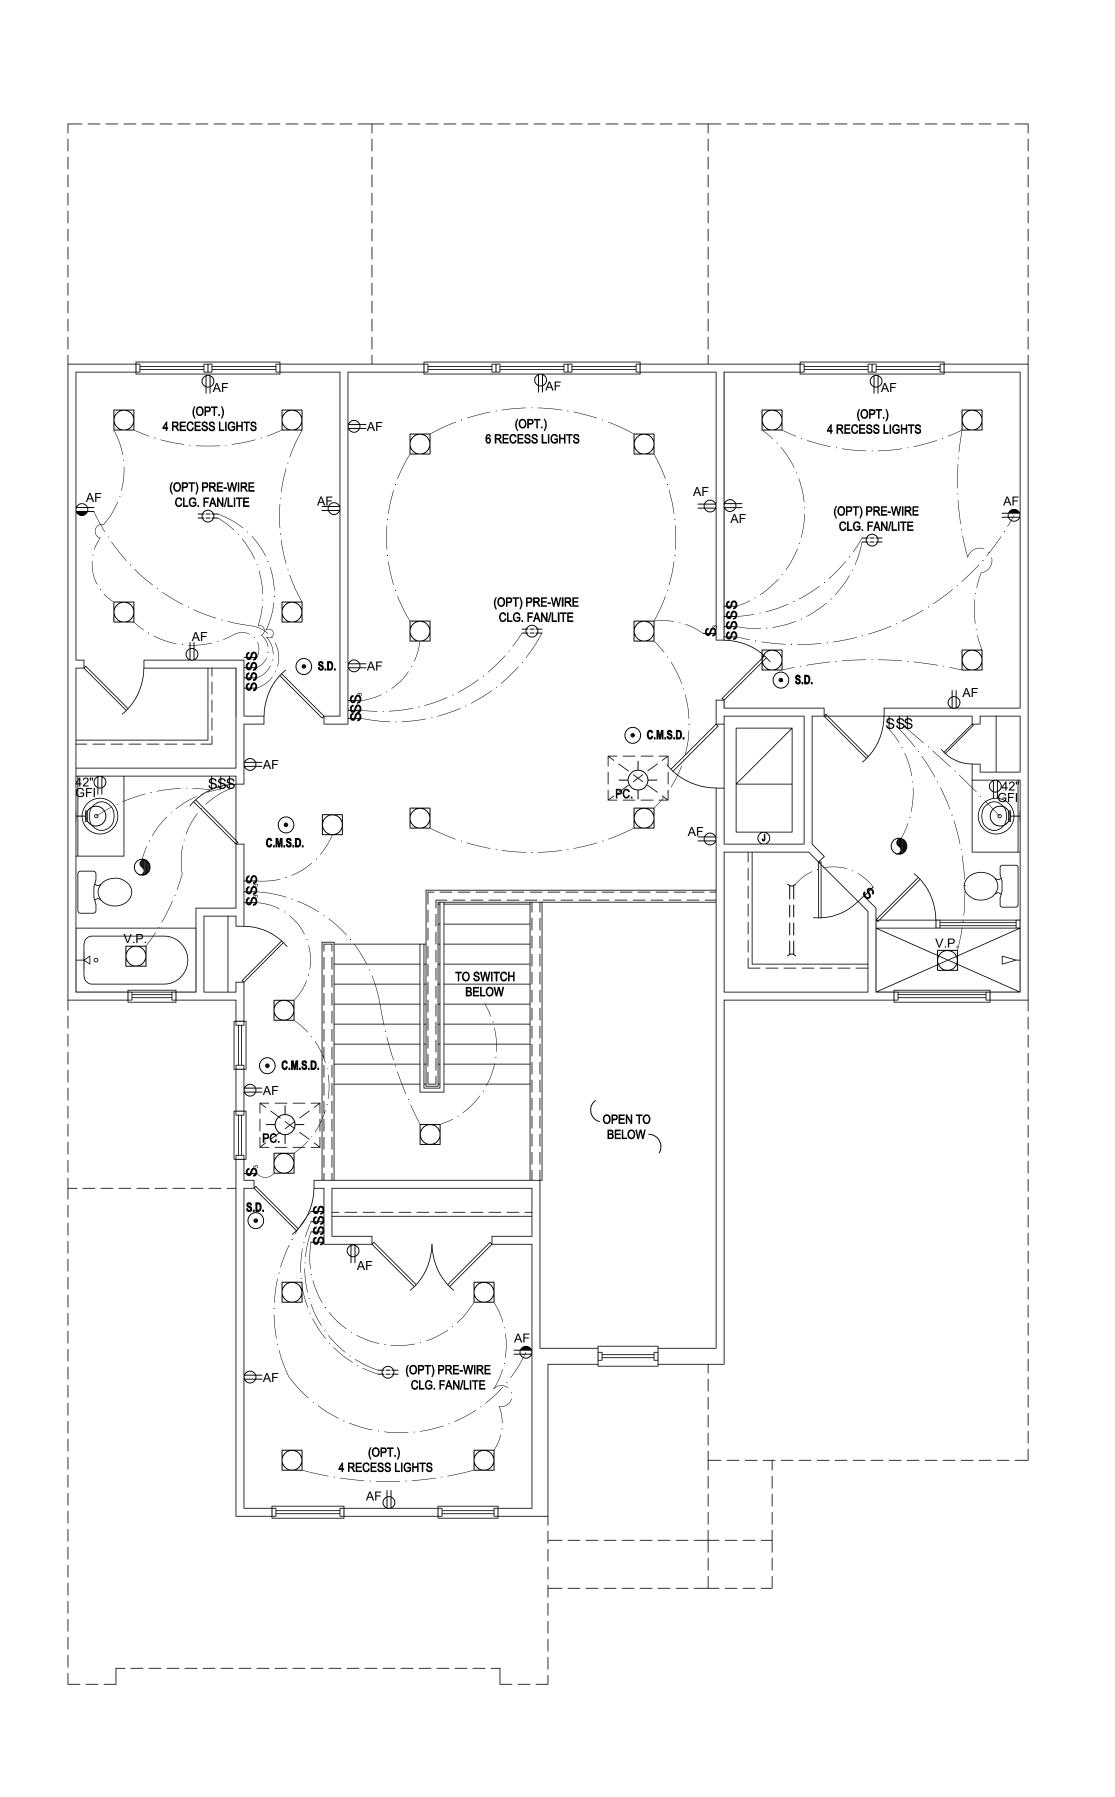

- ALL OUTLETS ARE TO BE AFCI PROTECTED.
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- ALL 15A AND 20A 120V BRANCH CIRCUITS LOCATED IN THE

BUILDER TO VERIFY EXACT LOCATION OF FLOOR OUTLETS

- ARE TO BE GFCI PROTECTED.
- EXCEPTIONS TO THE GFCI STIPULATION WILL BE ALLOWED


- O. OUTLETS LOCATED WITHIN 6'-0" OF A WET AREA ARE TO BE
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-\rightarrow_PC	PULL CHAIN LIGHT
	FLUSH-MOUNT LED
\vdash	WALL MOUNTED LIGHT
	WALL WASH RECESSED
\oplus	DUPLEX RECEPTACLE
#	220 V RECEPTACLE
	1/2 HOT, 1/2 SWITCHED
₩P	WATER PROOF RECEPTACLE
	FLOOR RECEPTACLE
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⊕ _{GFI}	GROUND FAULT INTERRUPT
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\$ ₃	3-WAY SWITCH
\$₀	DIMMER SWITCH
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\leftarrow	CABLE JACK
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	FLUORESCENT LIGHT
	ELECTRICAL PANEL
00	CHIME
Η•	DOOR BELL / GARAGE DOOR SWITCH
	DISCONNECT SWITCH
M	ELECTRICAL METER
●S.D.	SMOKE DETECTOR
• C.M.S.D.	CARBON MONOXIDE / SMOKE DETECTOR
	CEILING FAN
	WALL SCONCE
ogo	CHANDELIER
44	SPOT LIGHT
	FLUSH MOUNT FLUORESCENT LIGHT
	FAN / LIGHT COMBINATION
Ø	GARBAGE DISPOSAL MOTOR
(S)	SPEAKER

Second Floor Electrical Plan "B"


(Standard)

SCALE: 1/8" = 1'-0" (11x17) 1/4" = 1'-0" (22x34)



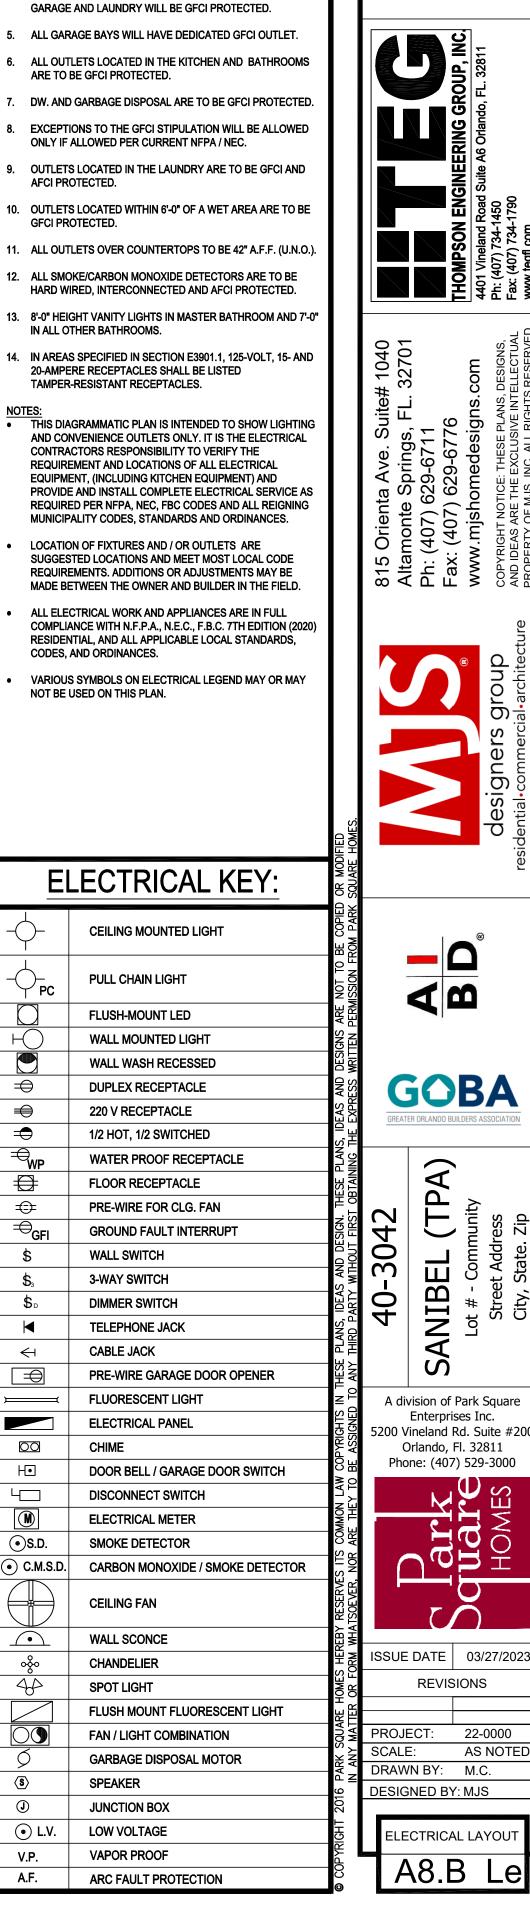

5200 Vineland Rd. Suite #200

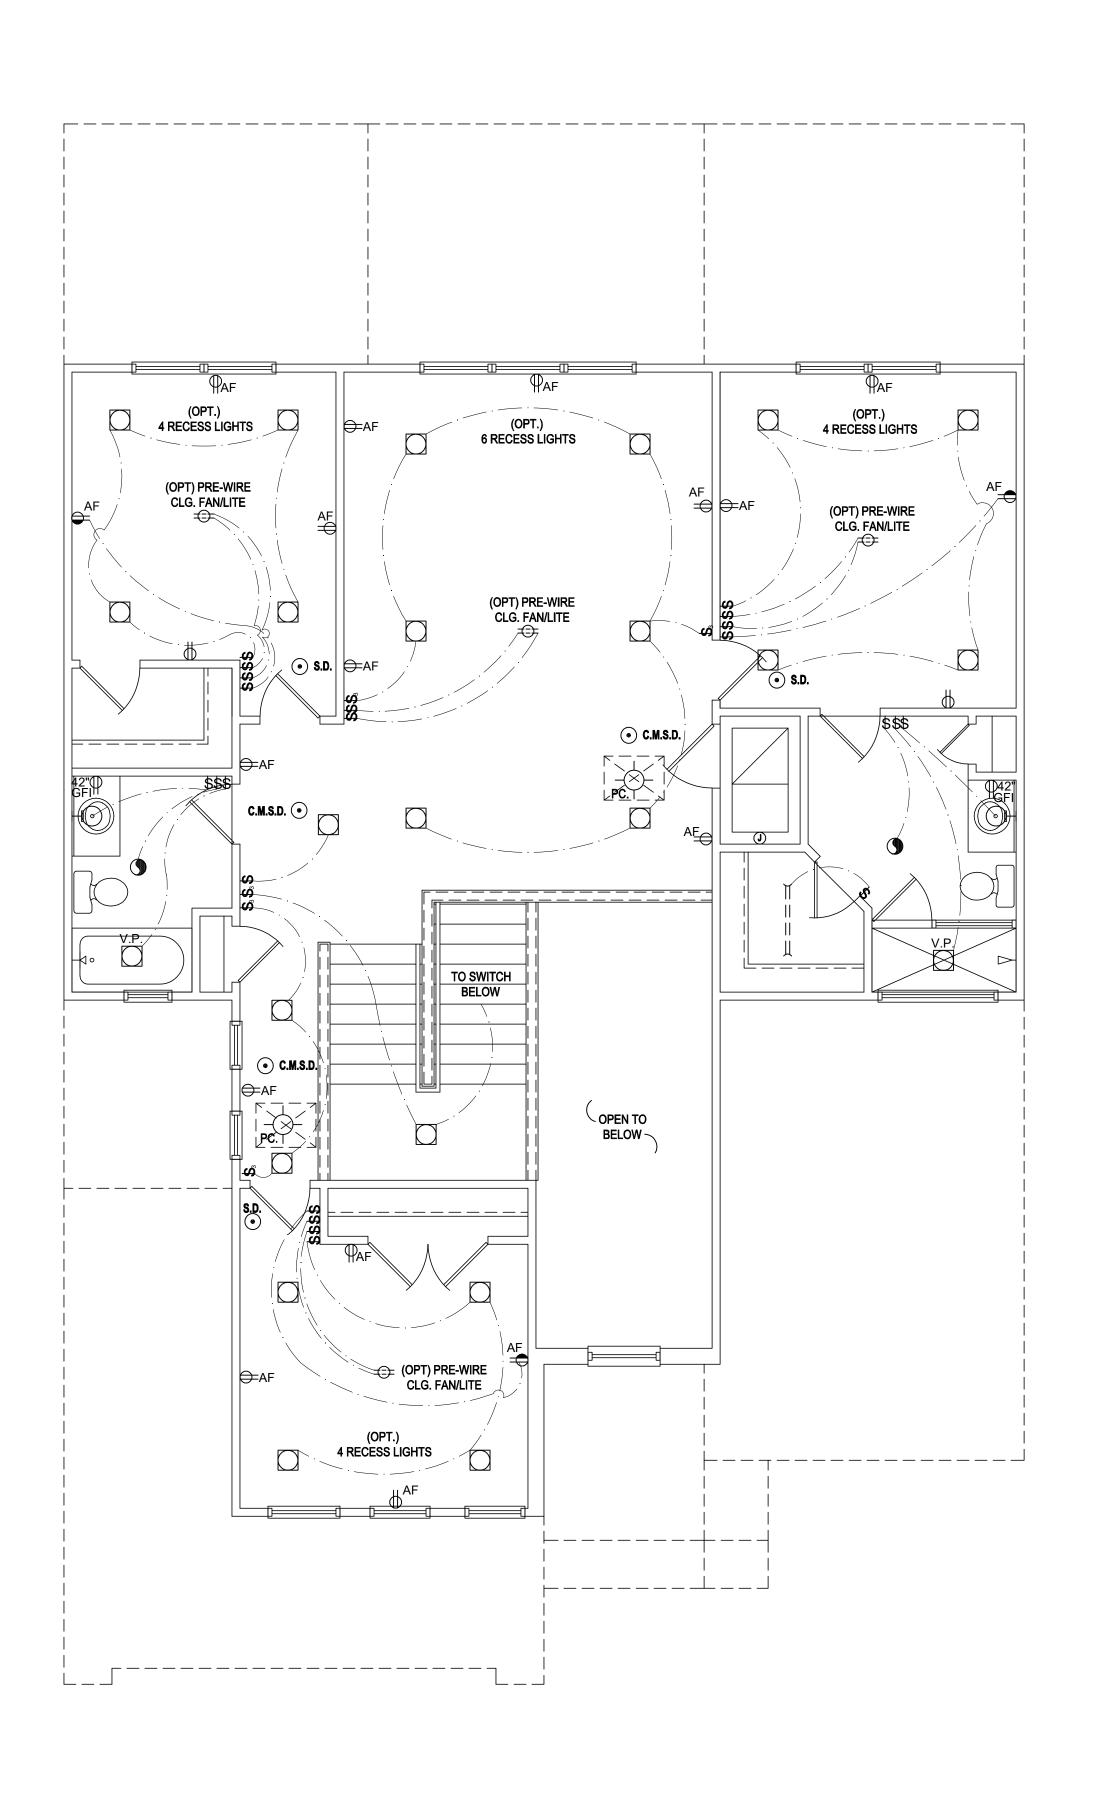

BUILDER TO VERIFY EXACT LOCATION OF FLOOR OUTLETS

- IN FIELD.
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 - ALL 15A AND 20A 120V BRANCH CIRCUITS WILL BE AFCI PROTECTED.
 - 4. ALL 15A AND 20A 120V BRANCH CIRCUITS LOCATED IN THE
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 - ALL OUTLETS LOCATED IN THE KITCHEN AND BATHROOMS
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DW. AND GARBAGE DISPOSAL ARE TO BE GFCI PROTECTED.

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- AFGI PROTECTED.
- OUTLETS LOCATED WITHIN 6'-0" OF A WET AREA ARE TO BE GFCI PROTECTED.
- 11. ALL OUTLETS OVER COUNTERTOPS TO BE 42" A.F.F. (U.N.O.).
- 12. ALL SMOKE/CARBON MONOXIDE DETECTORS ARE TO BE HARD WIRED, INTERCONNECTED AND AFCI PROTECTED.
- 13. 8'-0" HEIGHT VANITY LIGHTS IN MASTER BATHROOM AND 7'-0' IN ALL OTHER BATHROOMS.
- 14. IN AREAS SPECIFIED IN SECTION E3901.1, 125-VOLT, 15- AND 20-AMPERE RECEPTACLES SHALL BE LISTED
- TAMPER-RESISTANT RECEPTACLES.
- THIS DIAGRAMMATIC PLAN IS INTENDED TO SHOW LIGHTING AND CONVENIENCE OUTLETS ONLY. IT IS THE ELECTRICAL CONTRACTORS RESPONSIBILITY TO VERIFY THE REQUIREMENT AND LOCATIONS OF ALL ELECTRICAL EQUIPMENT, (INCLUDING KITCHEN EQUIPMENT) AND PROVIDE AND INSTALL COMPLETE ELECTRICAL SERVICE AS REQUIRED PER NFPA, NEC, FBC CODES AND ALL REIGNING MUNICIPALITY CODES, STANDARDS AND ORDINANCES.
- LOCATION OF FIXTURES AND / OR OUTLETS ARE SUGGESTED LOCATIONS AND MEET MOST LOCAL CODE REQUIREMENTS. ADDITIONS OR ADJUSTMENTS MAY BE MADE BETWEEN THE OWNER AND BUILDER IN THE FIELD.
- ALL ELECTRICAL WORK AND APPLIANCES ARE IN FULL COMPLIANCE WITH N.F.P.A., N.E.C., F.B.C. 7TH EDITION (2020) RESIDENTIAL, AND ALL APPLICABLE LOCAL STANDARDS, CODES, AND ORDINANCES.
- VARIOUS SYMBOLS ON ELECTRICAL LEGEND MAY OR MAY NOT BE USED ON THIS PLAN.

ELECTRICAL KEY:

CEILING MOUNTED LIGHT

-\rightarrow_PC	PULL CHAIN LIGHT
	FLUSH-MOUNT LED
\vdash	WALL MOUNTED LIGHT
	WALL WASH RECESSED
$\overline{\oplus}$	DUPLEX RECEPTACLE
=	220 V RECEPTACLE
	1/2 HOT, 1/2 SWITCHED
₩P	WATER PROOF RECEPTACLE
	FLOOR RECEPTACLE
	PRE-WIRE FOR CLG. FAN
\Rightarrow_{GFI}	GROUND FAULT INTERRUPT
\$	WALL SWITCH
\$ ₃	3-WAY SWITCH
\$₀	DIMMER SWITCH
M	TELEPHONE JACK
\leftarrow	CABLE JACK
\Box	PRE-WIRE GARAGE DOOR OPENER
	FLUORESCENT LIGHT
	ELECTRICAL PANEL
00	CHIME
H•	DOOR BELL / GARAGE DOOR SWITCH
4	DISCONNECT SWITCH
M	ELECTRICAL METER
●S.D.	SMOKE DETECTOR
• C.M.S.D.	CARBON MONOXIDE / SMOKE DETECTOR
	CEILING FAN
	WALL SCONCE
o	CHANDELIER
44	SPOT LIGHT
	FLUSH MOUNT FLUORESCENT LIGHT
	FAN / LIGHT COMBINATION
\bigcirc	GARBAGE DISPOSAL MOTOR
(S)	SPEAKER

JUNCTION BOX

LOW VOLTAGE

VAPOR PROOF

ARC FAULT PROTECTION

• L.V.



ELECTRICAL LAYOUT

A8.C Le

Second Floor Electrical Plan "C" (Standard)

